


2280 ELDEN AVENUE APN 426-064-01 PLANNING APPLICATION v3

ATTACHMENT 6

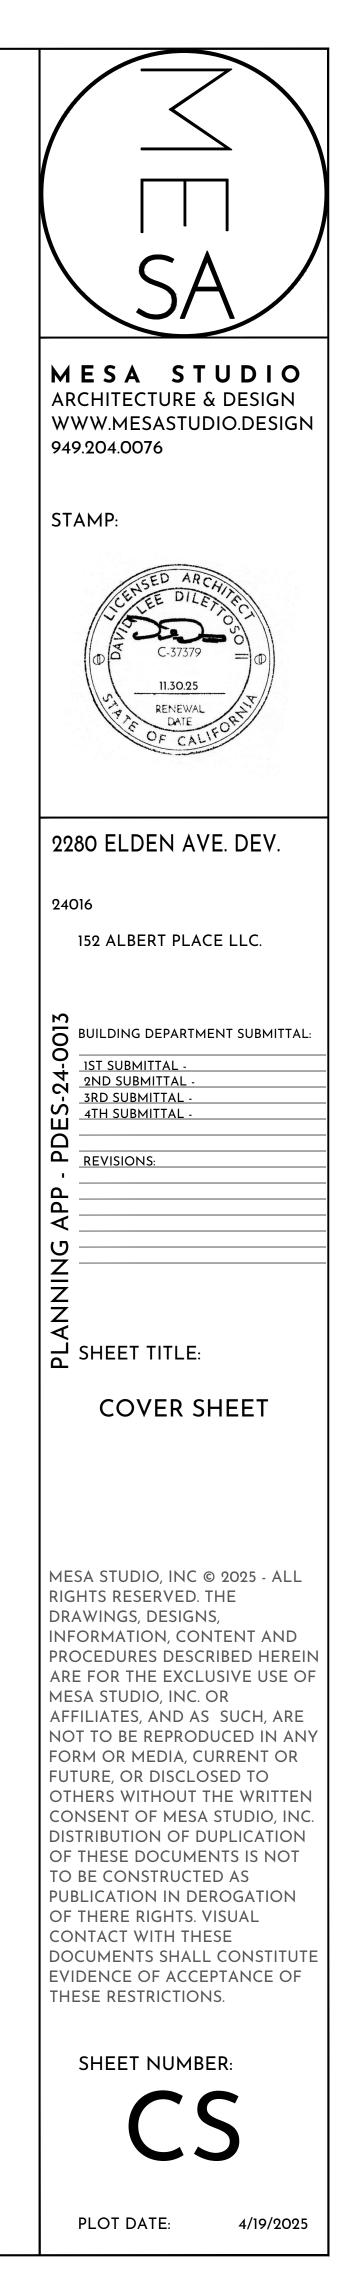

ABBREVIATIONS

INT

JAN

LAU

LAV

MAX

M.C.

MFR MIN

MISC

M.O.

MTD

MTL

MUL

N.I.C.

NO

NOM

N.T.S.

OA

O.H. OBS

O.C

OFF

OPP

PLAS

PNT

PR

P.T.

RAD

RECT

REF

REQ

RESIL

REV

R.O.

RWD

SH

SHT

SIM

SLP

SNK

SPEC

SQ

S.C.

S.S.D

STA

STD

STL

SUSP

SYM

T&G

T.B.

T.O.

T.P.

TYP

UNF

UR

VERT

VEST

w/o

W.C.

WD

WP

WΤ

W.I.

W.I.C.

WROUGHT IRON

WALK IN CLOSE

тнк

SW

RF

ANGLE CENTERLINE DIAMETER OR ROUND Ø A/C AIR CONDITIONING ABV ABOVE ACOUS ACOUSTICA ADJ ADJUSTABLE A.F.F. ABOVE FINISH FLOOR ALUM ALUMINUM ALTERNATE OR ALTERNATIVE ALT. APROX APPROXIMAT ARCH ARCHITECTURAL ASPH ASPHAL AW AWNING ΒA BATH BALC BALCON BD BOARD BED BEDROON BITUM BITUMINOL BLDG BUILDING BLKG BLOCKING BLW BELOW ΒM BEAM BOT BOTTOM CAB CABINET CEM **CEMEN1** CER CERAMIC CAST IRON C.I. CIRCLE OR CIRCULAR CIR CLG CEILING CLKG CAULKING CLR CLEAR C.M.U CONCRETE MASONRY UNIT COL COLUMN CONC CONCRETE CONN CONNECTION CONST CONSTRUCTION CONT CONTINUOUS C.R. CORROSION RESISTAN CSMT **CASEMEN** C.T. CERAMIC TILE CNTR CENTER CW COLD WATER DBL DOUBLE DEPT DEPARTMEN DTL DETAIL DH DOUBLE HUNG DIA DIAMETER DIM DIMENSIO DISP DISPENSE DK DECK DN DOWN DR DOOR DRN DRAIN DS DOWNSPOUT DWG DRAWING ELEC ELECTRICAL ELEV **ELEVATION** EMER EMERGENC ENCL ENCLOSURE EQ EQUAL EQPT EQUIPMEN EXIST EXISTING EXP EXPANSION EXPD EXPOSED EXT EXTERIOR F.H. FIRE ALARM F.E.C. FIRE EXTINGUISHER CABINET F.F. FINISH FLOOR FG FIXED GLASS FIN FINISH FLASH FLASHING FLR FLOOR FLUOR FLUORESCENT FND FOUNDATION F.O.C. FACE OF CONCRETE F.O.F. FACE OF FINISH F.O.S. FACE OF STUD FPRF FIREPROOF FR DR FRENCH DOOF FT FOOT OR FEET FTG FOOTING FURR FURRING GA GAUGE GALV GALVANIZED G.D.O GARAGE DOOR OPENER G.I. GALVANIZED IRON GLASS GL GND GROUND GR GRADE GYP GYPSUM H.B. HOSE BIBB H.C. HOLLOW CORE HD HEADER HDWD HARDWOOD HDW HARDWARE H.M. HOLLOW META HORIZ HORIZONTAL HR HOUR

нт

HEIGHT

INCH OR INCHES INSULATION INSUL INTERIOR JANITOR IOINT **KITCHEN** KITCH LAUNDRY LAVATORY LIGHT MAXIMUM MEDICINE CABINET MECH MECHANICAL MEMB MEMBRANE MANUFACTURER MINIMUM MISCELLANEOUS MASONRY OPENING MOUNTED METAL MULLION NOT IN CONTRACT NUMBER NOMINAL NOT TO SCALE OVER OVERALL OVERHANG OBSCURE ON CENTER OFFICE OPNG OPENING OPPOSITE PRCSTPRECAST PLATE PLASTER PLYWOOD PLYWD POINT PAIR PRESSURE TREATED RISER RADIUS RECTANGULAR REFERENCE REFER REFRIGERATOR REINF REINFORCED REQUIRED RESILIENT REVISION ROOF ROOM ROUGH OPENING REDWOOD SOLID CORE SCHED SCHEDULED SECT SECTION SINGLE HUNG SHWR SHOWER SHEET SHTG SHEATHING SIMILAR SLOPE SLDR SLIDER SINK SPECIFICATION SQUARE STAINLESS STEEL SEE STRUCTURAL DRAWING STATION STANDARD STEEL STOR STORAGE STAIR STR STRUCT STRUCTURAL SUSPENDED SOLID WOOD SYMMETRICAL TONGUE AND GROOVE TOWEL BAR TOP OF __ THICK T.O.C. TOP OF CURB TOILET PAPER HOLDER TREAD T.O.W. TOP OF WALL TYPICAL UNFINISHED UNLESS NOTED OTHERWISE U.N.O. URINAL VERTICAL VESTIBULE WITH WITHOUT WATER CLOSET WOOD WDW WINDOW WATERPROOF WSCT WAINSCOT WEIGHT

PROJECT DIRECTORY

CLIENT/OWNER 152 ALBERT LLC. 2100 E. LINDA LANE NEWPORT BEACH, CA 92660

ARCHITECT: MESA STUDIO ARCHITECTURE & DESIGN 2942 CENTURY PLACE - SUITE 785 COSTA MESA, CA 92626 CONTACT: DAVID DILETTOSO PHONE: 949.204.0076 EMAIL: HELLO@MESASTUDIO.DESIGN

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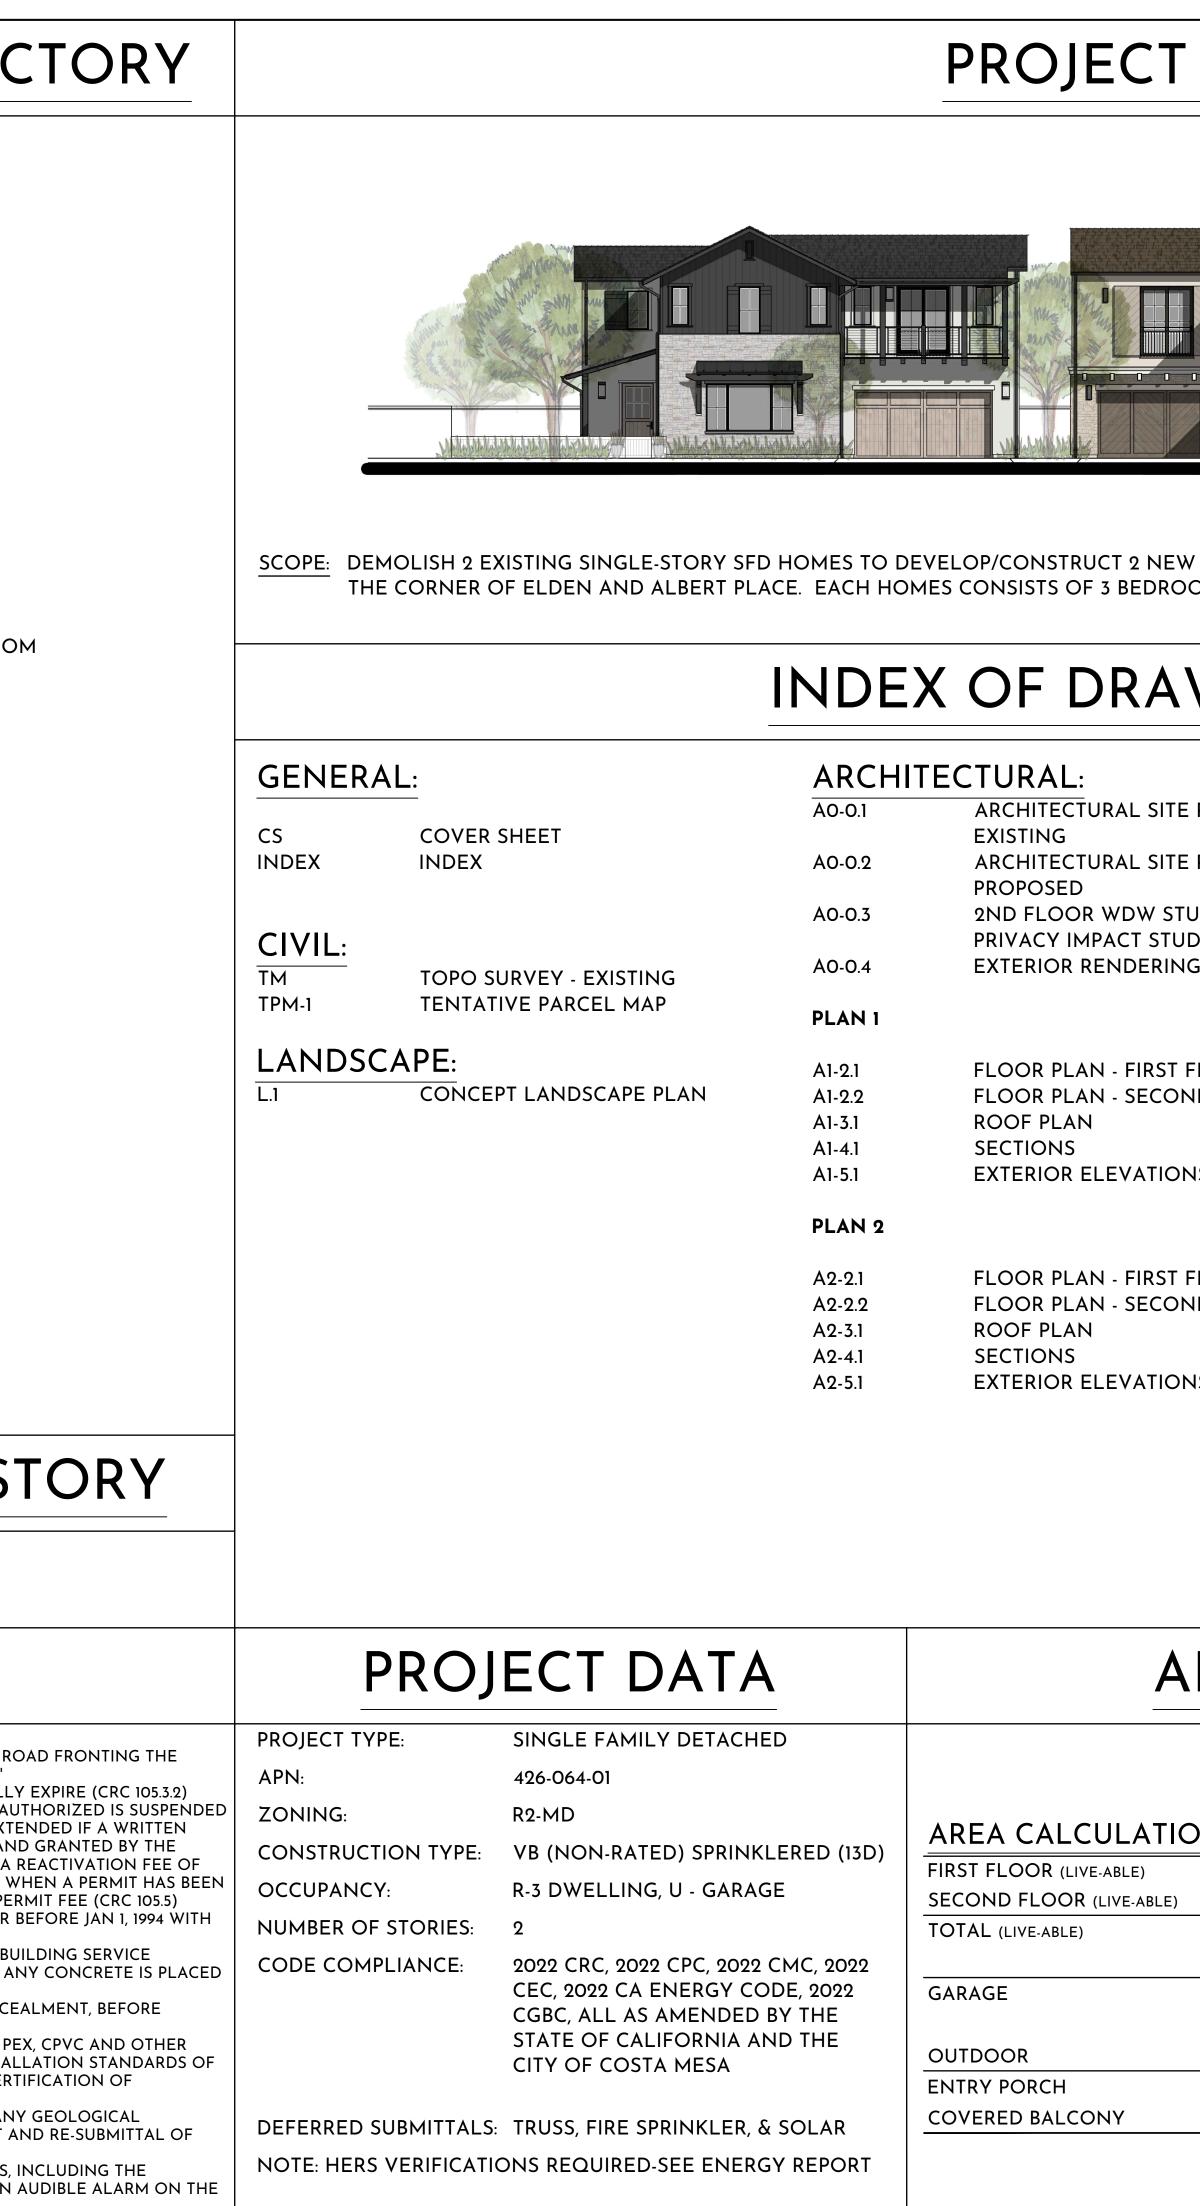
STRUCTURAL ENGINEER BORM INTERNATIONAL 2211 MICHELSON DR. SUITE #450 IRVINE, CA 92612 CONTACT: MASOUD BOKAIE PHONE: 949.264.7057

EMAIL: MASOUDB@BORM.COM **MEPE CONSULTANT:** GMEP ENGINEERS 26439 RANCHO PKWY S., SUITE 120 LAKE FOREST, CA 92630 CONTACT: JACK WEAVER PHONE: 949-267-9095 EXT-326 EMAIL: JACKW@GMEPE.COM


REVISION HISTORY

PROJECT NOTES

- BUILDING DESIGN IS BASED ON TYPE V CONVENTIONAL FRAMING PROVISIONS OF THE 2022 CRC (SEE STRUCTURAL PLANS) BUILDING SHALL HAVE ADDRESS NUMBERS PLACED IN A POSITION THAT IS PLAINLY LEGIBLE AND VISIBLE FROM THE STREET OR ROAD FRONTING THE PROPERTY w/ NUMBERS THAT CONTRAST WITH THE BACKGROUND AND ALPHABETICAL LETTERS A MIN. 4" w/ A MIN. STROKE OF 12" APPLICATIONS FOR WHICH NO PERMIT IS ISSUED WITHIN 180 DAYS FOLLOWING THE DATE OF APPLICATION SHALL AUTOMATICALLY EXPIRE (CRC 105.3.2) EVERY PERMIT ISSUED SHALL BECOME INVALID UNLESS WORK AUTHORIZED IS COMMENCED WITHIN 180 DAYS OR IF THE WORK AUTHORIZED IS SUSPENDED OR ABANDON FOR A PERIOD OF 180 DAYS. A SUCCESSFUL INSPECTION MUST BE OBTAINED WITHIN 180 DAYS. A PERMIT MAY BE EXTENDED IF A WRITTEN REQUEST STATING JUSTIFICATION FOR EXTENSION AND AN EXTENSION FEE IS RECEIVED PRIOR TO EXPIRATION OF THE PERMIT AND GRANTED BY THE BUILDING OFFICIAL. NO MORE THAN ONE (1) EXTENSION MAY BE GRANTED. PERMITS WHICH HAVE BECOME INVALID SHALL PAY A REACTIVATION FEE OF APPROXIMATELY 50% OF THE ORIGINAL PERMIT FEE AMOUNT WHEN THE PERMIT HAS BEEN EXPIRED FOR UP TO SIX (6) MONTHS. WHEN A PERMIT HAS BEEN EXPIRED FOR A PERIOD IN EXCESS OF ONE (1) YEAR, THE REACTIVATION FEE SHALL BE APPROXIMATELY 100% OF THE ORIGINAL PERMIT FEE (CRC 105.5) EFFECTIVE JAN 1, 2014, SB 407 REQUIRES REPLACEMENT OF ALL NONCOMPLIANT PLUMBING FIXTURES IN PROPERTIES BUILT ON OR BEFORE JAN 1, 1994 WITH WATER-CONSERVING PLUMBING FIXTURES. CONCRETE SLAB AND UNDER-FLOOR INSPECTIONS SHALL BE MADE AFTER IN-SLAB OR UNDER-FLOOR REINFORCING STEEL AND BUILDING SERVICE
- EQUIPMENT, CONDUITS, PIPING OR OTHER ANCILLARY BUILDING TRADE PRODUCTS OR EQUIPMENT ARE INSTALLED, BUT BEFORE ANY CONCRETE IS PLACED OR FLOOR SHEATHING IS INSTALLED, INCLUDING THE SUBFLOOR. (R109.1.1.1) ROUGH INSPECTION OF PLUMBING, MECHANICAL, GAS AND ELECTRICAL SYSTEMS SHALL BE MADE PRIOR TO COVERING OR CONCEALMENT, BEFORE
- FIXTURES OR APPLIANCES ARE SET OR INSTALLED, AND PRIOR TO FRAMING INSPECTION. (R109.1.2) WATER PIPING MATERIALS WITHIN A BUILDING SHALL BE IN ACCORDANCE WITH SEC. 604.1 OF THE CALIFORNIA PLUMBING CODE. PEX, CPVC AND OTHER
- PLASTIC WATER PIPING SYSTEMS SHALL BE INSTALLED IN ACCORDANCE WITH THE REQUIREMENTS OF SEC. 604 OF THE CPC, INSTALLATION STANDARDS OF APPENDIX I OF THE CPC AND MANUFACTURERS RECOMMENDED INSTALLATION STANDARDS. CPVC WATER PIPING REQUIRES A CERTIFICATION OF COMPLIANCE AS SPECIFIED IN SEC 604.1.1 OF THE CPC PRIOR TO PERMIT ISSUANCE.
- THE STRUCTURE IS KNOWN TO BE LOCATED ENTIRELY ON UNDISTURBED NATIVE SOILS. IF THE BUILDING INSPECTOR SUSPECTS ANY GEOLOGICAL INSTABILITIES OR SUSPICIOUS FILL BASED UPON OBSERVATION OF FOUNDATION EXCAVATION, A SOILS OR GEOLOGICAL REPORT AND RE-SUBMITTAL OF PLANS SHALL BE REQUIRED TO VERIFY THAT THE SOILS REPORT RECOMMENDATIONS HAVE BEEN INCORPORATED. 10. COMPLY WITH NFPA 13D 11.2.3.1 WATERFLOW DEVICES - WHERE WATERFLOW DETECTION DEVICES ARE INSTALLED, THESE DEVICES, INCLUDING THE
- ASSOCIATED ALARM CIRCUITS, SHALL BE FLOW TESTED THROUGH THE INSPECTOR'S TEST CONNECTION AND SHALL RESULT IN AN AUDIBLE ALARM ON THE PREMISES.




SCOPE	
TWO-SOTRY SFD HOMES WITH ATTACHED 2-CAR GARAGES EACH AT OM, 2.5 BATHS, AND OFFICE SPACES.	ACHITECTURE & DESIGN WWW.MESASTUDIO.DESIGN 949.204.0076
E PLAN- E PLAN- UDY DY	2280 ELDEN AVE. DEV. 24016 152 ALBERT PLACE LLC.
G FLOOR ND FLOOR NS FLOOR ND FLOOR	BUILDING DEPARTMENT SUBMITTAL: IST SUBMITTAL - 2ND SUBMITTAL - 3RD SUBMITTAL - 4TH SUBMITTAL - REVISIONS: Image: sheet title:
NS NS - PLAN 1 AREA CALCULATIONS - PLAN 2	INDEX MESA STUDIO, INC © 2025 - ALL RIGHTS RESERVED. THE DRAWINGS, DESIGNS, INFORMATION, CONTENT AND PROCEDURES DESCRIBED HEREIN ARE FOR THE EXCLUSIVE USE OF MESA STUDIO, INC. OR AFFILIATES, AND AS SUCH, ARE NOT TO BE REPRODUCED IN ANY FORM OR MEDIA, CURRENT OR FUTURE, OR DISCLOSED TO OTHERS WITHOUT THE WRITTEN CONSENT OF MESA STUDIO, INC. DISTRIBUTION OF DUPLICATION OF THESE DOCUMENTS IS NOT
TREE FIRST FLOOR (LIVE-ABLE)835 SQ FT1,260 SQ FTSECOND FLOOR (LIVE-ABLE)1,329 SQ FT2,050 SQ FTTOTAL (LIVE-ABLE)2,164 SQ FT486 SQ FTGARAGE474 SQ FTOUTDOOROUTDOOR	TO BE CONSTRUCTED AS PUBLICATION IN DEROGATION OF THERE RIGHTS. VISUAL CONTACT WITH THESE DOCUMENTS SHALL CONSTITUTE EVIDENCE OF ACCEPTANCE OF THESE RESTRICTIONS.
86 SQ FT 107 SQ FT	PLOT DATE: 4/19/2025

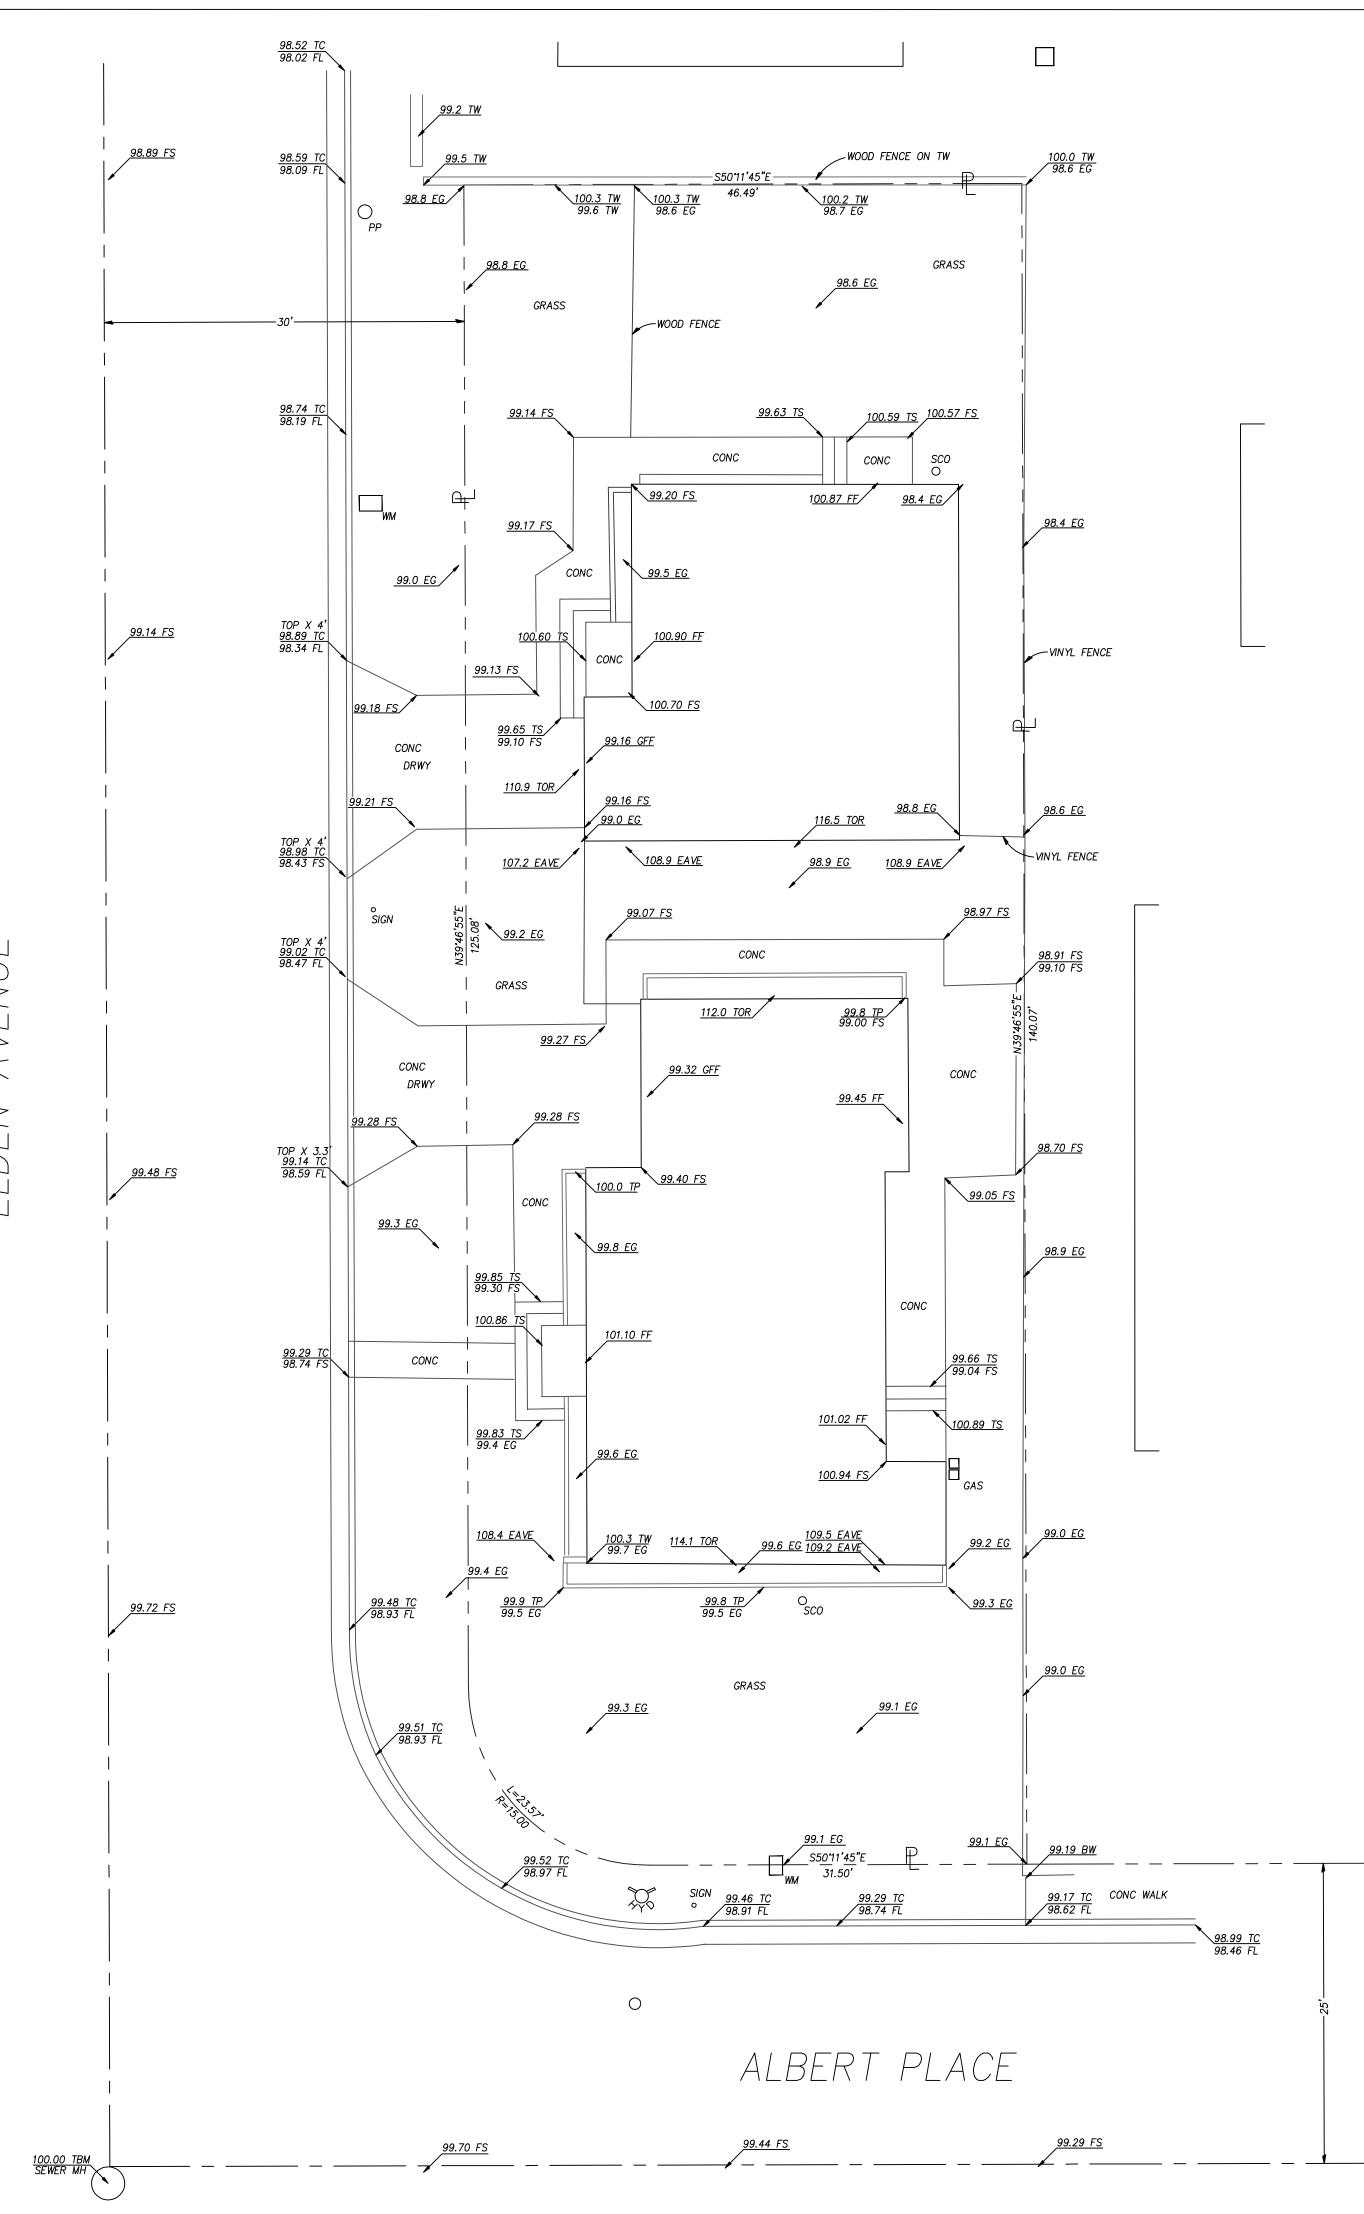

AVENUE \mathbb{Z} \square \mathbb{F}

BOUNDARY NOTE: THIS IS NOT A BOUNDARY SURVEY. THE TOPOGRAPHIC FEATURES AS SHOWN ON THIS MAP MAY BE ADJUSTED RELATIVE TO THE PLAT UPON COMPLETION OF A BOUNDARY SURVEY.

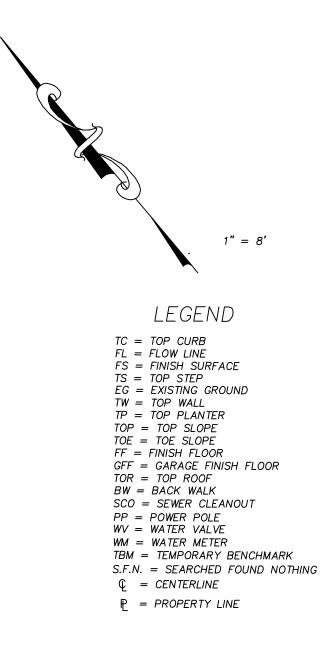



EASEMENT NOTE: THERE ARE NO PLOTTABLE EASEMENTS PER ORDR NO.: 24–151818 REF.NO.: 60–00588–CK


SEPTEMBER 2024

TOPOGRAPHIC MAP 8 SCALE APN: 426-064-01

152 ALBERT PLACE COSTA MESA CA.

ASSUMED DATUM = 100.00

SOUTH COAST SURVEYING 3214 CLAY ST. NEWPORT BEACH CA. (949)280-9957

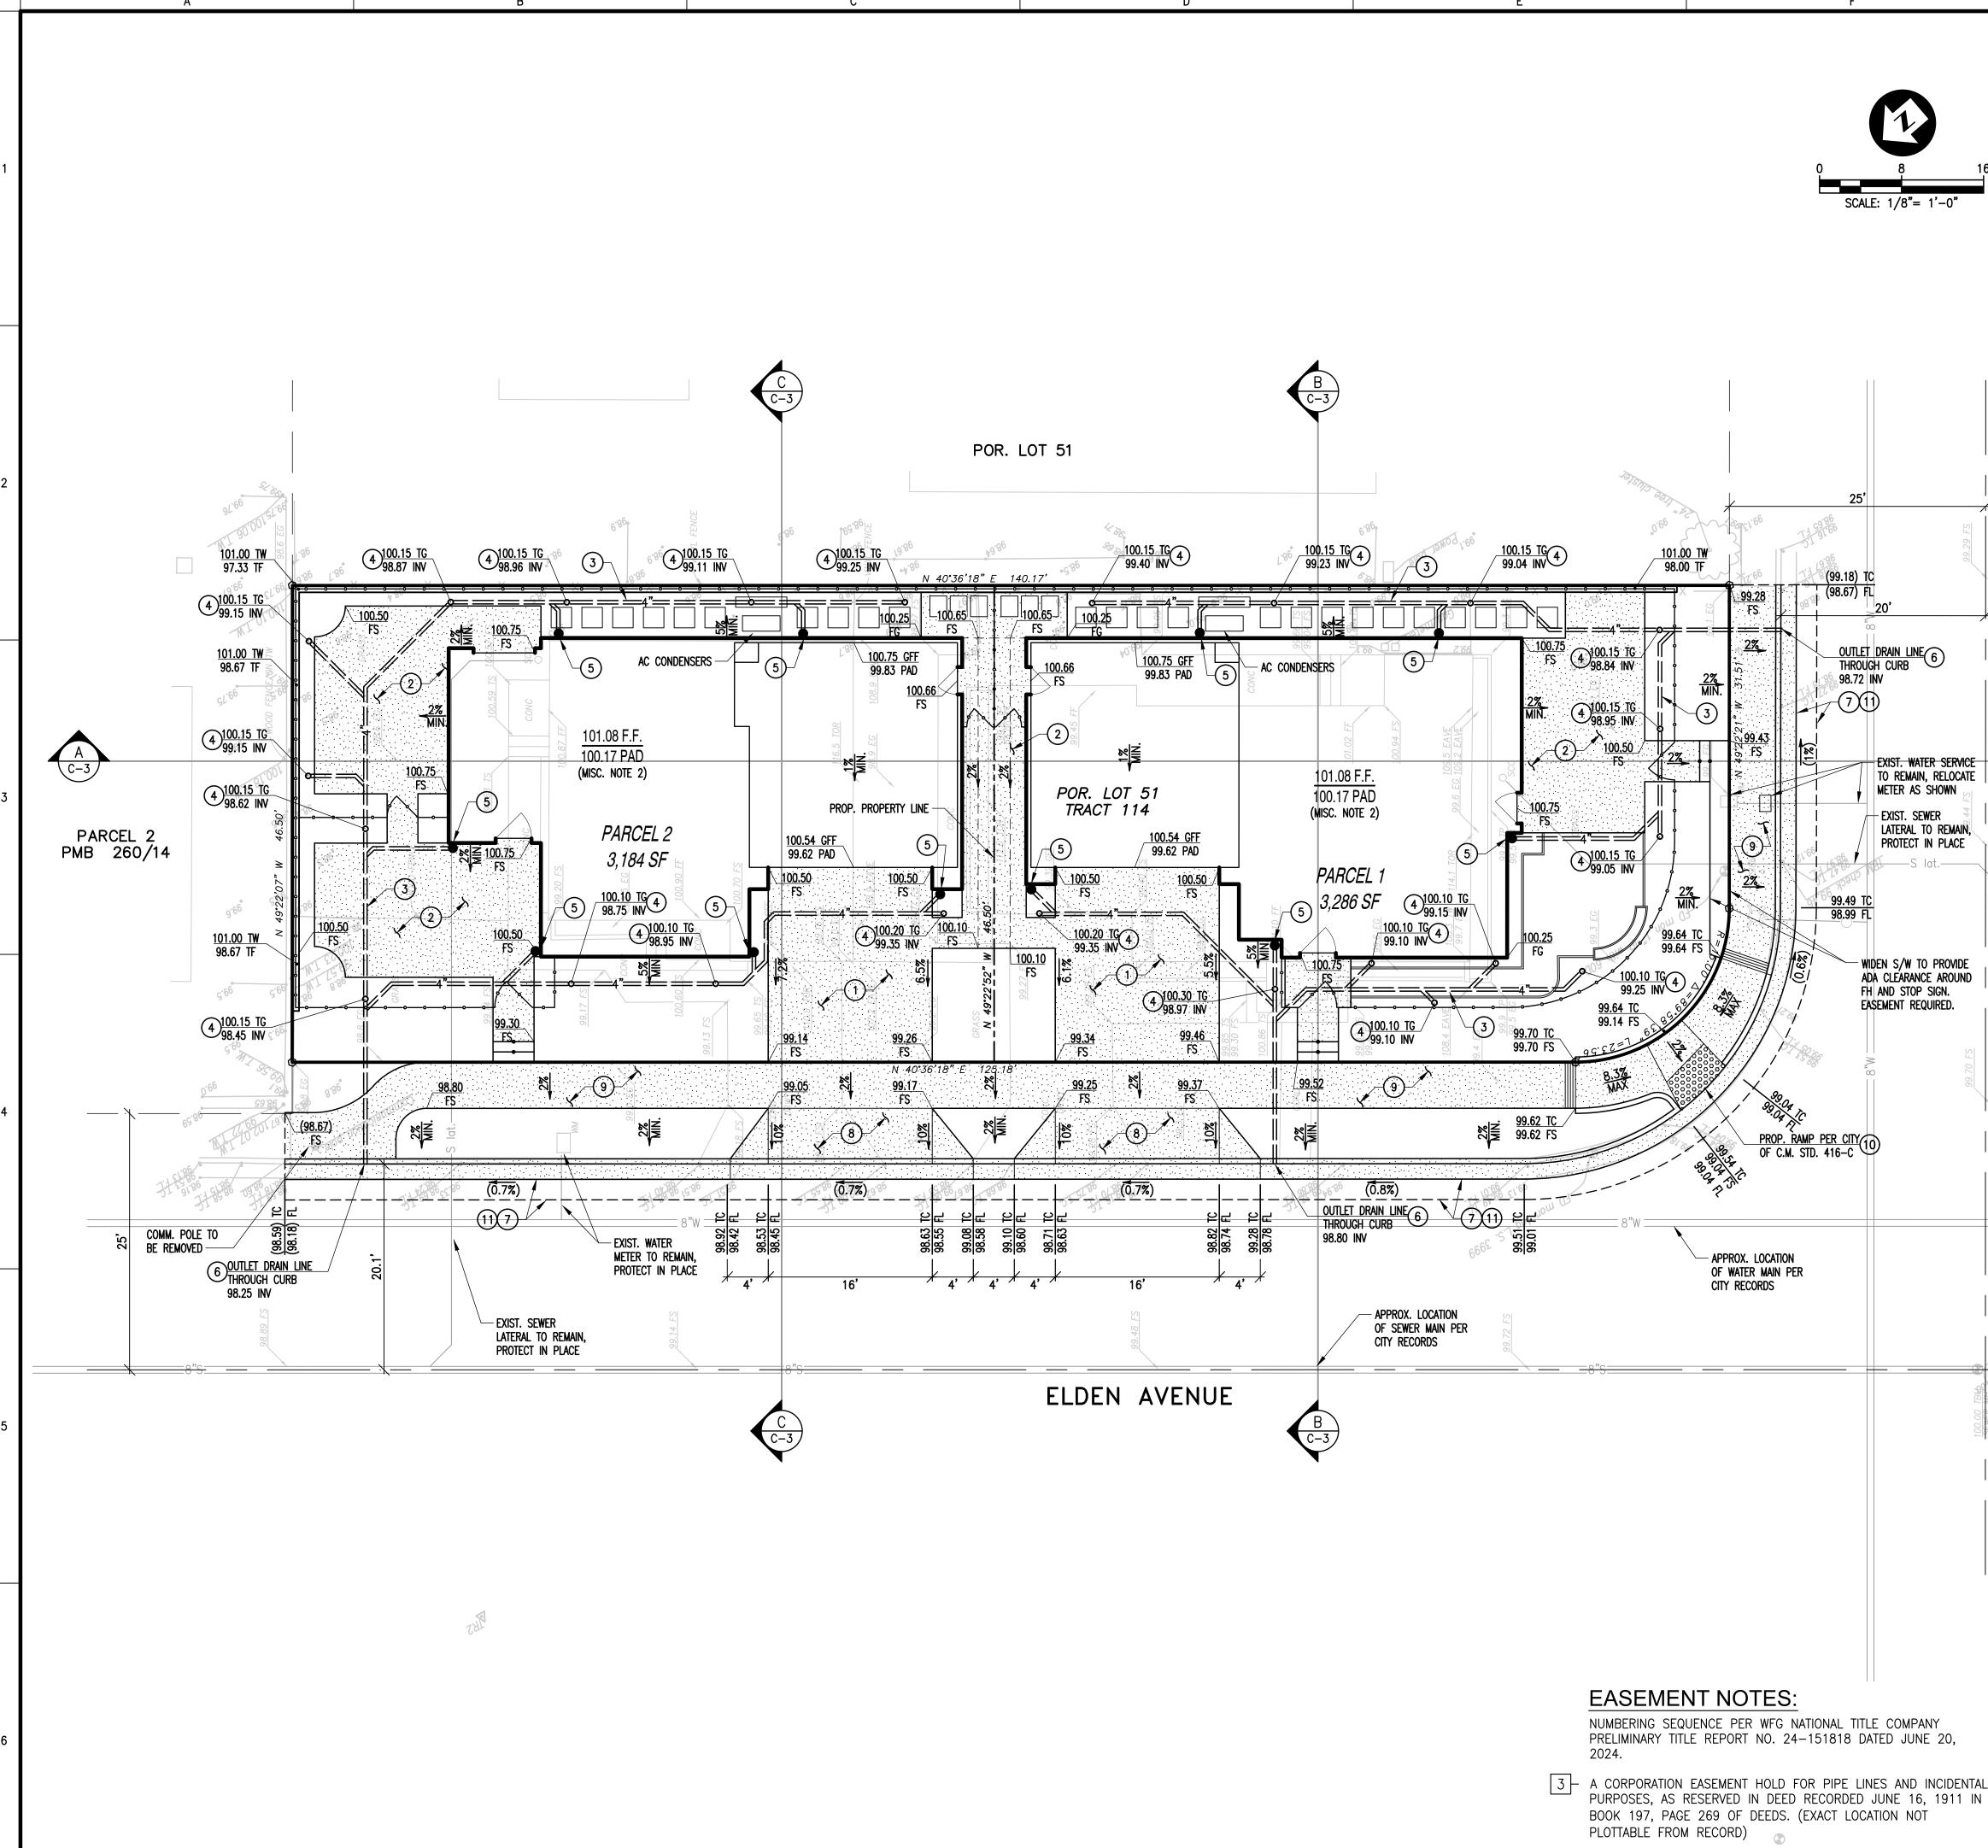


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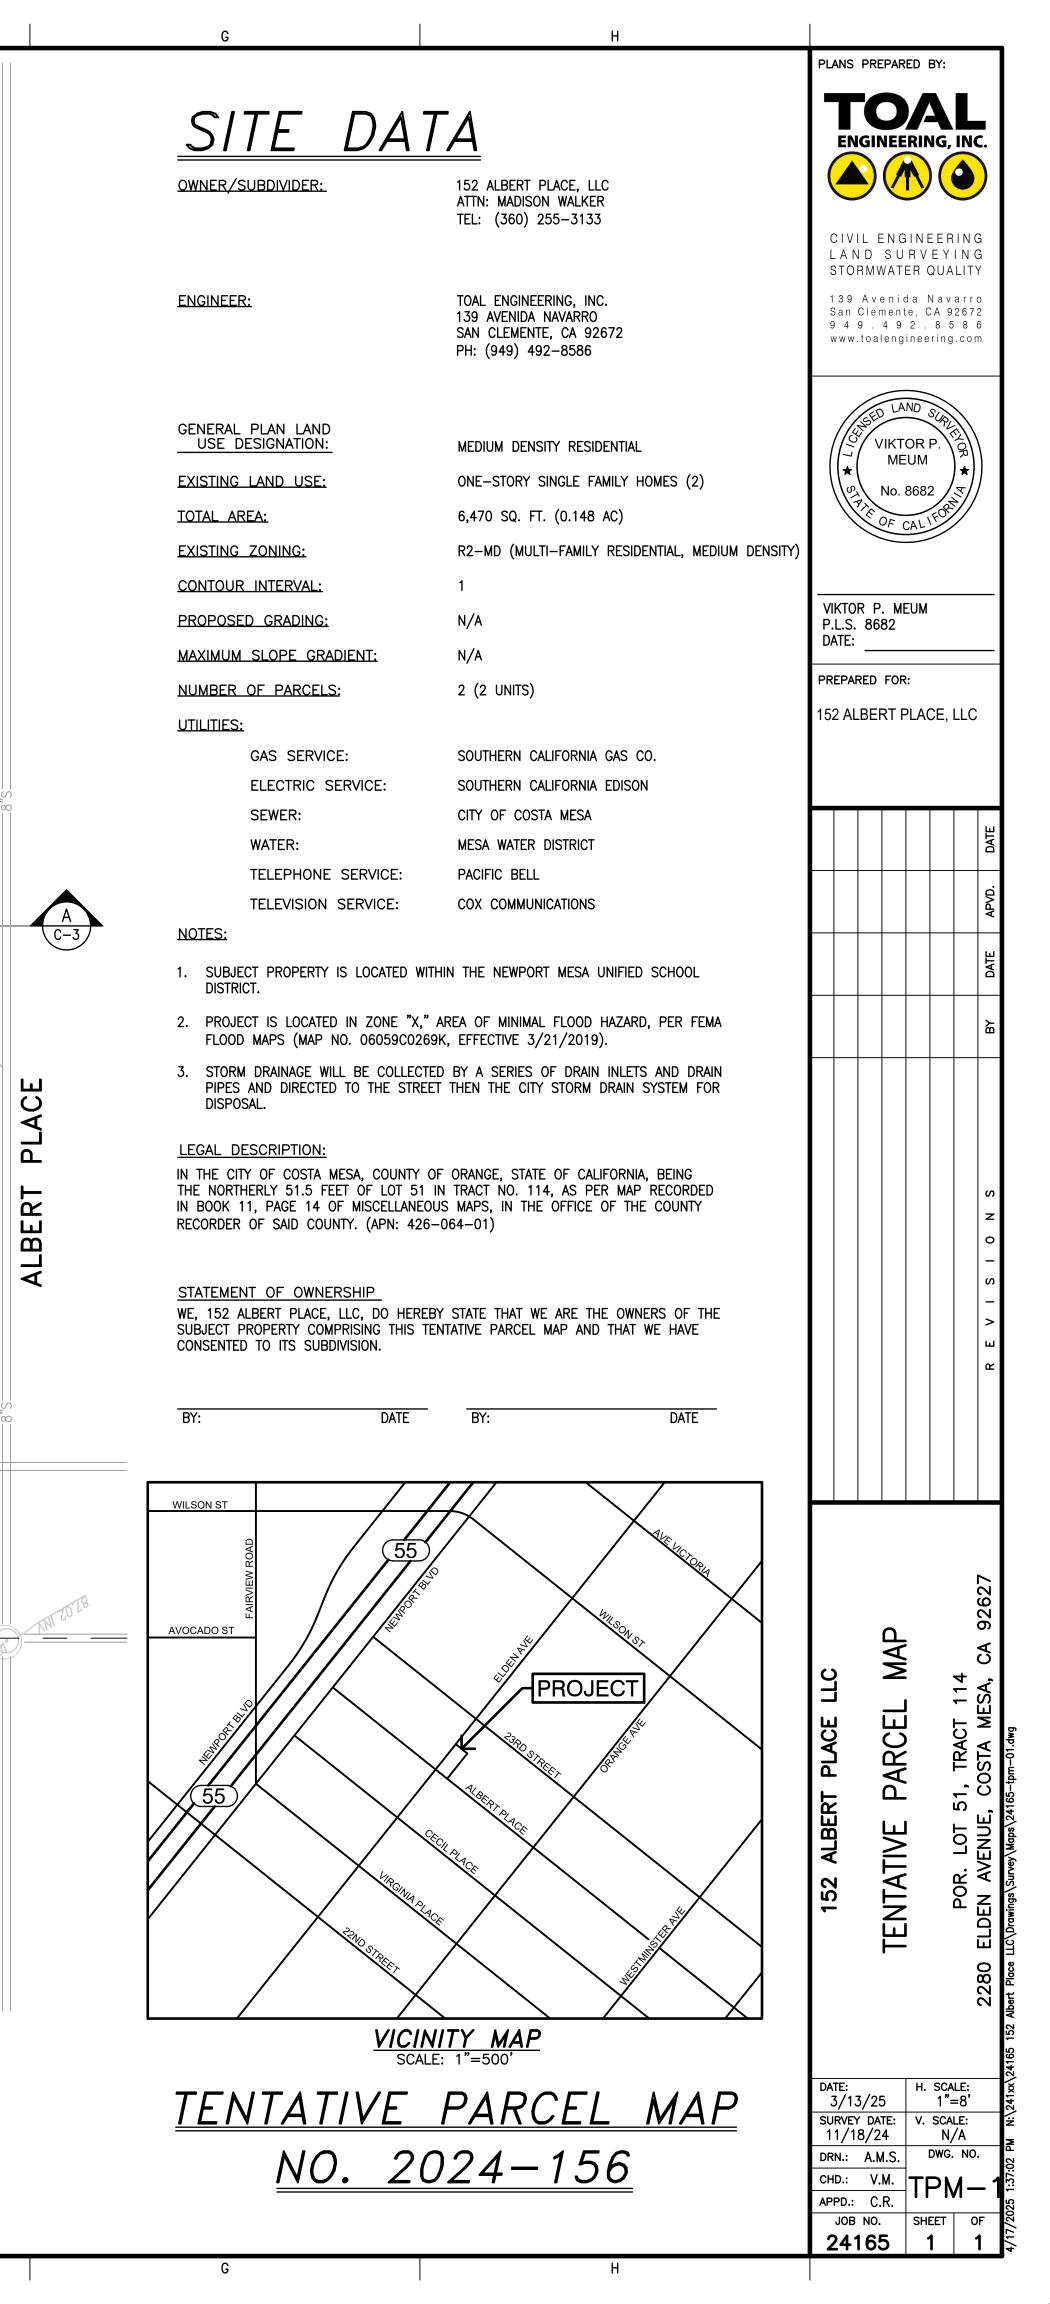
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-4-

E

D





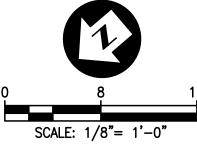

UNDER STORY PLANTING

2280 & 2286 ELDEN AVENUE

MARCH 12, 2024

COSTA MESA, CA

-5-

PRIVATE PATIO • CONCRETE PAVING

- ACCENT TREE
- MEDIUM SIZE
- SINGLE TRUNK
- PET RELIEF AREA NATURAL GRASS

PRIVATE RESIDENTIAL SIDE YARD ENTRY CONCRETE STEPS

LOW GATE

ACCENT TREE

 MEDIUM SIZE SINGLE TRUNK

LOW GARDEN FENCE

WOODEN HORIZONTAL RAIL (4)

PRIVATE YARD

 DECOMPOSED GRANITE WALKWAY • LANDSCAPE AREA (SHRUBS)

ACCENT TREE

 MEDIUM SIZE SINGLE TRUNK

LANDSCAPE PARKWAY

UNDER STORY PLANTING

SITE DESIGN REFERENCE CHART

PLANT CATEGORY	REQUIRED	PROVIDED
TREES		
TOTAL	9	9
EVERGREEEN	5	5
24" BOX +	4	
SHRUBS & GROUNDCOVER		
TOTAL	128	128
5 GALLON +	77	77
GROUNDCOVER	I,250 SF	I,250 SF
ΟΡΕΝΙ <u>SPACE</u> ΤΟΤΑΙ	C	

OPEN SPACE TOTALS TOTAL OPEN SPACE 3,186 SF I,785 SF TOTAL LANDSCAPE AREA

L.1 - CONCEPTUAL LANDSCAPE PLAN



Landscape Architecture | Planning | Design www.dsladesign.com 🔇 714.996.8040 O @dsladesign



2280 & 2286 ELDEN AVENUE COSTA MESA, CA

A	AGAVE ATTENUATA FOXTAIL AGAVE	5 GAL.	-	3	LOW	
C	CALLISTEMON 'LITTLE JOHN' DWARF BOTTLEBRUSH	5 GAL.	-	11	LOW	
D	DIANELLA REVOLUTA 'LITTLE REV' LITTLE REV FLAX LILY	I GAL.	-	68	LOW	
RO	ROSMARINUS OFFICINALIS PROSTRADA PROSTRATE ROSEMARY	I GAL.	-	14	LOW	
PE	PENNISETUM 'FAIRY TALES' FAIRY TALE FOUNTAIN GRASS	5 GAL.	-	15	LOW	
SG	SALVIA GREGGII AUTUMN SAGE	I GAL.	-	27	LOW	
S	SANSEVIERIA TRIFASCIATA SNAKE PLANT	5 GAL.	-	38	MED	
WF	WESTRINGIA FRUTICOSA GRAY BOX DWARF COAST ROSEMARY	5 GAL.	-	27	LOW	
GROUND	COVER/TURF:					
	MARATHON SOD	SOD	-	75 S/F	HIGH	
	SENECIO SERENS BLUE CHALK FINGERS	FLATS	PLANT 16 IN. O.C.	5	LOW	
┎╴┲╶┲╶┲╶┲ ┎╶┎╶┎╶┎╶┎ ┎╴┎╶┎╶┎╶	DYMONDIA MARGARETAE SILVER CARPET	FLATS	PLANT 12 IN. O.C.	8	LOW	
SHRED	DED WOOD MULCH (ALL SHRUB AREAS):					
ALL SHRUB AREAS	SHRUB COMPANY 714.283.2572 or APPROVED EOUAL - SUBMIT SAMPLES to L.A. for APPROVAL					

PLANTING LEGEND:

ARB MAR ARBUTUS MARINA HYBRID STRAWBERRY TREE

LAU NOB LAURUS 'SARATOGA' SARATOGA LAUREL


AGO FLE AGONIS FLEXUOSA AUSTRALIAN WILLOW

OLE EUR OLEA EUROPAEA 'SWAN HILL' SWAN HILL FRUITLESS OLIVE

SYMBOL NAME

TREES:

SHRUBS:

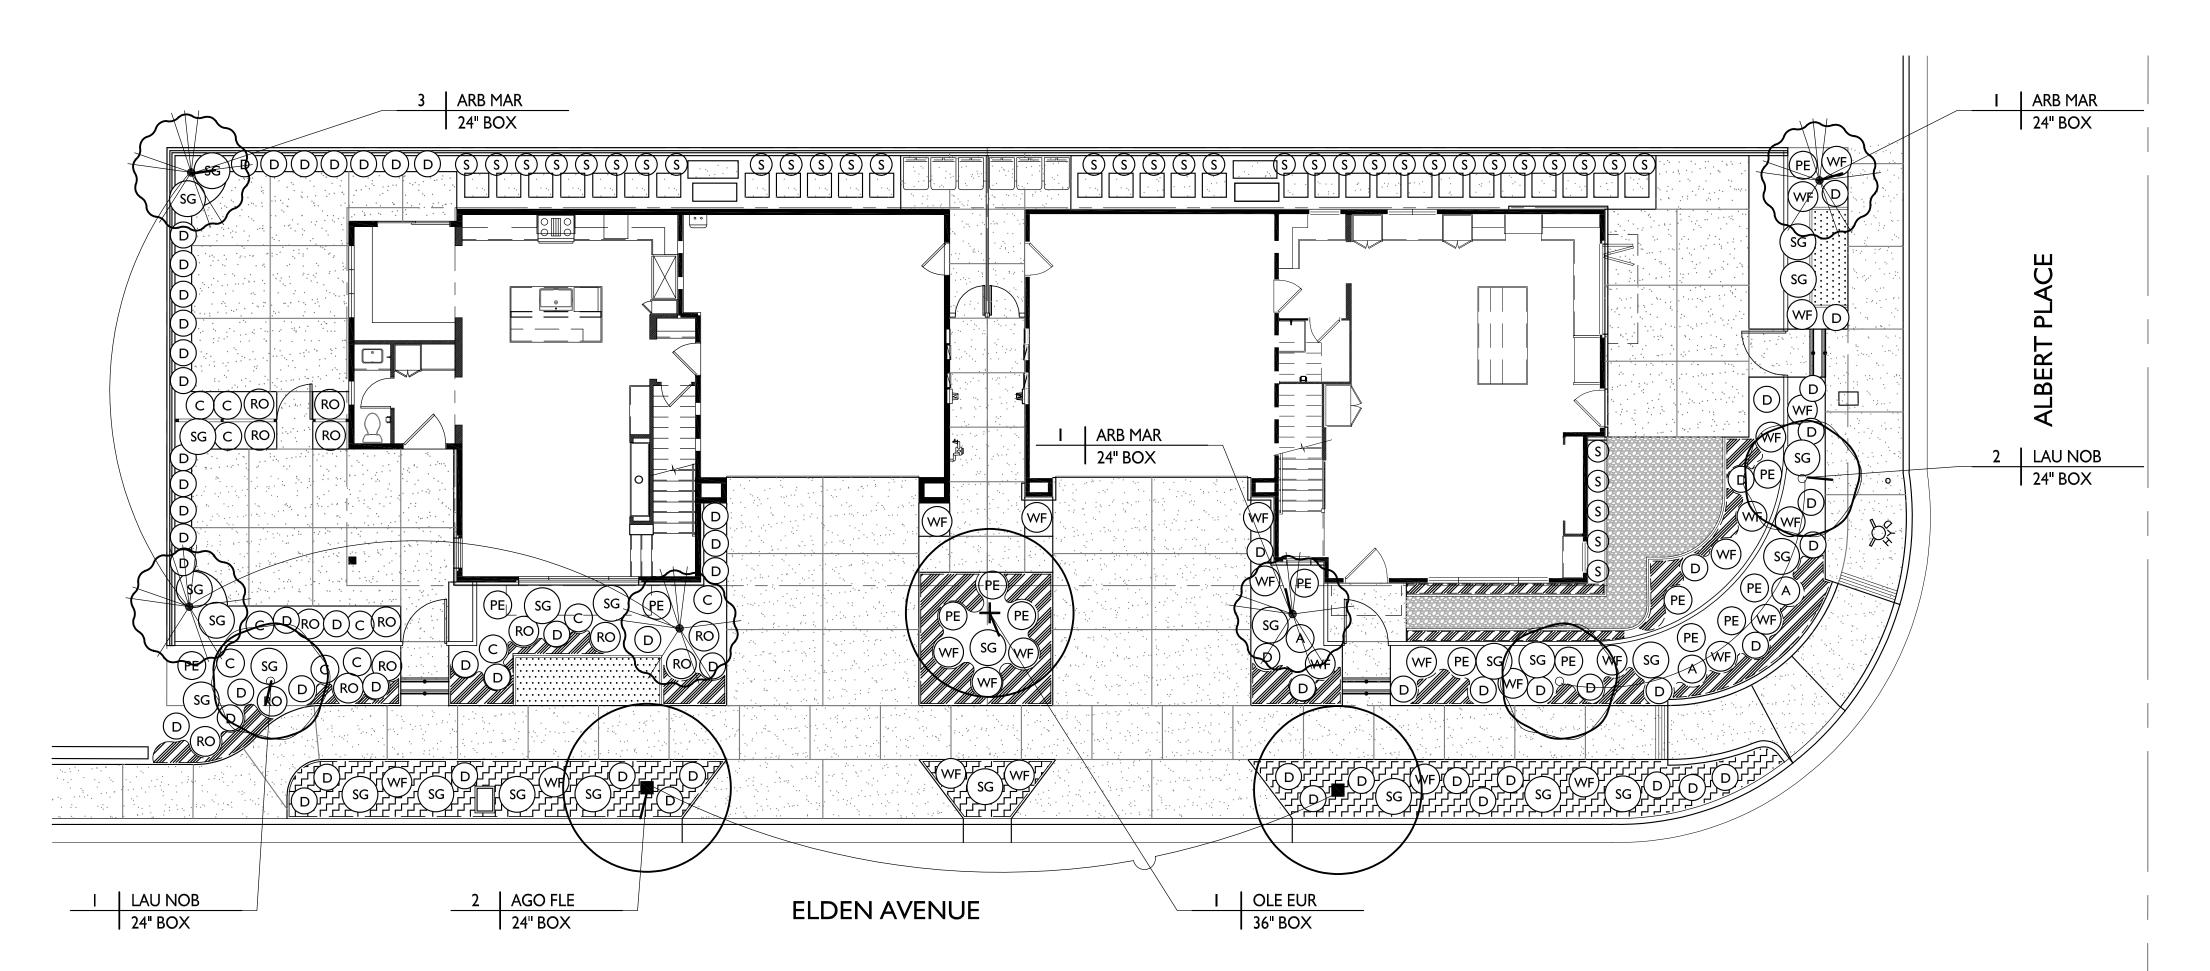

QTY	WUCOL'S
5	LOW
I	LOW
3	LOW
2	LOW
3	LOW
11	LOW
68	LOW
14	LOW
15	LOW
27	LOW
38	MED
27	LOW

SIZE COMMENTS

24" BOX STANDARD

24" BOX STANDARD

24" BOX STANDARD

24" BOX MULTI

GENERAL PLANTING NOTES:

- PRIOR TO ANY FINE GRADING OR PLANTING, CONTRACTOR SHALL REVIEW THE AGRONOMIC SOIL REPORTS AND SOIL AMENDMENT RECOMMENDATIONS PER SPECIFICATIONS, WHICH SHALL SUPERSEDE THOSE WITHIN THE SPECIFICATIONS.
- 2 LANDSCAPE ARCHITECT TO APPROVE ALL PLANT MATERIAL NOT LESS THAN I WEEK PRIOR TO ANTICIPATED DELIVERY DATE.
- 3 CONTRACTOR SHALL REMOVE ALL GROWER STAKES, TAGS AND RIBBONS.
- 4 LANDSCAPE CONTRACTOR SHALL MAINTAIN PROPER DRAINAGE AND DIRECT ALL WATER TO DRAINAGE INLETS SO AS TO PREVENT STANDING WATER.
- 5 THE LANDSCAPE CONTRACTOR SHALL MAINTAIN ALL PLANTED AREAS FOR A PERIOD OF 90 DAYS AFTER "START OF MAINTENANCE" PERIOD.
- 6 CONTRACTOR SHALL GUARANTEE SHRUBS FOR 6 MONTHS AND TREE AND PALM MATERIAL FOR 12 MONTHS (1 YEAR).
- 7 LANDSCAPE ARCHITECT SHALL APPROVE PLANT MATERIAL PLACEMENT PRIOR TO INSTALLATION.
- 8 NO TREES SHALL BE PLANTED CLOSER THAN 5' TO A BUILDING OR ROOF STRUCTURE. NO TREES SHALL BE PLANTED CLOSER THAN 5' TO PAVING OR FREESTANDING WALLS UNLESS DIRECTED BY THE LANDSCAPE ARCHITECT.
- 9 TREES OR PALMS SHALL NOT BE PLANTED WHERE FUTURE GROWTH WILL OBVIOUSLY CONFLICT WITH ROOF OVERHANGS.
- 10 TREES OR PALMS PLANTED IN LANDSCAPE AREAS OF LESS THAN 5' IN WIDTH SHALL BE INSTALLED WITH APPROVED ROOT BARRIERS.
- 11 ANY PLANTING SHOWN ON THE PLANS OR EXISTING IN THE FIELD THAT CONTRADICTS THESE CRITERIA IS TO BE BROUGHT TO THE ATTENTION OF THE LANDSCAPE ARCHITECT FOR RESOLUTION. FAILURE TO DO SO MAY RESULT IN THE CONTRACTOR TO REMOVE OR RELOCATE PLANT MATERIAL.


FOR PLANTING DETAILS SEE SHEET LP.2









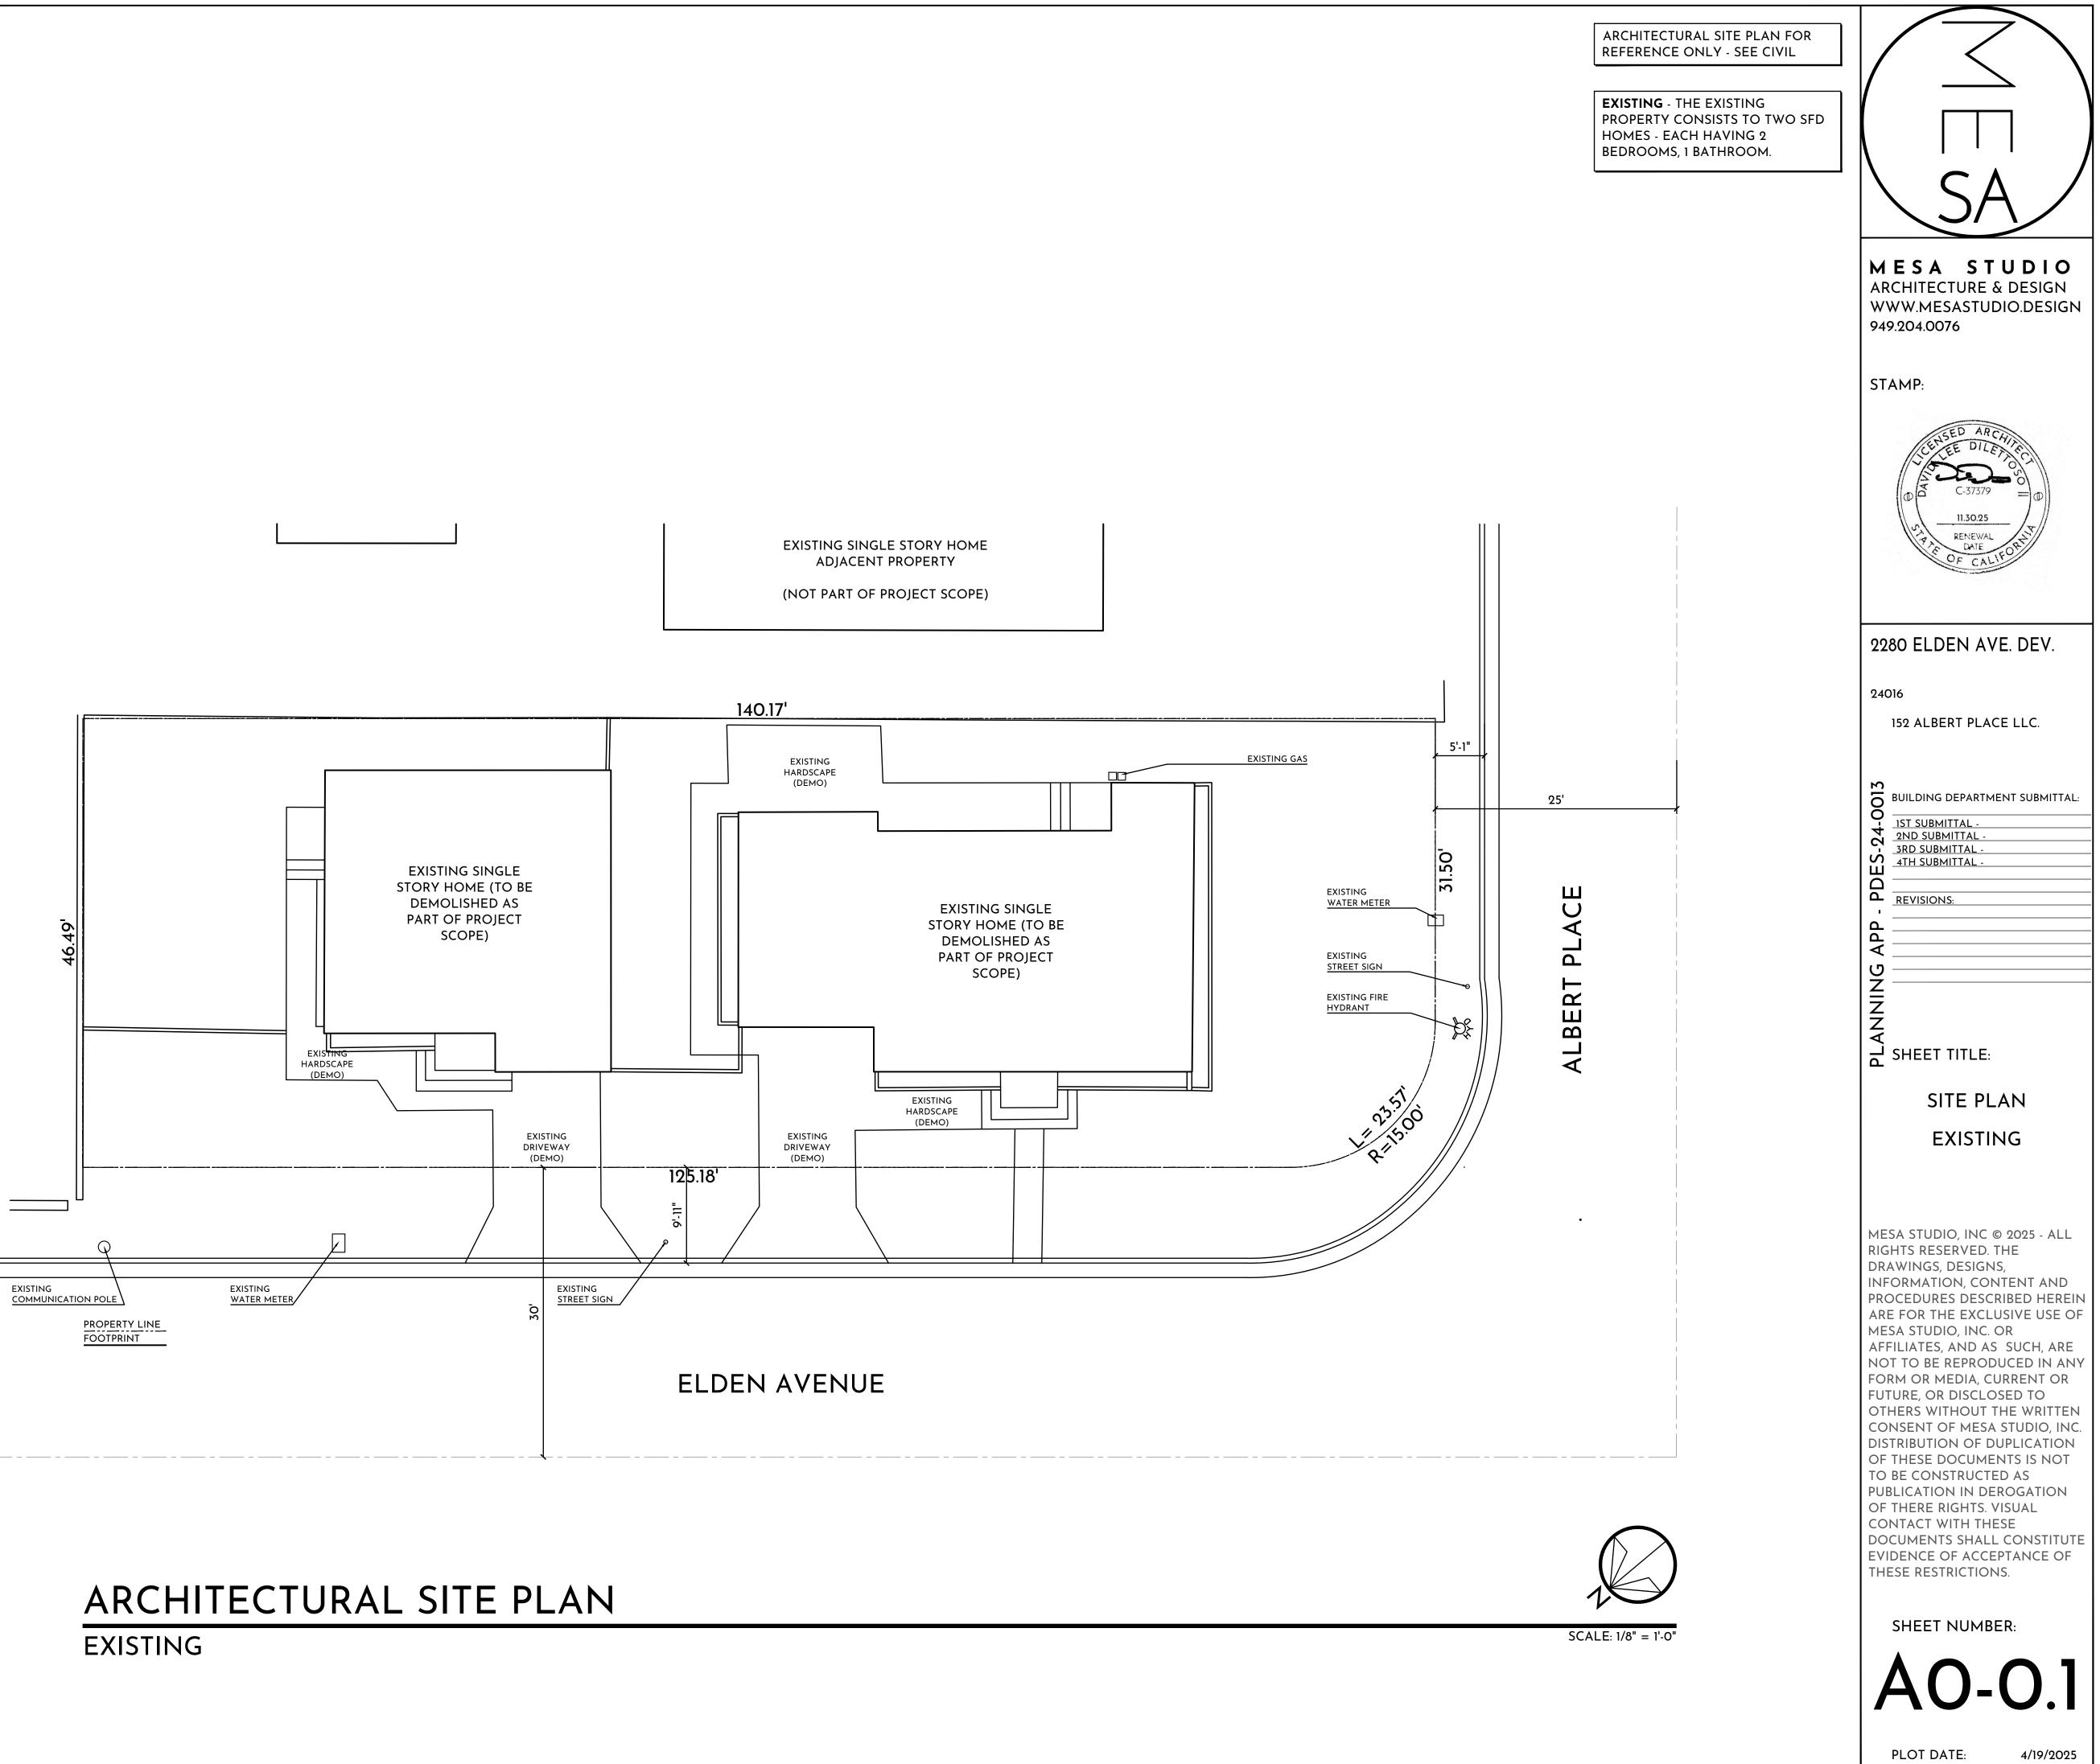



AREA CALCULATIO	NS - PL	AN 1		AR
FIRST FLOOR (LIVE-ABLE)	790 \$	SQ FT		FIRS
SECOND FLOOR (LIVE-ABLE)	1,260	SQ FT		SEC
TOTAL (LIVE-ABLE)	2,050	SQ FT		TOI
GARAGE	486 \$	SQ FT	-	GA
OUTDOOR				OU
ENTRY PORCH	86 \$	SQ FT		
COVERED BALCONY	107 3	SQ FT		

LOT INFORMATION (R2-MD ZONING):

OVERALL SITE AREA: 6,468 SQ. FT

SMALL LOT SUBDIVISION STANDARDS:


35% OPEN SPACE REQUIRED: 3,186 SQ. FT. PROVIDED

DEVOTED DRIVEWAY AREA: 304 SQ. FT. PROVIDED (EACH PLAN)

PARKING REQUIRED: 2 GARAGE SPACES AND 2 OPEN SPACES (DRIVEWAY)


SETBACKS: FRONT (ALBERT PLACE): 20' REAR: 15' SIDE (ELDEN): 10' (DRIVEWAY 19') SIDE YARD: 5'

DISTANCE BETWEEN BUILDINGS: 6' MINIMUM

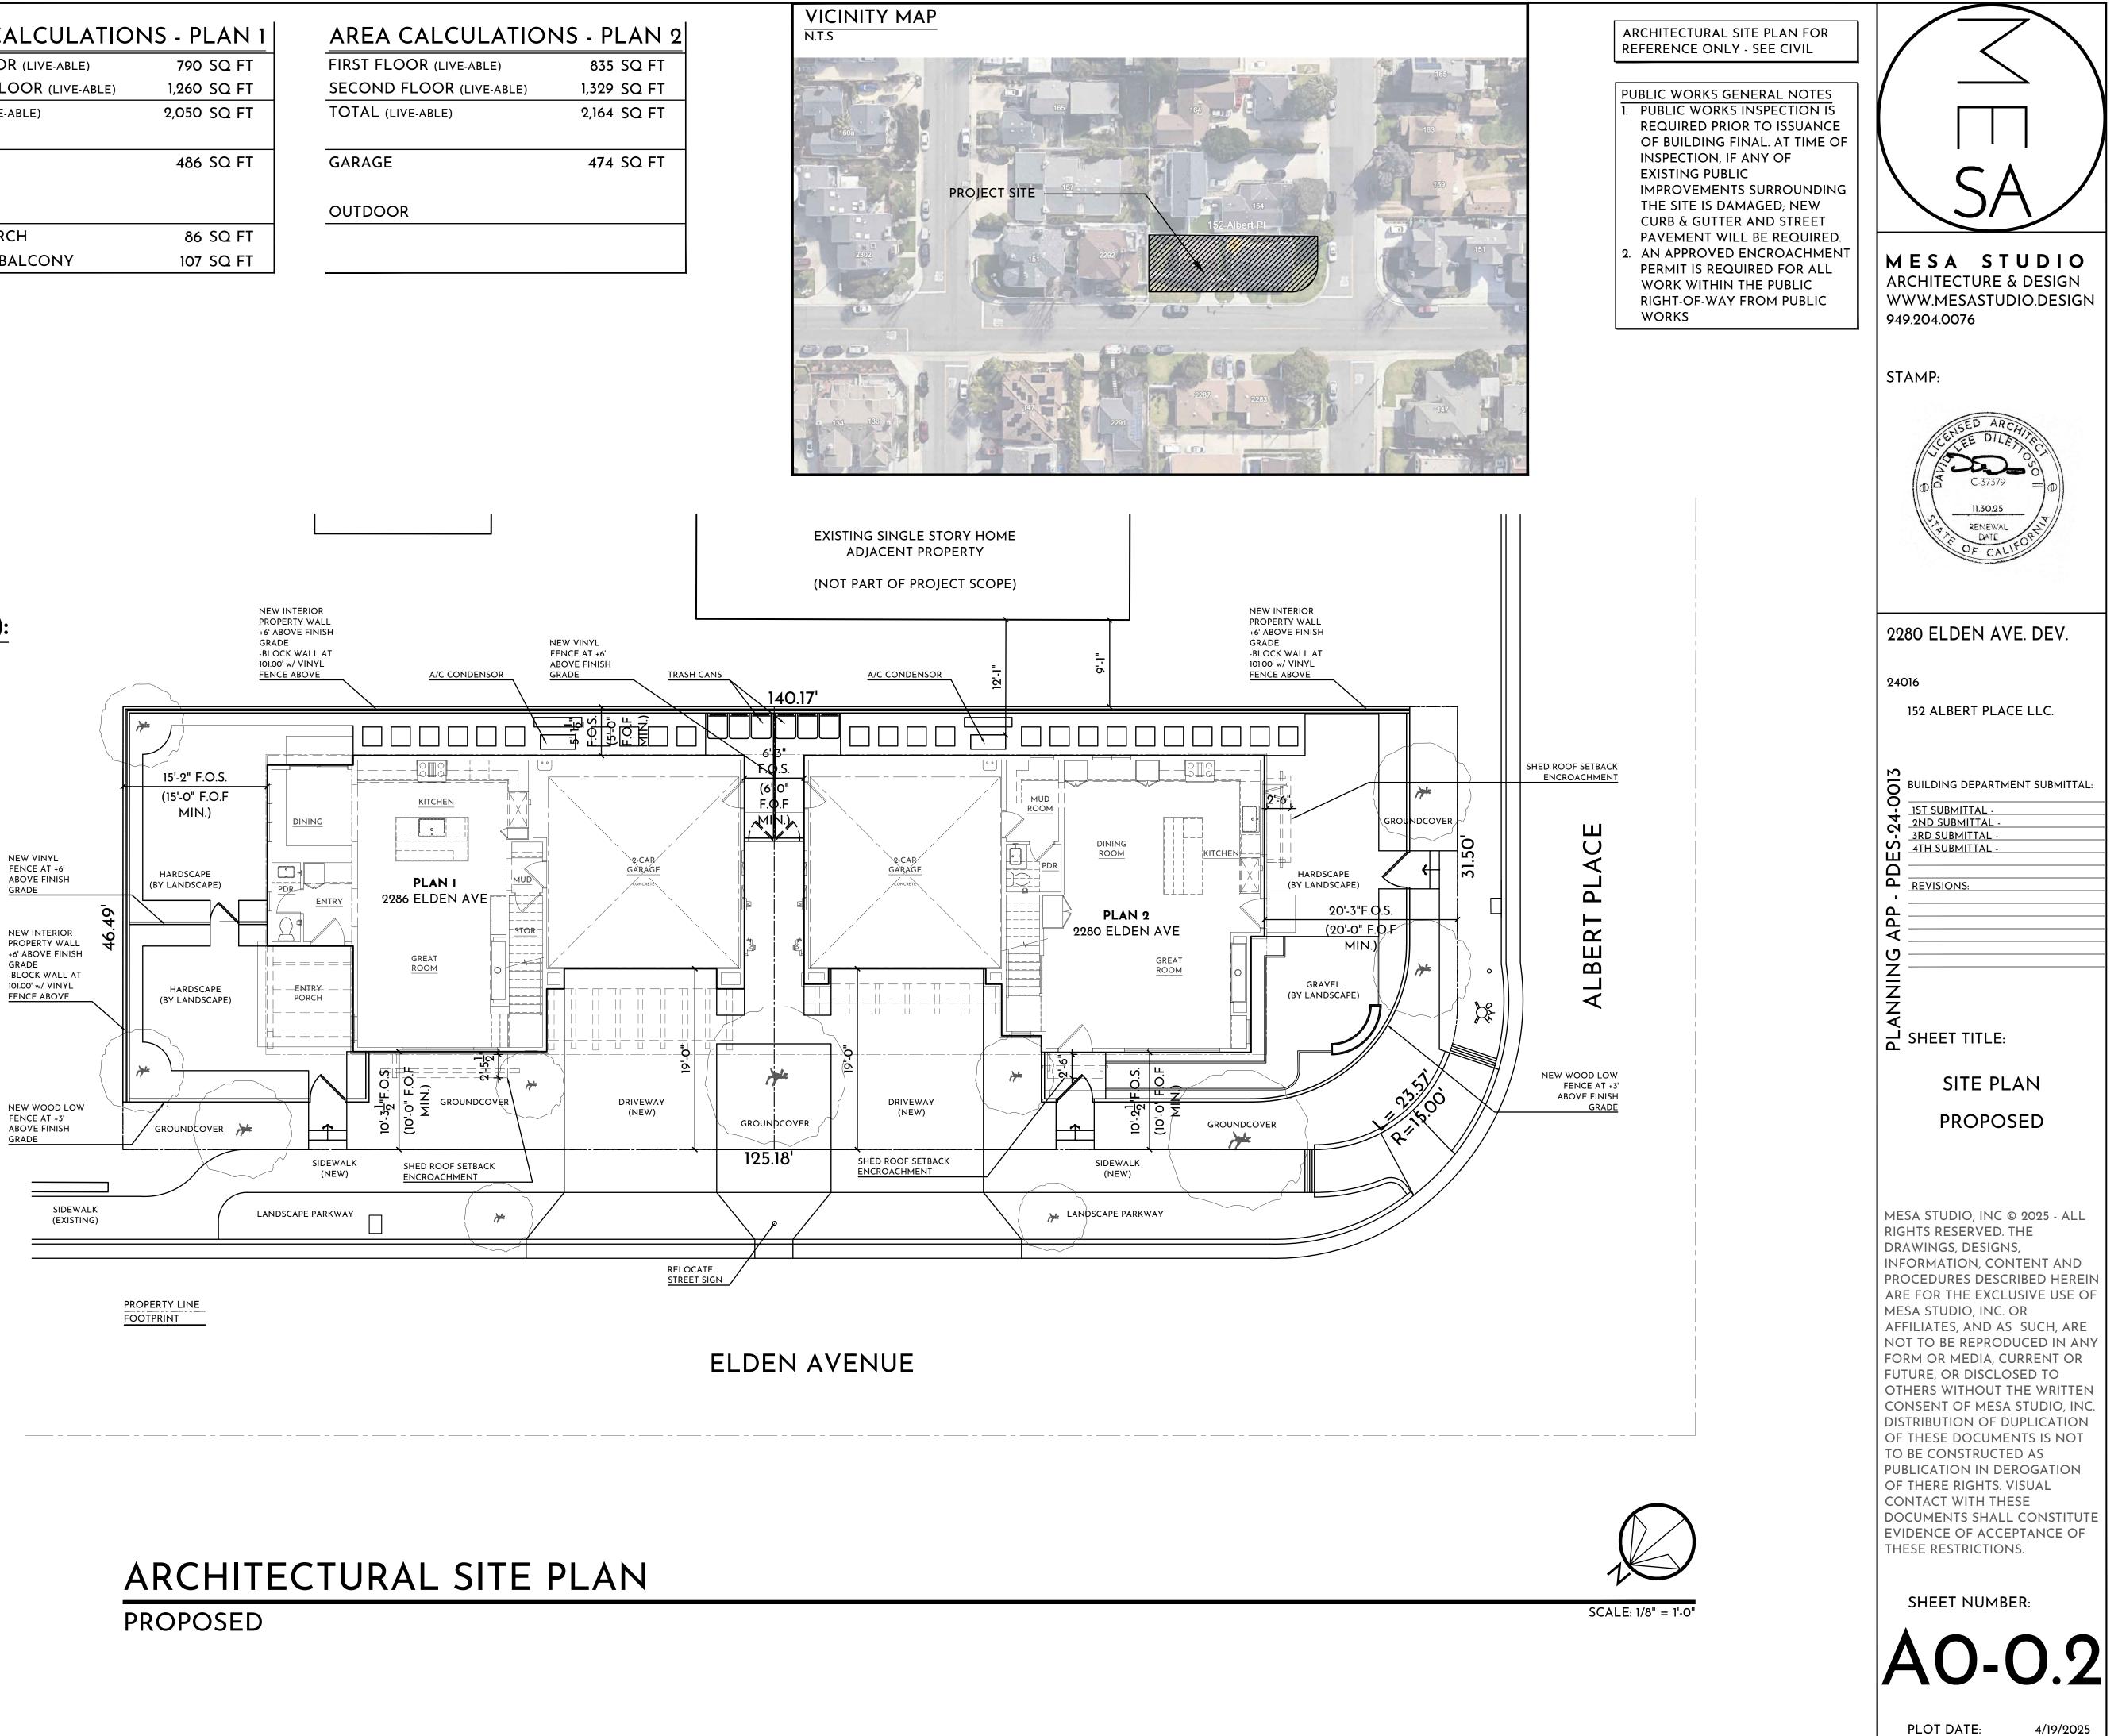





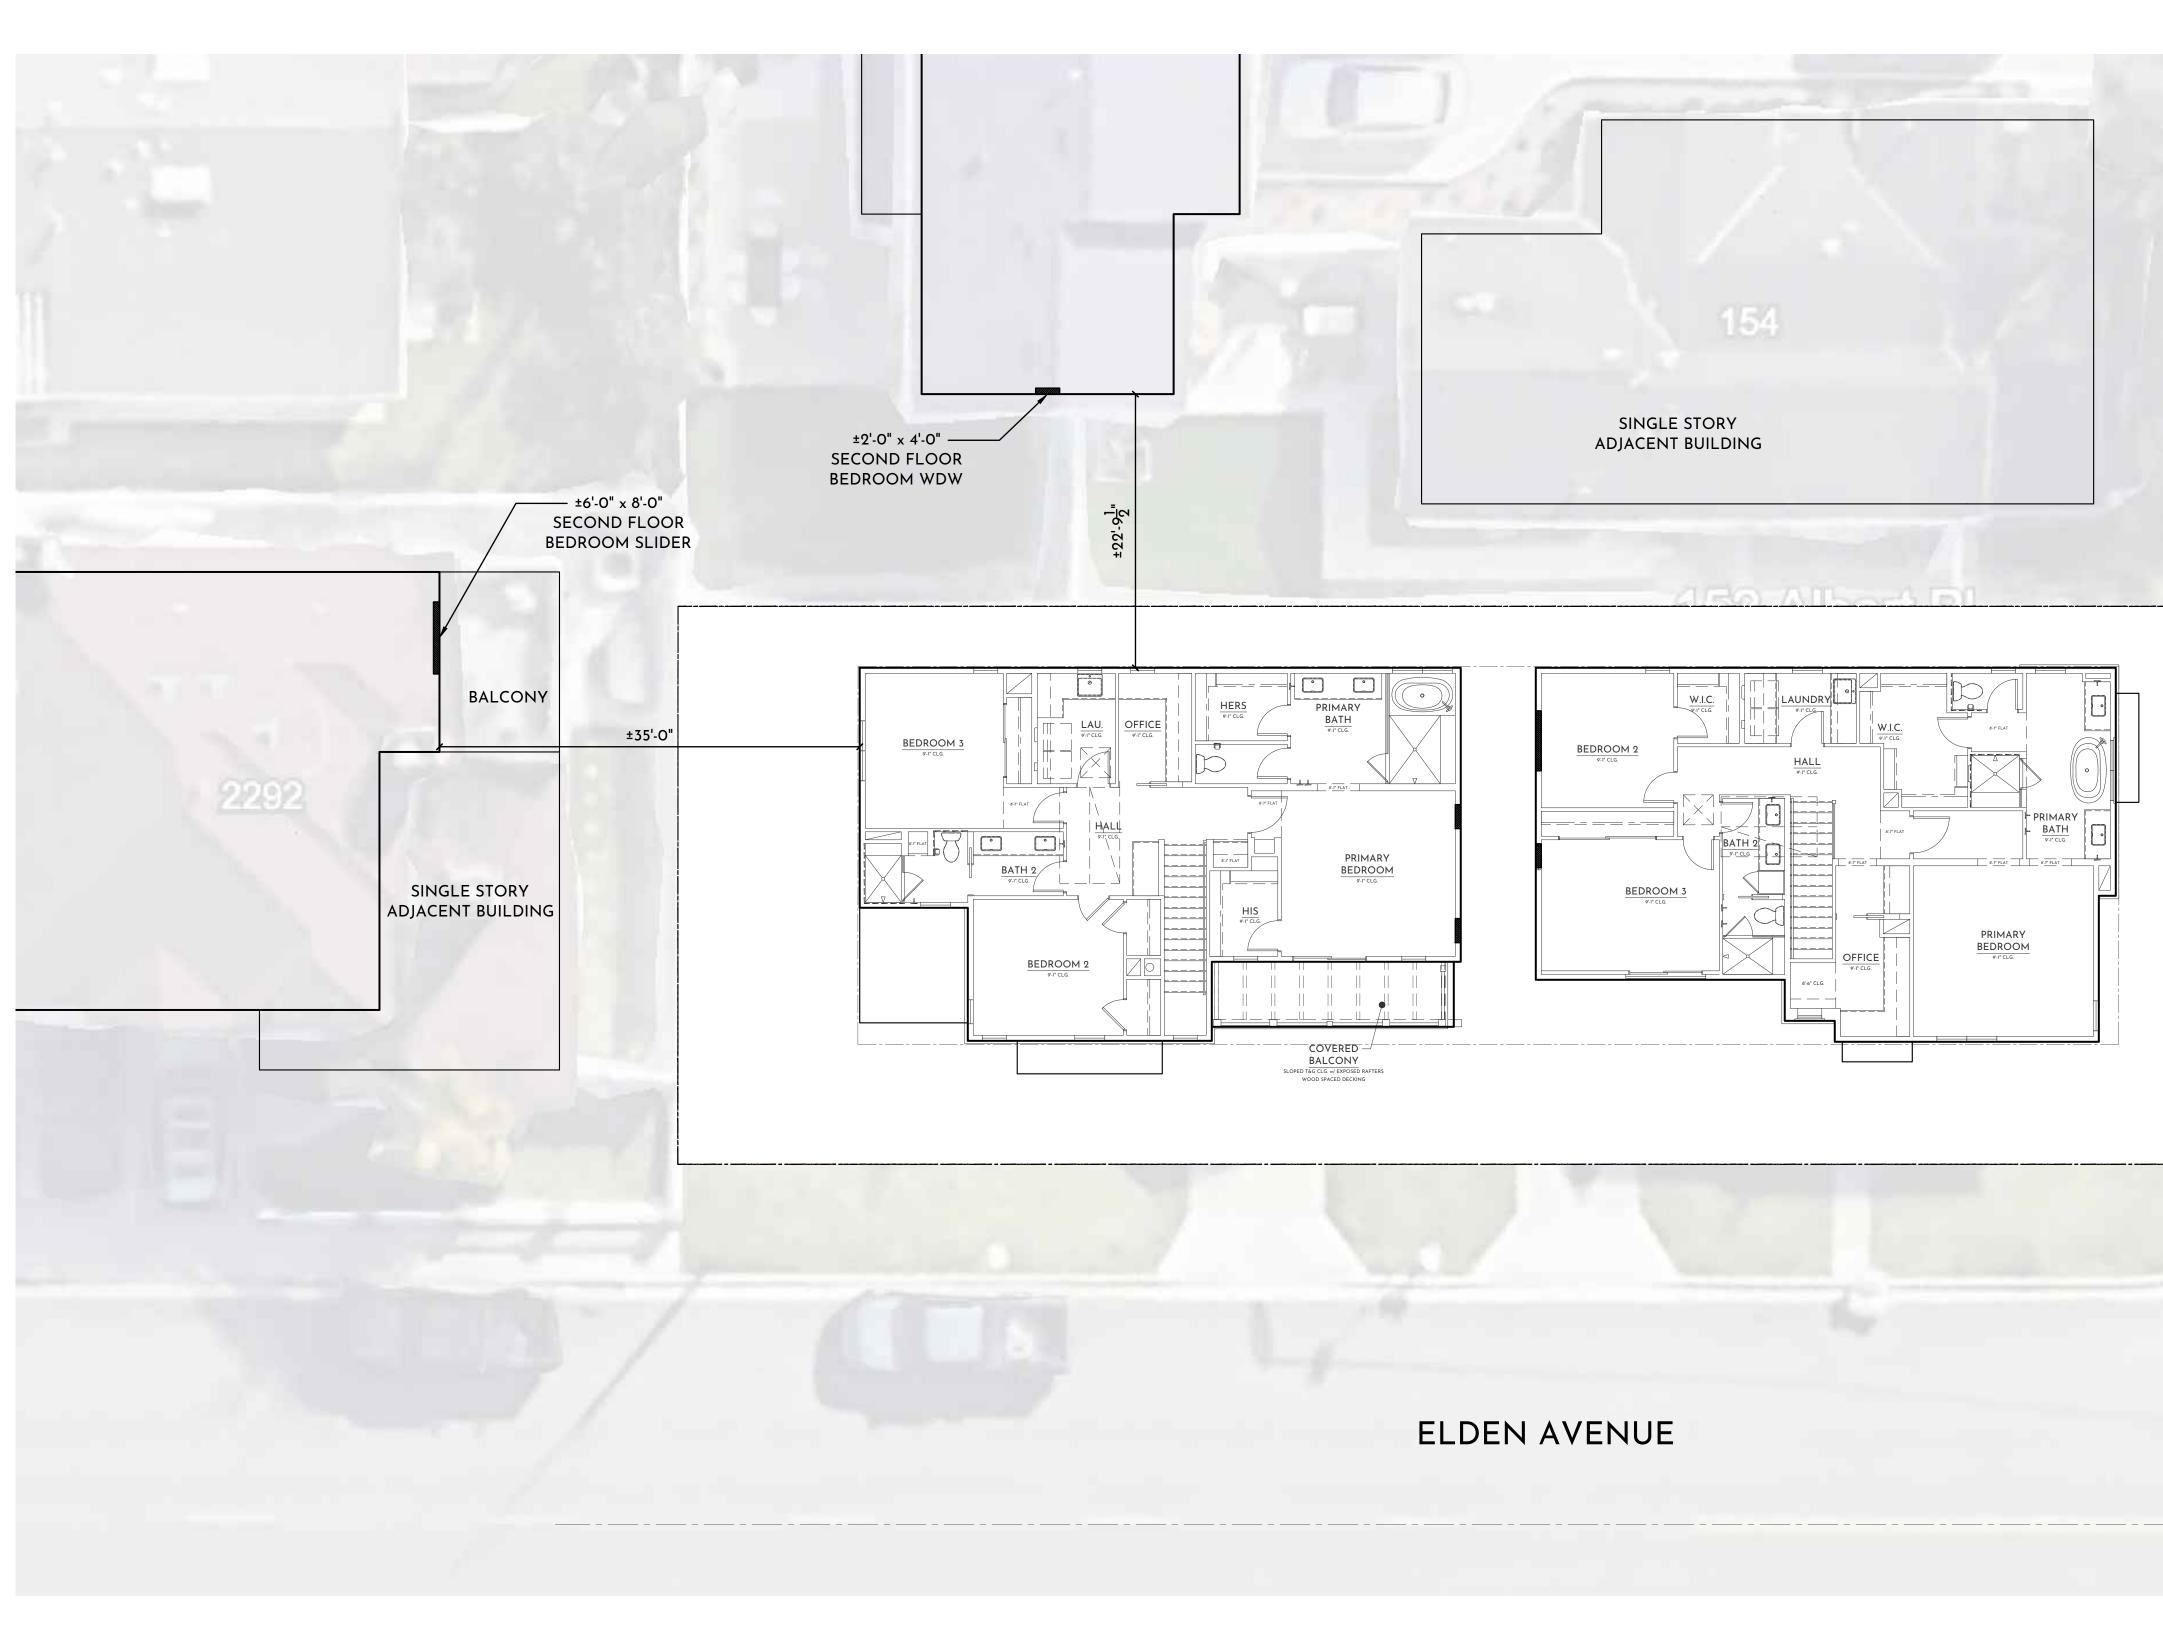



ARCHITECTURAL SITE PLAN

ADJACENT PROPERTY WINDOW STUDY | SECOND FLOOR

ALBERT PLACE
TABBIN State: 1/8" = 1'0"

$\left \right \leq \left \right $
$\land SA /$
MESA STUDIO ARCHITECTURE & DESIGN WWW.MESASTUDIO.DESIGN 949.204.0076
STAMP:
CENSED ARCHINE CENSED DILETTOR C-37379 DOC C-37379 DI 11.30.25 RENEWAL DATE OF CALIFORNY
2280 ELDEN AVE. DEV.
24016
152 ALBERT PLACE LLC.
BUILDING DEPARTMENT SUBMITTAL:
SITE PLAN WINDOW STUDY
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SHEET NUMBER:
AO-0.3
PLOT DATE: 4/19/2025



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II 3025 RENEWAL Preversion 2280 ELDEN AVE. DEV. 24016 I52 ALBERT PLACE LLC. IS0 BUILDING DEPARTMENT SUBMITTAL: IST SUBMITTAL. 3RD SUBMITTAL. 3RD SUBMITTAL. 3RD SUBMITTAL. 3RD SUBMITTAL. BUILDING DEPARTMENT SUBMITTAL: IST SUBMITTAL. 3RD SUBMITTAL. SHEET TITLE: SITE PLAN WINDOW STUDY MESA STUDIO, INC © 2025 - ALL RIGHTS RESERVED. THE DRAWINGS, DESIGNS, INFORMATION, CONTENT AND PROCEDURES DESCRIBED HEREIN ARE FOR THE EXCLUSIVE USE OF MESA STUDIO, INC. © AFFILIATES, AND AS SUCH, ARE NOT TO BE REPRODUCED IN ANY FORM OR MEDIA, CURRENT OR FUTURE, OR DISCLOSED TO OTHERS WITHOUT THE WRITTEN CONSENT OF MESA STUDIO, INC. DISTRIBUTION OF DUPLICATION OF THESE DOCUMENTS IS NOT TO BE CONSTRUCTED AS PUBLICATION IN DEROGATION OF THERE RIGHTS. VISUAL CONTACT WITH T	ST	AMP:			
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A0-0.3	RIG DR/ INF PRC ARE ME: AFF NO FOF FUT OTI CO DIS OF TO PUE OF CO DO EVI	HTS RES AWINGS, ORMATI DCEDUR E FOR TH SA STUD FILIATES T TO BE RM OR M URE, OR HERS WI NSENT O TRIBUTIO THESE E BE CON BLICATIO THERE F NTACT W CUMENT	ERVED. DESIGN ON, COI ES DESC HE EXCL IO, INC. , AND AS REPROE 1EDIA, C C THOUT OF MESA ON OF D OCUME STRUCT ON IN DE RIGHTS. VITH TH IS SHALL OF ACCE	THE IS, NTENT A RIBED H USIVE U OR S SUCH, DUCED IN URRENT DSED TO THE WRI STUDIC OUPLICAT ENTS IS N ED AS EROGATI VISUAL ESE L CONST EPTANCE	ND EREIN SE OF ARE ARE ANY OR TTEN O, INC. TION ON
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				WIN	IDOW SCHED	ULE		
x	SIZE (WxH)	TYPE	FRAME	COLOR	MANUFACTURER (OR APPROVED EQUAL)	U-FACTOR	SHGC	REMARKS
1A	10'-0" x 5'-6"	CASEMENT FIXED	FIBERGLASS	BLACK (EBONY)	MARVIN	0.29	0.22	2 - 2'-6"x5'-6" CASEMENT w/ 5'-0"x5'-6" FIXED, MULLED
1B	6'-0" x 5'-6"	CASEMENT FIXED		1		0.29	0.22	2 - 2'-0"x5'-6" CASEMENT w/ 2'-0"x5'-6" FIXED, MULLED
1C	2'-0" x 4'-6"	CASEMENT				0.29	0.20	
1D	2'-6" x 5'-6"	CASEMENT				0.29	0.20	
1E	2'-6" x 4'-6"	CASEMENT				0.29	0.20	
1F	5'-0" x 5'-6"	CASEMENT				0.29	0.20	2 - 2'-6"x5'-6" CASEMENT, MULLED
1G	2'-6" x 4'-6"	FIXED	V	↓ ↓	V	0.28	0.24	
				W	INDOW NOT	ES		

4. ALL - ROUGH OPENING VERIFY WITH MANUFACTURER 5. SIMULATED DIVIDED LIGHTS (WINDOW MUNTINS) PER EXTERIOR ELEVATIONS

	DOOR SCHEDULE								
X	SIZE (WxH)	TYPE	THICKNESS	COLOR	MANUFACTURER (OR APPROVED EQUAL)	U-FACTOR	SHGC	REMARKS	
101	3'-6" x 8'-0"	ENTRY DOOR		STAINED	СИЅТОМ	0.30	0.23	SOLID CORE w/ TEMPERED GLAZING, STAIN GRADE, WOOD ENTRY DOOR. FOR EGRESS	
102	16'-0" x 8'-0"	SECTIONAL GAR. DR.		STAINED		-	-	SOLID CORE, WOOD GARAGE DOOR - WOOD PANE SECTIONAL GARAGE DOOR w/ AUTOMATIC OPENER	
103	2'-8" x 8'-0"	SOLID CORE	1-3/4"	PAINTED			-	SOLID CORE, w/ TEMPERED GLAZING, PAINT GRADE WOOD DOOR	
104	6'-0" x 8'-0"	SLIDING GLASS		BLACK (EBONY)	MARVIN	0.30	0.19	2-PANEL SLIDING GLASS DOOR XO	
105	2'-8" x 8'-0"	SOLID WOOD	1-3/4"	PER INT.		N/A	N/A	SELF-CLOSING, SELF-LATCHING, TIGHT FIT	
21	2'-6" x 8'-0"	HINGED - INTERIOR	1-3/4"	PER INT.		N/A	N/A	SOLID CORE, PAINT GRADE, WOOD INTERIOR DOOF	
22	2'-8" x 8'-0"	HINGED - INTERIOR	1-3/4"	PER INT.		N/A	N/A	SOLID CORE, PAINT GRADE, WOOD INTERIOR DOOF	
23	3'-0" x 8'-0"	HINGED - INTERIOR	1-3/4"	PER INT.		N/A	N/A	SOLID CORE, PAINT GRADE, WOOD INTERIOR DOOF	
24	2'-6" x 8'-0"	POCKET - INTERIOR	1-3/4"	PER INT.		N/A	N/A	SOLID CORE, PAINT GRADE, WOOD INTERIOR DOOF	
25	2'-4" x 7'-0"	GLASS - INTERIOR				N/A	N/A	GLASS SWINGING DOOR - TEMPERED	
26	6'-0" x 8'-0"	BYPASS - INTERIOR	1-3/4"	PER INT.		N/A	N/A	SOLID CORE, PAINT GRADE, WOOD INTERIOR DOOF	
27	8'-0" x 8'-0"	BYPASS - INTERIOR	1-3/4"	PER INT.		N/A	N/A	SOLID CORE, PAINT GRADE, WOOD INTERIOR DOOF	
28	2'-4" x 8'-0"	POCKET - INTERIOR	1-3/4"	PER INT.		N/A	N/A	SOLID CORE, PAINT GRADE, WOOD INTERIOR DOOF	

DOOR NOTES

1. REFER TO FLOOR PLANS FOR TEMPERED GLASS (SAFETY LOCATIONS) AND EGRESS NOTATIONS

2. ALL EXTERIOR DOORS WITH GLAZING SHALL COMPLY WITH CRC 337.8.2


3. CONFIRM ALL DOORS U-FACTORS AND SHGCS WITH THE ENERGY COMPLIANCE FORMS 4. ALL - ROUGH OPENING VERIFY WITH MANUFACTURER

5. SIMULATED DIVIDED LIGHTS (DOOR MUNTINS) PER EXTERIOR ELEVATIONS

GENERAL NOTES

- HORIZONTAL AND VERTICAL DIMENSIONS SHOWN ARE FROM FACE 1.
- OF STUD OF FACE OF CONCRETE UNLESS NOTED OTHERWISE ANY DISCREPANCY FOUND IN THESE DRAWINGS IS TO BE BROUGHT
- TO THE ATTENTION OF THE ARCHITECT PRIOR TO ANY CONSTRUCTION
- FOR FINISHES REFER TO INTERIOR DESIGNER'S SPEC. 4. ALL MECHANICAL EQUIPMENTS, ELECTRICAL FIXTURES, PLUMBING FIXTURES, AND STRUCTURAL MEMBERS ARE SHOWN FOR REFERENCE
- ONLY. REFER TO CONSULTANT'S DRAWINGS FOR DESIGN, DETAILS AND DIMENSIONS BY OTHERS.
- CONTRACTOR TO COORDINATE PLUMBING, MECHANICAL, ELECTRICAL 5. PENETRATIONS AND CONNECTIONS WITH SUBCONTRACTORS
- 6. ALL EQUIPMENT, APPLIANCES, AND FIXTURES TO BE INSTALLED PER MANUFACTURER'S INSTRUCTIONS.
- PROVIDE THE FOLLOWING AT EGRESS WINDOWS: 5.7 SQ. FT. OF CLEAR 7. OPERABLE AREA; NET OPERABLE HEIGHT SHALL BE 24" MIN.; NET OPERABLE WIDTH SHALL BE 20" MIN,;BOTTOM OF CLEAR OPENING SHALL BE A MAX. HEIGHT OF +44".
- WINDOWS/DOORS TO HAVE LABEL INDICATING U-VALUE AND SHGC 8. PER ENERGY CALCS.
- CONTRACTOR TO PROVIDE/CONFIRM INSULATION IS PROVIDED 9. THROUGHOUT BUILDING ENVELOPE.

SYMBOL LEGEND

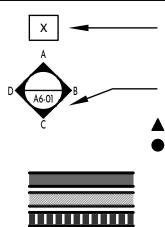

KEY NOTE SEE INTERIOR ELEVATION SHEETS FOR CORRESPONDING VIEWS


▲ = TEMPERED GLASS = EMERGENCY EGRESS WINDOW

2x4 WALL FRAMING - S.S.D. GARAGE | DWELLING SEPARATION

FLOOR PLAN NOTES 0. SPATIAL 0.11 LINE OF FLOOR, DECK, AND/OR WALL ABOVE 0.13 LINE OF CEILING CHANGE ABOVE 0.14 OPENING IN WALL 0.15 GARAGE CLEAR SPACE (10'-0"x20-0" MIN.) 4. MASONRY 4.01 LINE OF ADHERED STONE VENEER FINISH 6. WOOD 6.01 2X WOOD FRAMING - S.S.D. 6.02 WOOD HANDRAIL AT 34-38" ABOVE NOSING 6.03 WOOD GUARD AT 42" A.F.F. 6.04 WOOD CABINETRY - UPPER CABINET 6.05 WOOD CABINETRY - LOWER CABINET 6.07 WOOD CABINETRY - SHELVES 6.10 WOOD SPACED DECKING 8. OPENINGS DWELLING TO GARAGE





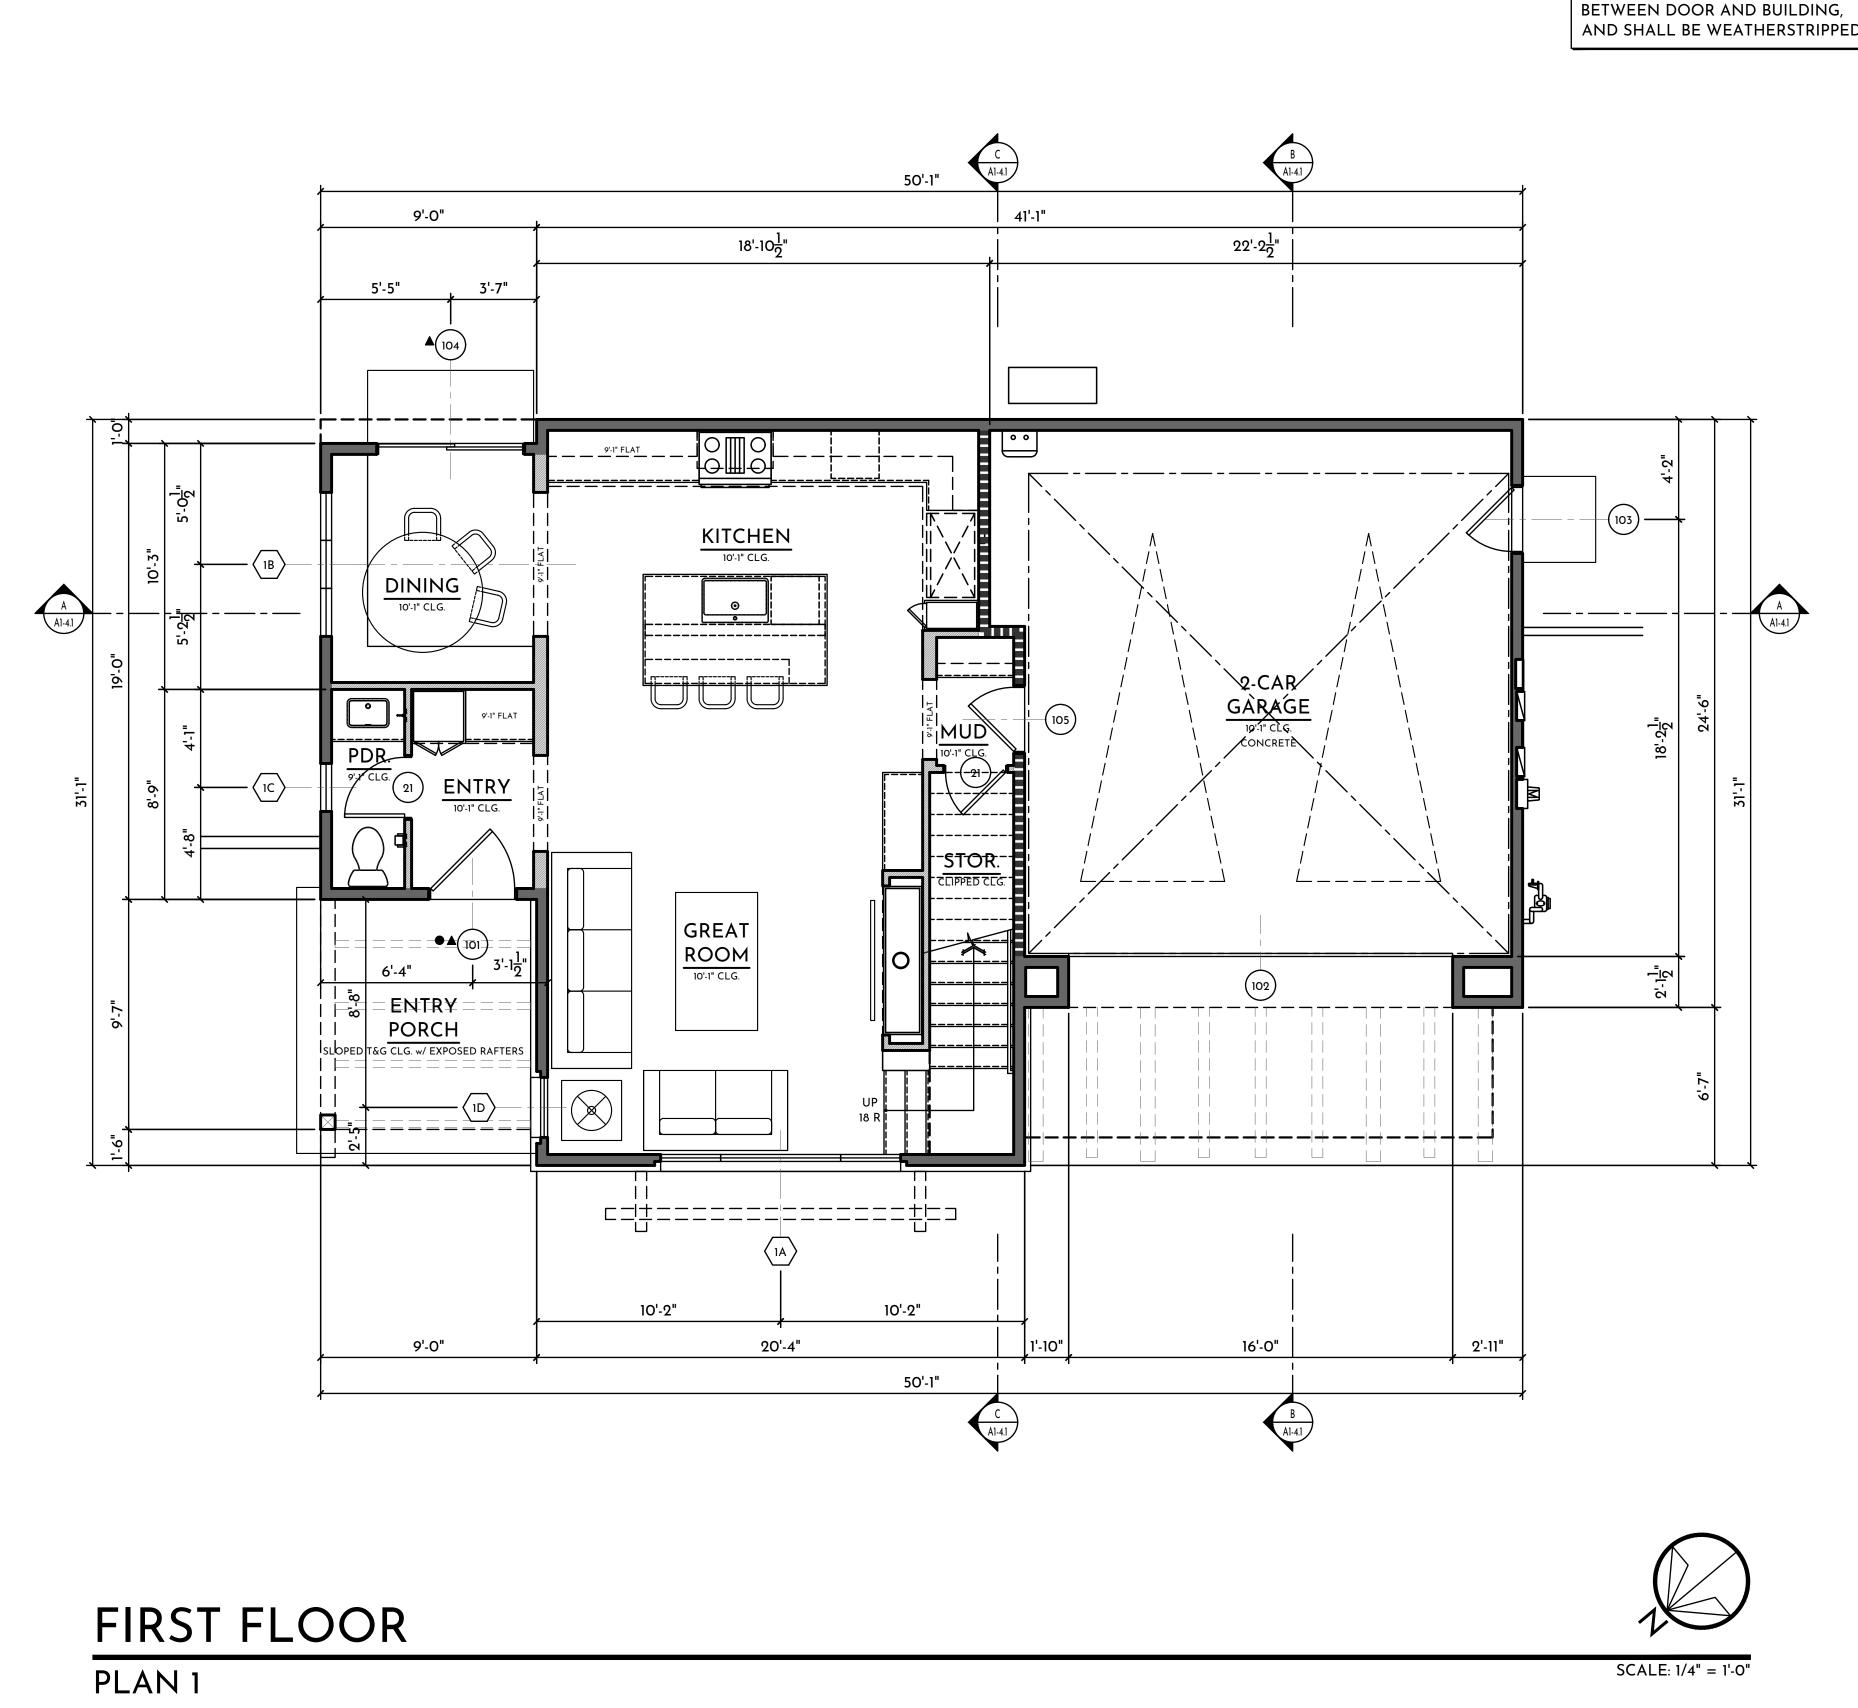

- 0.12 LINE OF FLOOR AND/OR WALL BELOW
- 6.06 WOOD CABINETRY FULL HEIGHT CABINET
- 6.08 WOOD CABINETRY FULL HEIGHT CLOSET CABINET
- 6.09 WOOD CABINETRY BUILT-IN BANQUETTE SEAT w/ STORAGE BELOW
- 8.01 SELF-CLOSING, SELF-LATCHING, TIGHT FITTING, SOLID WOOD 1 3/8" MINIMUM THICK DOOR OR 20 MINUTE DOOR AT OPENINGS FROM
- 8.02 ATTIC ACCESS PANEL 30"X30" MIN CLR MAINTAIN 30"x30" CLEAR SPACE TO FLOOR BELOW OPENING

- 9. FINISHES
- 9.01 5/8" GYP. BOARD (1/2" MIN.) AT GARAGE SIDE TO RESIDENCE & AT GARAGE CEILINGS w/ HABITABLE ROOMS ABOVE (CRC TABLE R302.6) 9.02 DECORATIVE INTERIOR WALL/CEILING FINISH - PER INT. DESIGNER
- 9.03 GYPSUM BOARD LOW WALL w/ WOOD CAP AT 42" A.F.F.
- 9.04 GYPSUM BOARD NICHE 9.05 COUNTERTOP - FINISH PER INT. DESIGNER
- 9.06 EXPOSED ROOF FRAMING, T&G UNDERSIDE. SEE STRUCT. 10. SPECIALITIES
- 10.01 MUDSET CERAMIC TILED SHAMPOO NICHE, 14" x 20"
- R.O. 48" A.F.F. 10.02 GAS APPLIANCE (FIREPLACE) - MEZZO 60 BY HEAT & GLO. DIRECT VENT, ELECTRIC IGNITION. ANSI Z 21.88-2017 OR APPROVED EQUAL 10.03 PROVIDE SOLID BLOCKING FOR FUTURE GRAB BAR REINFORCEMENT PER CRC 327.1.1 - SEE DETAIL 8/AD-12
- 11. EQUIPMENT 11.01 36" RANGE WITH OVEN BELOW
- 11.02 45" REFRIGERATOR SPACE
- 11.03 24" DISHWASHER 11.04 24" BUILT-IN MICROWAVE DRAWER (w/ TRIM KIT) 11.05 EXHAUST RANGE HOOD - VENT TO OUTSIDE AIR
- 12. FURNISHINGS
- 12.01 SHELF & POLE 12.02 SHELF & DOUBLE POLE
- 12.03 TOWEL BAR MOUNTED AT 54" A.F.F. 12.04 TOILET PAPER HOLDER MOUNTED AT 26" A.F.F.
- 12.05 TOWEL HOOK MOUNTED AT 54" A.F.F.
 - -11-

- 15. MECHANICAL / PLUMBING / ELECTRICAL 15.01 DROP-IN SINK WITH GARBAGE DISPOSAL 15.02 LAVATORY SINK
- 15.03 LAUNDRY SINK
- ON LEFT SIDE OF DRYER 15.05 DRYER SPACE - ROUTE DUCT TO OUTSIDE AIR 15.06 HOT-MOPPED SHOWER w/ SHATTER RESISTANT GLASS SHOWER
- ENCLOSURE. PROVIDE NONABSORBENT AT ALL SURFACES IN PRIMARY SHOWERS / WET AREAS. SHOWER SEAT +20" AFF SLOPED 1/2" PER
- FOOT, WHERE OCCURS 15.07 SHATTER RESISTANT GLASS SHOWER DOOR
- 15.08 FREE STANDING TUB w/ FLOOR MOUNT TUB FILLER 15.09 WATER CLOSET (MIN. 30" WIDTH AT WALL & 24" MIN. CLEAR IN FRONT) 15.10 SHOWER HEAD - 82" AFF
- 15.11 GAS METER REFER TO EXTERIOR ELEVATIONS FOR LOCATION. MAINTAIN 3'-0" CLEARANCE FROM ANY PIPING TO EDGE OF
- ELECTRICAL METER 15.12 ELECTRIC METER. MAINTAIN 3'-0" CLEAR FROM FACE OF PANEL TO ANY WALL SURFACE OR OBSTRUCTIONS.
- 15.13 CABLE TV/PHONE PANELS 15.14 HEAT PUMP AIR UNIT IN ATTIC. PROVIDE FUEL GAS, LIGHT, AND SWITCH
- 15.15 TANKLESS WATER HEATER BOTTOM @ 48" AF.F. REFER TO ENERGY REPORT FOR ENERGY FACTOR SPECS. INSTALL PER MANUFACTURER'S INSTRUCTIONS. 15.16 A/C CONDENSER UNIT
- 15.17 ELECTRICAL SUB-PANEL
- 15.18 MECHANICAL CHASE

MESA STUDIO **ARCHITECTURE & DESIGN** WWW.MESASTUDIO.DESIGN 949.204.0076 STAMP: RENEWA 2280 ELDEN AVE. DEV. 24016 152 ALBERT PLACE LLC. **6** BUILDING DEPARTMENT SUBMITTAL: IST SUBMITTAL 2ND SUBMITTAL 3RD SUBMITTAL S 4TH SUBMITTAL \cap A REVISIONS: (7 Ī IST FLOOR PLAN PLAN 1 MESA STUDIO, INC © 2025 - ALL RIGHTS RESERVED. THE DRAWINGS, DESIGNS, INFORMATION, CONTENT AND PROCEDURES DESCRIBED HEREIN ARE FOR THE EXCLUSIVE USE OF MESA STUDIO, INC. OR AFFILIATES, AND AS SUCH, ARE NOT TO BE REPRODUCED IN ANY FORM OR MEDIA, CURRENT OR FUTURE, OR DISCLOSED TO OTHERS WITHOUT THE WRITTEN CONSENT OF MESA STUDIO, INC. DISTRIBUTION OF DUPLICATION OF THESE DOCUMENTS IS NOT TO BE CONSTRUCTED AS PUBLICATION IN DEROGATION OF THERE RIGHTS. VISUAL CONTACT WITH THESE DOCUMENTS SHALL CONSTITUTE EVIDENCE OF ACCEPTANCE OF THESE RESTRICTIONS. SHEET NUMBER:

15.04 WASHER SPACE - PROVIDE FLOOR DRAIN AND SMITTY PAN, INSTALL

AREA CALCULATIONS - PLAN 1				
FIRST FLOOR (LIVE-ABLE)	790 SQ FT			
SECOND FLOOR (LIVE-ABLE)	1,260 SQ FT			
TOTAL (LIVE-ABLE)	2,050 SQ FT			
GARAGE	486 SQ FT			
OUTDOOR				
ENTRY PORCH	86 SQ FT			
COVERED BALCONY	107 SQ FT			

ENERGY NOTE: ALL EXTERIOR DOORS SHALL BE CAULKED

				WIN	IDOW SCHED	ULE		
x	SIZE (WxH)	TYPE	FRAME	COLOR	MANUFACTURER (OR APPROVED EQUAL)	U-FACTOR	SHGC	REMARKS
1A	10'-0" x 5'-6"	CASEMENT FIXED	FIBERGLASS	BLACK (EBONY)	MARVIN	0.29	0.22	2 - 2'-6"x5'-6" CASEMENT w/ 5'-0"x5'-6" FIXED, MULLED
1B	6'-0" x 5'-6"	CASEMENT FIXED		1		0.29	0.22	2 - 2'-0"x5'-6" CASEMENT w/ 2'-0"x5'-6" FIXED, MULLED
1C	2'-0" x 4'-6"	CASEMENT				0.29	0.20	
1D	2'-6" x 5'-6"	CASEMENT				0.29	0.20	
1E	2'-6" x 4'-6"	CASEMENT				0.29	0.20	
1F	5'-0" x 5'-6"	CASEMENT				0.29	0.20	2 - 2'-6"x5'-6" CASEMENT, MULLED
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				W	INDOW NOT	ES		

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	DOOR SCHEDULE								
X	SIZE (WxH)	TYPE	THICKNESS	COLOR	MANUFACTURER (OR APPROVED EQUAL)	U-FACTOR	SHGC	REMARKS	
101	3'-6" x 8'-0"	ENTRY DOOR		STAINED	СИЅТОМ	0.30	0.23	SOLID CORE w/ TEMPERED GLAZING, STAIN GRADE, WOOD ENTRY DOOR. FOR EGRESS	
102	16'-0" x 8'-0"	SECTIONAL GAR. DR.		STAINED		-	-	SOLID CORE, WOOD GARAGE DOOR - WOOD PANE SECTIONAL GARAGE DOOR w/ AUTOMATIC OPENER	
103	2'-8" x 8'-0"	SOLID CORE	1-3/4"	PAINTED			-	SOLID CORE, w/ TEMPERED GLAZING, PAINT GRADE WOOD DOOR	
104	6'-0" x 8'-0"	SLIDING GLASS		BLACK (EBONY)	MARVIN	0.30	0.19	2-PANEL SLIDING GLASS DOOR XO	
105	2'-8" x 8'-0"	SOLID WOOD	1-3/4"	PER INT.		N/A	N/A	SELF-CLOSING, SELF-LATCHING, TIGHT FIT	
21	2'-6" x 8'-0"	HINGED - INTERIOR	1-3/4"	PER INT.		N/A	N/A	SOLID CORE, PAINT GRADE, WOOD INTERIOR DOOF	
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23	3'-0" x 8'-0"	HINGED - INTERIOR	1-3/4"	PER INT.		N/A	N/A	SOLID CORE, PAINT GRADE, WOOD INTERIOR DOOF	
24	2'-6" x 8'-0"	POCKET - INTERIOR	1-3/4"	PER INT.		N/A	N/A	SOLID CORE, PAINT GRADE, WOOD INTERIOR DOOF	
25	2'-4" x 7'-0"	GLASS - INTERIOR				N/A	N/A	GLASS SWINGING DOOR - TEMPERED	
26	6'-0" x 8'-0"	BYPASS - INTERIOR	1-3/4"	PER INT.		N/A	N/A	SOLID CORE, PAINT GRADE, WOOD INTERIOR DOOF	
27	8'-0" x 8'-0"	BYPASS - INTERIOR	1-3/4"	PER INT.		N/A	N/A	SOLID CORE, PAINT GRADE, WOOD INTERIOR DOOF	
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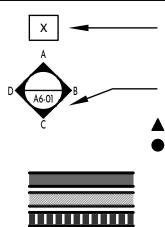
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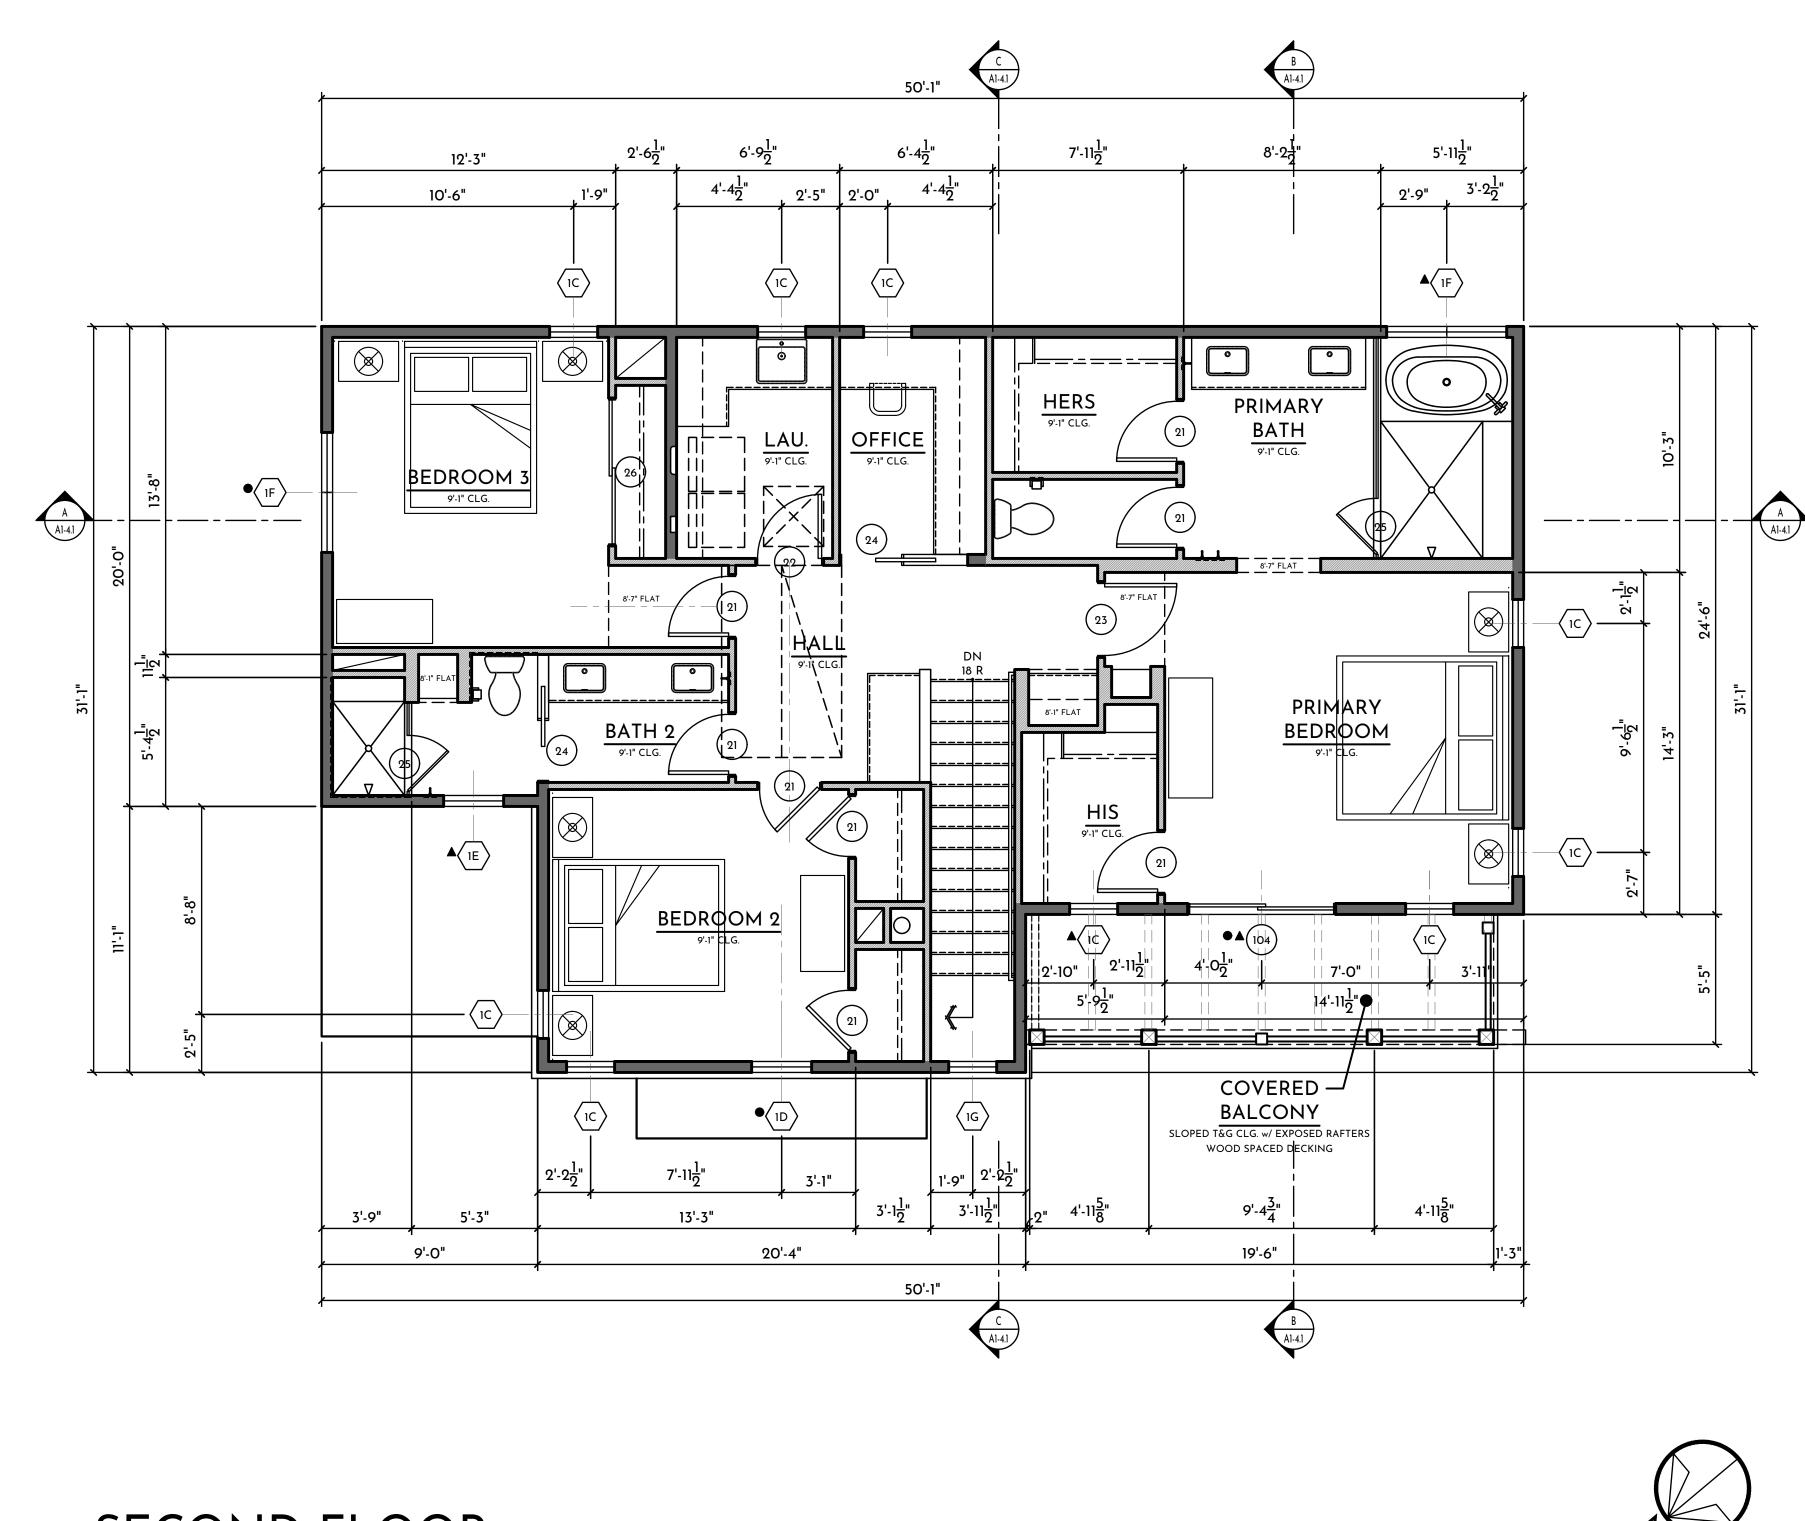
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2x4 WALL FRAMING - S.S.D. GARAGE | DWELLING SEPARATION

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SECOND FLOOR

PLAN 1

- 0.12 LINE OF FLOOR AND/OR WALL BELOW
- 6.08 WOOD CABINETRY FULL HEIGHT CLOSET CABINET
- 6.09 WOOD CABINETRY BUILT-IN BANQUETTE SEAT w/ STORAGE BELOW
- 8.01 SELF-CLOSING, SELF-LATCHING, TIGHT FITTING, SOLID WOOD 1 3/8" MINIMUM THICK DOOR OR 20 MINUTE DOOR AT OPENINGS FROM
- 8.02 ATTIC ACCESS PANEL 30"X30" MIN CLR MAINTAIN 30"x30" CLEAR SPACE TO FLOOR BELOW OPENING

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- 9.04 GYPSUM BOARD NICHE 9.05 COUNTERTOP - FINISH PER INT. DESIGNER
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- PER CRC 327.1.1 SEE DETAIL 8/AD-12 11. EQUIPMENT
- 11.01 36" RANGE WITH OVEN BELOW 11.02 45" REFRIGERATOR SPACE
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- ENCLOSURE. PROVIDE NONABSORBENT AT ALL SURFACES IN PRIMARY SHOWERS / WET AREAS. SHOWER SEAT +20" AFF SLOPED 1/2" PER FOOT, WHERE OCCURS
- 15.07 SHATTER RESISTANT GLASS SHOWER DOOR 15.08 FREE STANDING TUB w/ FLOOR MOUNT TUB FILLER
- 15.09 WATER CLOSET (MIN. 30" WIDTH AT WALL & 24" MIN. CLEAR IN FRONT) 15.10 SHOWER HEAD - 82" AFF
- 15.11 GAS METER REFER TO EXTERIOR ELEVATIONS FOR LOCATION. MAINTAIN 3'-0" CLEARANCE FROM ANY PIPING TO EDGE OF ELECTRICAL METER
- 15.12 ELECTRIC METER. MAINTAIN 3'-0" CLEAR FROM FACE OF PANEL TO ANY WALL SURFACE OR OBSTRUCTIONS.
- 15.13 CABLE TV/PHONE PANELS 15.14 HEAT PUMP AIR UNIT IN ATTIC. PROVIDE FUEL GAS, LIGHT, AND SWITCH
- 15.15 TANKLESS WATER HEATER BOTTOM @ 48" AF.F. REFER TO ENERGY REPORT FOR ENERGY FACTOR SPECS. INSTALL PER MANUFACTURER'S INSTRUCTIONS. 15.16 A/C CONDENSER UNIT
- 15.17 ELECTRICAL SUB-PANEL
- 15.18 MECHANICAL CHASE

ENERGY NOTE: ALL EXTERIOR DOORS SHALL BE CAULKED BETWEEN DOOR AND BUILDING, AND SHALL BE WEATHERSTRIPPED

MESA STUDIO **ARCHITECTURE & DESIGN** WWW.MESASTUDIO.DESIGN 949.204.0076 STAMP: RENEW 2280 ELDEN AVE. DEV. 24016 152 ALBERT PLACE LLC. **6** BUILDING DEPARTMENT SUBMITTAL: IST SUBMITTAL 2ND SUBMITTAL 3RD SUBMITTAL S 4TH SUBMITTAL A REVISIONS: (7 Ī SHEET TITLE: 2ND FLOOR PLAN PLAN 1 MESA STUDIO, INC © 2025 - ALL RIGHTS RESERVED. THE DRAWINGS, DESIGNS, INFORMATION, CONTENT AND PROCEDURES DESCRIBED HEREIN ARE FOR THE EXCLUSIVE USE OF MESA STUDIO, INC. OR AFFILIATES, AND AS SUCH, ARE NOT TO BE REPRODUCED IN ANY FORM OR MEDIA, CURRENT OR FUTURE, OR DISCLOSED TO OTHERS WITHOUT THE WRITTEN CONSENT OF MESA STUDIO, INC. DISTRIBUTION OF DUPLICATION OF THESE DOCUMENTS IS NOT TO BE CONSTRUCTED AS PUBLICATION IN DEROGATION OF THERE RIGHTS. VISUAL CONTACT WITH THESE DOCUMENTS SHALL CONSTITUTE EVIDENCE OF ACCEPTANCE OF THESE RESTRICTIONS. SHEET NUMBER:

PLOT DATE:

4/19/2025

15.04 WASHER SPACE - PROVIDE FLOOR DRAIN AND SMITTY PAN, INSTALL

AREA CALCULATIONS - PLAN 1						
FIRST FLOOR (LIVE-ABLE)	790 SQ FT					
SECOND FLOOR (LIVE-ABLE)	1,260 SQ FT					
TOTAL (LIVE-ABLE)	2,050 SQ FT					
GARAGE	486 SQ FT					
OUTDOOR						
ENTRY PORCH	86 SQ FT					
COVERED BALCONY	107 SQ FT					

SCALE: 1/4" = 1'-0"

AREA	A	B		C		D		
	ATTIC AREA	REQUIRED VENTING		VENTS w/ $\frac{1}{8}$ " MESH O'HAGIN VENT=72		TOTAL VENTING PROVIDED		
	(SQ. FT.)	(S	(SQ. IN.)		(SQ. IN.)		(SQ. IN.)	
		317	HIGH	(5)72=360	HIGH	360	HIGH	
AREA 1	1,320	317	LOW	(5)72=360	LOW	360	LOW	
EQUIRED AT	TIC VENTILATION	1						
CALCULATE THE FREE VENTING A DIVIDE BY 2 TO 3 VENTING REQUI	UARE FEET). OO AND MULTIPLY BY 144 E TOTAL REQUIRED MININ AREA IN SQUARE INCHES SET THE MAXIMUM NET F RED HIGH AND THE MINI	MUM NET FREE						
REQUIRED VENT HIGH VENTS LO VERTICALLY BEL OF THE SPACE, V	REQUIRED LOW. ND NO MORE THAN 50% ING AREA SHALL BE PRO CATED NO MORE THAN 3 LOW THE RIDGE OR HIGH WITH THE BALANCE OF V AVE/LOW VENTS).	OVIDED BY 3 FEET IEST POINT						
CALCULATE THE FREE VENTING A (NO HIGH/LOW USING 1/150.)	O AND MULTIPLY BY 144 1 E TOTAL REQUIRED MININ AREA IN SQUARE INCHES VENTING REQUIREMENT	MUM NET S WHEN						
AREA PROVIDED IN. OF FREE ARE PRIMARY VENT S	INCHES OF NET FREE VE BY O'HAGIN ROOF AIR V A MIN. EACH VENT) PRO' SUB-FLASHING w/ 6" FLAN GH SIDE. VENT FLASHING	/ENTS. (72 SQ. VIDE O'HAGIN IGE AND						
	INCHES OF NET FREE VE	NTILATING						
н HIGI	H VENT							
	/ VENT							
	T NOT REQ. TO MEET HIG	GH OR LOW						

GENERAL NOTES

4.

5.

AND DIMENSIONS BY OTHERS.

MANUFACTURER'S INSTRUCTIONS.

STANDING SEAM METAL ROOF:

EMISSIVITY = 0.85)

EQUAL'

COMPOSITION ROOF:

HORIZONTAL AND VERTICAL DIMENSIONS SHOWN ARE FROM FACE 1. OF STUD OF FACE OF CONCRETE UNLESS NOTED OTHERWISE 2. ANY DISCREPANCY FOUND IN THESE DRAWINGS IS TO BE BROUGHT

3. ALL MECHANICAL EQUIPMENTS, ELECTRICAL FIXTURES, PLUMBING

PENETRATIONS AND CONNECTIONS WITH SUBCONTRACTORS

6. ALL ROOFING TO BE A MINIMUM CLASS A (REFLECTANCE = 0.10 &

-GAF TIMBERLINE HD (ESR 1475) OR 'APPROVED

TO THE ATTENTION OF THE ARCHITECT PRIOR TO ANY CONSTRUCTION

FIXTURES, AND STRUCTURAL MEMBERS ARE SHOWN FOR REFERENCE

CONTRACTOR TO COORDINATE PLUMBING, MECHANICAL, ELECTRICAL

ALL EQUIPMENT, APPLIANCES, AND FIXTURES TO BE INSTALLED PER

ONLY. REFER TO CONSULTANT'S DRAWINGS FOR DESIGN, DETAILS

ON ROOF UNDERSHOTS: 8" AT COMPOSITION SHINGLE ROOFS.

8.

- X 🗕
- PLUMBING VENTS, EXHAUST VENTS OR SIMILAR TERMINATION ACCESSORIES SHALL BE ROUTED TO A PLANE ON THE ROOF THAT IS LEAST VISIBLE FROM PUBLIC VIEW AND GROUPED TOGETHER WHEN POSSIBLE. IT IS THE CONTRACTOR'S RESPONSIBILITY TO NOTIFY THE ARCHITECT PRIOR TO INSTALLATION AND CONFIRM LOCATION. ALL EXPOSED METAL ON ROOF SHALL BE CORROSION RESISTANT
- AND BE PAINTED TO MATCH THE COLOR OF THE ROOF MATERIAL U.N.O.
- 10. ALL PENETRATIONS IN VALLEYS SHALL BE LOCATED 18" MIN. OUTSIDE VALLEY WATERWAYS, AND 18" MIN. FROM OTHER PENETRATIONS OR PROJECTIONS, SUCH AS PIPES, WALLS, CURBS, ETC. ALL PENETRATIONS SHALL BE OFFSET 18" MIN. FROM WATERWAY TERMINATIONS SUCH AS VALLEY ENDS AND TILE PAN ENDS, ETC. ALL PENETRATIONS SHALL BE VERTICALLY PLUMB THROUGH ROOF SHEATHING AND EXTEND 12" MIN. ABOVE SHEATHING. 26 GA. MIN. METAL FLASHING (TYP.)
- FRAMER TO PROVIDE VENTILATION TO AREAS OF ATTIC ISOLATED BY 11. OVER-FRAMING, PROVIDE A 22"X30" ACCESS WAY AT OVER-FRAMING THAT IS OVER 30" CLEAR IN HEIGHT.




 $\left\{ \right\}$

7. PROVIDE THE FOLLOWING MINIMUM DIMENSIONS FOR VERTICAL LEG

-TAYLOR METAL EASY LOCK 24 GAUGE - 16" SEAM (UL ER#25913-01)

ROOF NOTE: CENTERLINE AT LOWER ATTIC VENT LOCATIONS INDICATES ALIGNMENT WITH A WINDOW, DOOR OR OPENING BELOW PER ELEVATION.

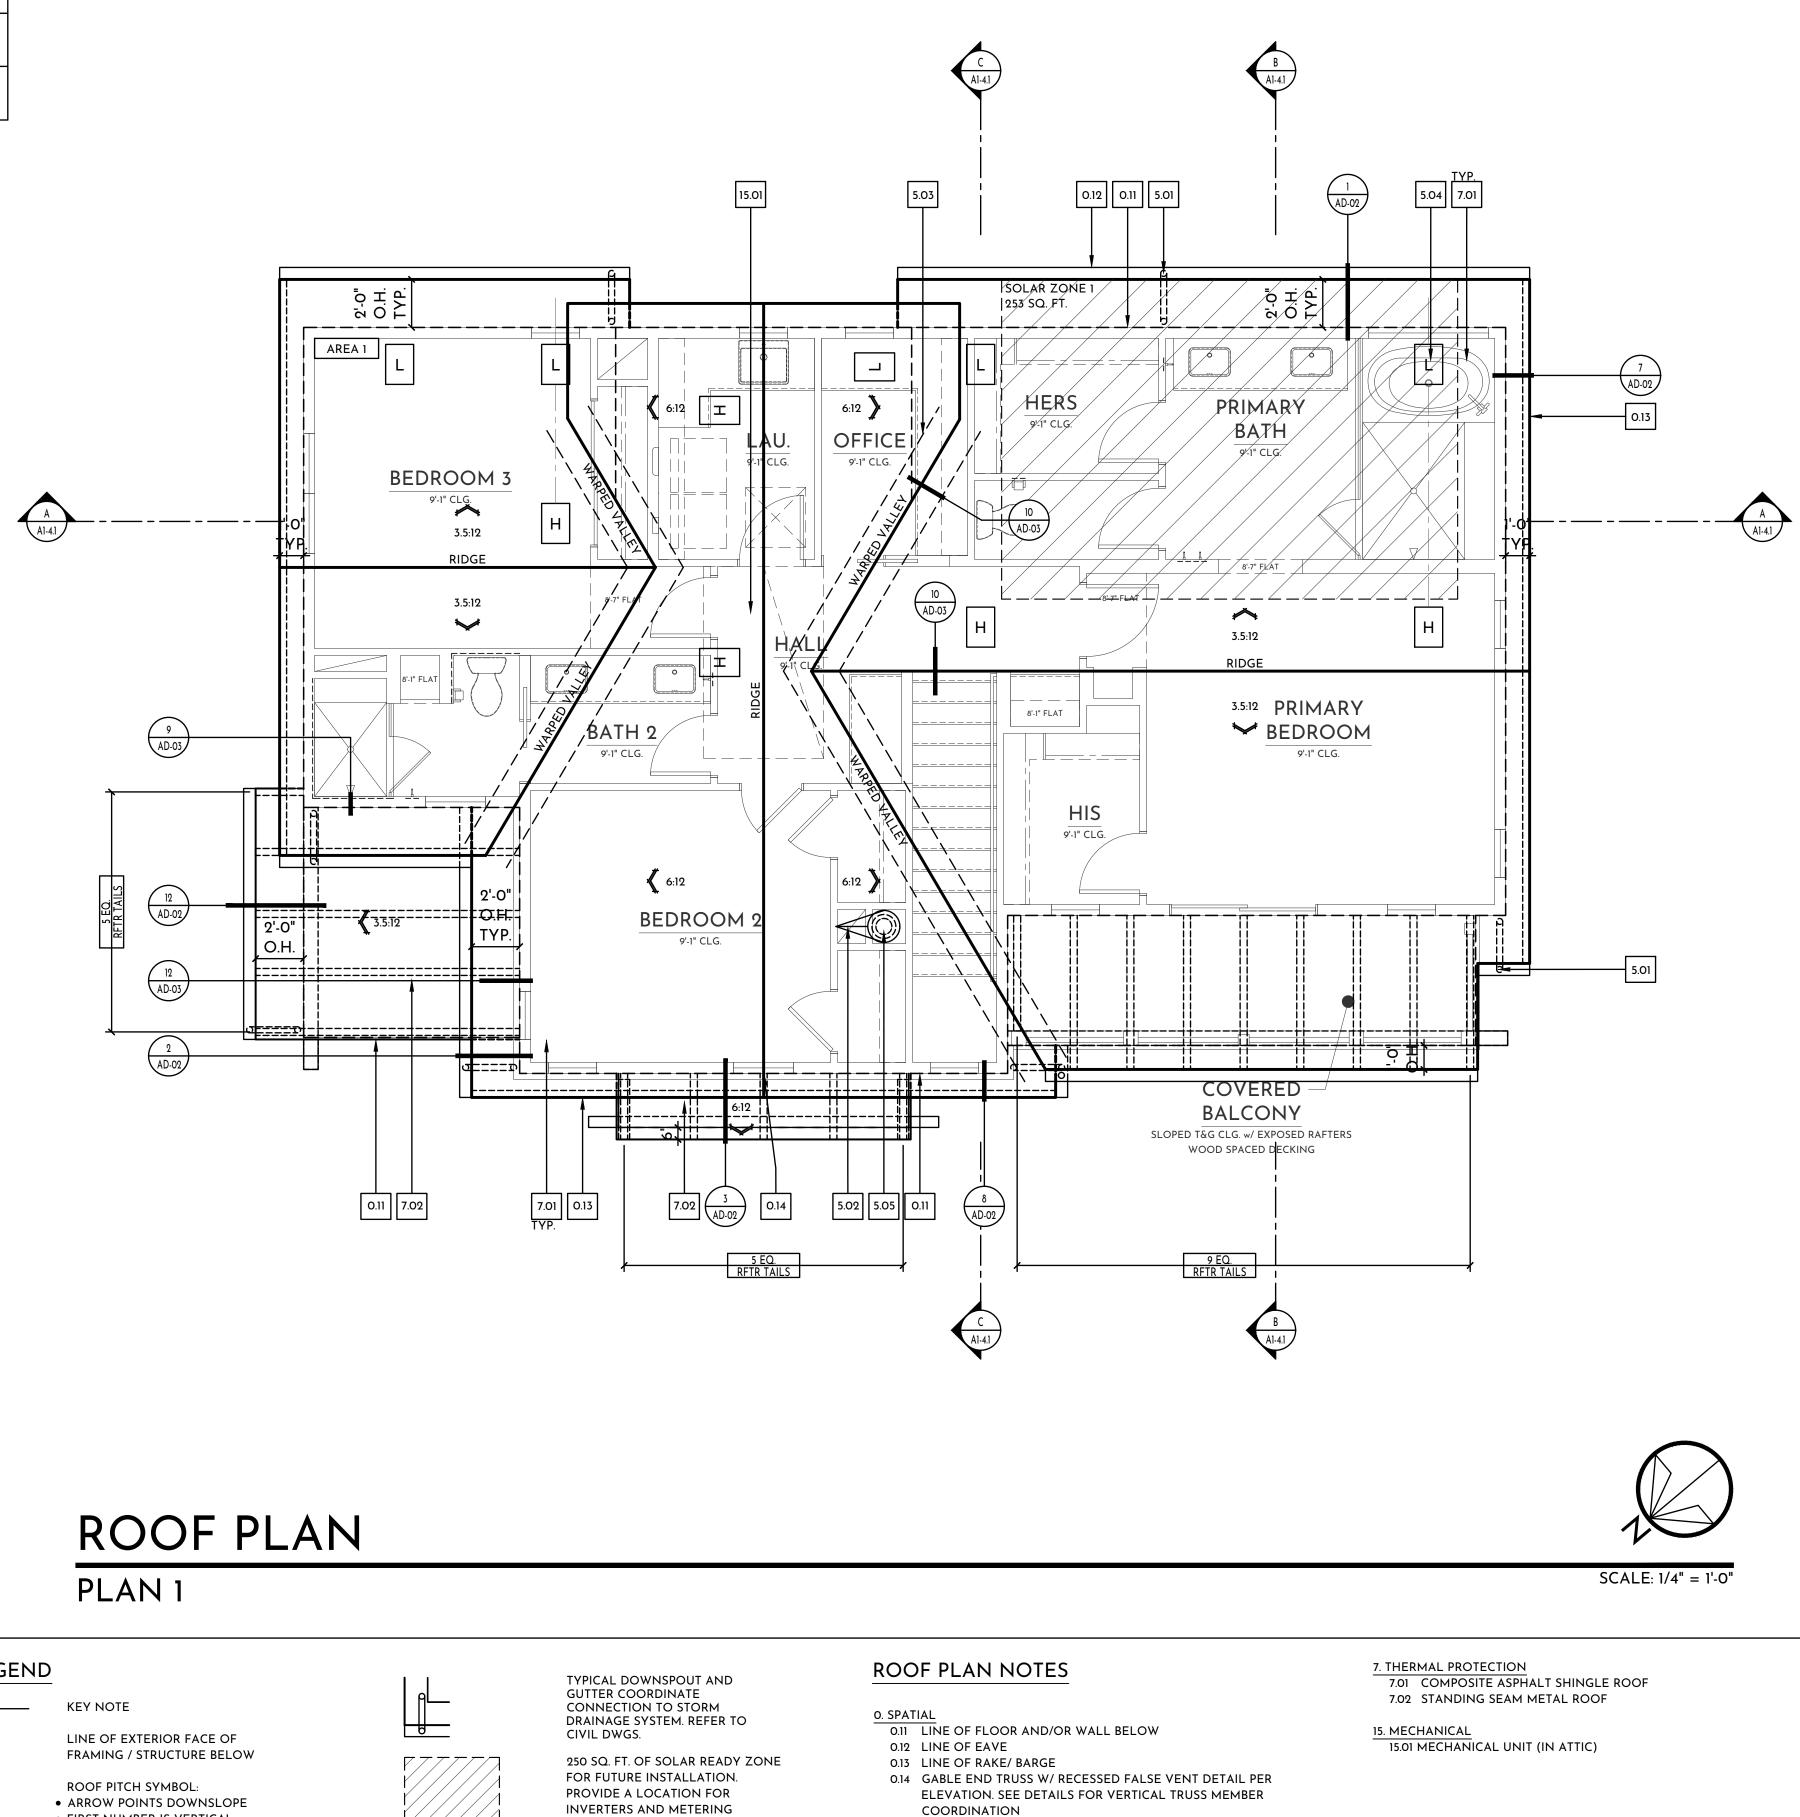


SYMBOL LEGEND

FIRST NUMBER IS VERTICAL

RISE SECOND NUMBER IS HORIZ. RUN

METAL VALLEY FLASHING

METAL SADDLE AND CRICKET FLASHING

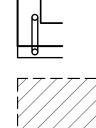


EQUIPMENT FOR FUTURE SYSTEMS ALONG w/ A PATHWAY FOR ROUTING CONDUIT FROM THE SOLAR ZONES TO THE POINT OF INTERCONNECTION w/ THE ELECTRICAL SERVICE AND PATHWAY FOR ROUTING OF PLUMBING FROM THE SOLAR ZONE TO THE WATER-HEATING SYSTEM.

5. METALS


5.01 LINE OF C.R. METAL GUTTER / DOWNSPOUT 5.02 C.R. METAL CRICKET/SADDLE FLASHING 5.03 C.R. METAL VALLEY FLASHING

- 5.04 O'HAGIN ROOF VENT
- 5.05 C.R. METAL DIRECT VENT CAP (INSTALL PER MANUFACTURER'S INSTRUCTIONS)

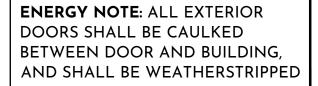

MESA STUDIO ARCHITECTURE & DESIGN WWW.MESASTUDIO.DESIGN 949.204.0076 STAMP: 11.30.2 RENEWAL 2280 ELDEN AVE. DEV. 24016 152 ALBERT PLACE LLC. **6** BUILDING DEPARTMENT SUBMITTAL: Ο IST SUBMITTAL 2ND SUBMITTAL 3RD SUBMITTAL S 4TH SUBMITTAL \cap A REVISIONS: U Ζ ZZ ROOF PLAN PLAN 1 MESA STUDIO, INC © 2025 - ALL RIGHTS RESERVED. THE DRAWINGS, DESIGNS, INFORMATION, CONTENT AND PROCEDURES DESCRIBED HEREIN ARE FOR THE EXCLUSIVE USE OF MESA STUDIO, INC. OR AFFILIATES, AND AS SUCH, ARE NOT TO BE REPRODUCED IN ANY FORM OR MEDIA, CURRENT OR FUTURE, OR DISCLOSED TO OTHERS WITHOUT THE WRITTEN CONSENT OF MESA STUDIO, INC. DISTRIBUTION OF DUPLICATION OF THESE DOCUMENTS IS NOT TO BE CONSTRUCTED AS PUBLICATION IN DEROGATION OF THERE RIGHTS. VISUAL CONTACT WITH THESE DOCUMENTS SHALL CONSTITUTE EVIDENCE OF ACCEPTANCE OF THESE RESTRICTIONS. SHEET NUMBER:

PLOT DATE:

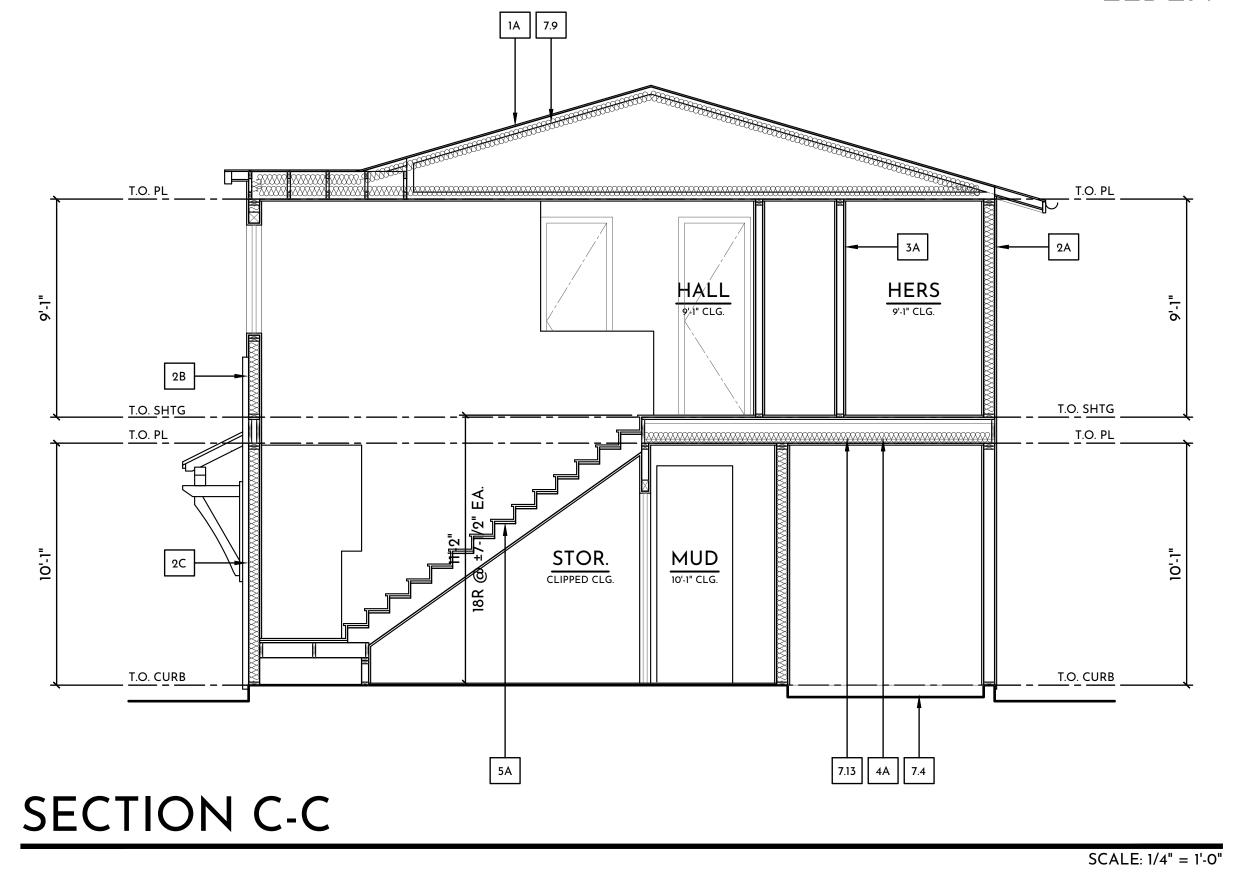

GENERAL NOTES

- HORIZONTAL AND VERTICAL DIMENSIONS SHOWN ARE FROM FACE 1. OF STUD OF FACE OF CONCRETE UNLESS NOTED OTHERWISE
- ANY DISCREPANCY FOUND IN THESE DRAWINGS IS TO BE BROUGHT
- TO THE ATTENTION OF THE ARCHITECT PRIOR TO ANY CONSTRUCTION FIRST FLOOR DIMENSIONS ARE FROM THE TOP OF HOUSE SLAB
- SECOND FLOOR DIMENSIONS ARE FROM THE TOP OF SUB FLOOR 4. SHEATHING
- REFER TO STRUCTURAL DRAWINGS FOR FRAMING MEMBER SPECIES, 5. GRADES, SIZES, SPACING, CONNECTIONS, ROOF AND FLOOR
- SHEATHING, SHEAR WALLS AND ADDITIONAL INFORMATION FOUNDATION: FOUNDATION IS TO BE A CONCRETE SLAB ON GRADE 6.
- SYSTEM (U.N.O). DESIGNED BY OTHERS 7. SOLE PLATES: SOLE PLATES SHALL BE PRESSURE TREATED

KEY NOTE x 🗕

SYMBOL LEGEND

SECTION NOTES


1A. SLOPED ROOF ASSEMBLY:

4

DETAIL REFERENCE


2.

- 2B. EXTERIOR WALL ASSEMBLY:
- ROOFING MATERIAL PER ROOF PLAN
- ROOFING UNDERLAYMENT FELT PER MFR'S SPEC'S ROOF SHEATHING - S.S.D.
- CALIFORNIA FRAMING (WHERE OCCURS)
- DESIGNED WOOD TRUSSES OR 2X RAFTERS
- INSULATION PER ENERGY CALCS 6.
- 2X WOOD FURRING (WHERE OCCURS) 7. 8. GYPSUM BOARD AT CEILING (OR FINISH PER INT. SPEC)

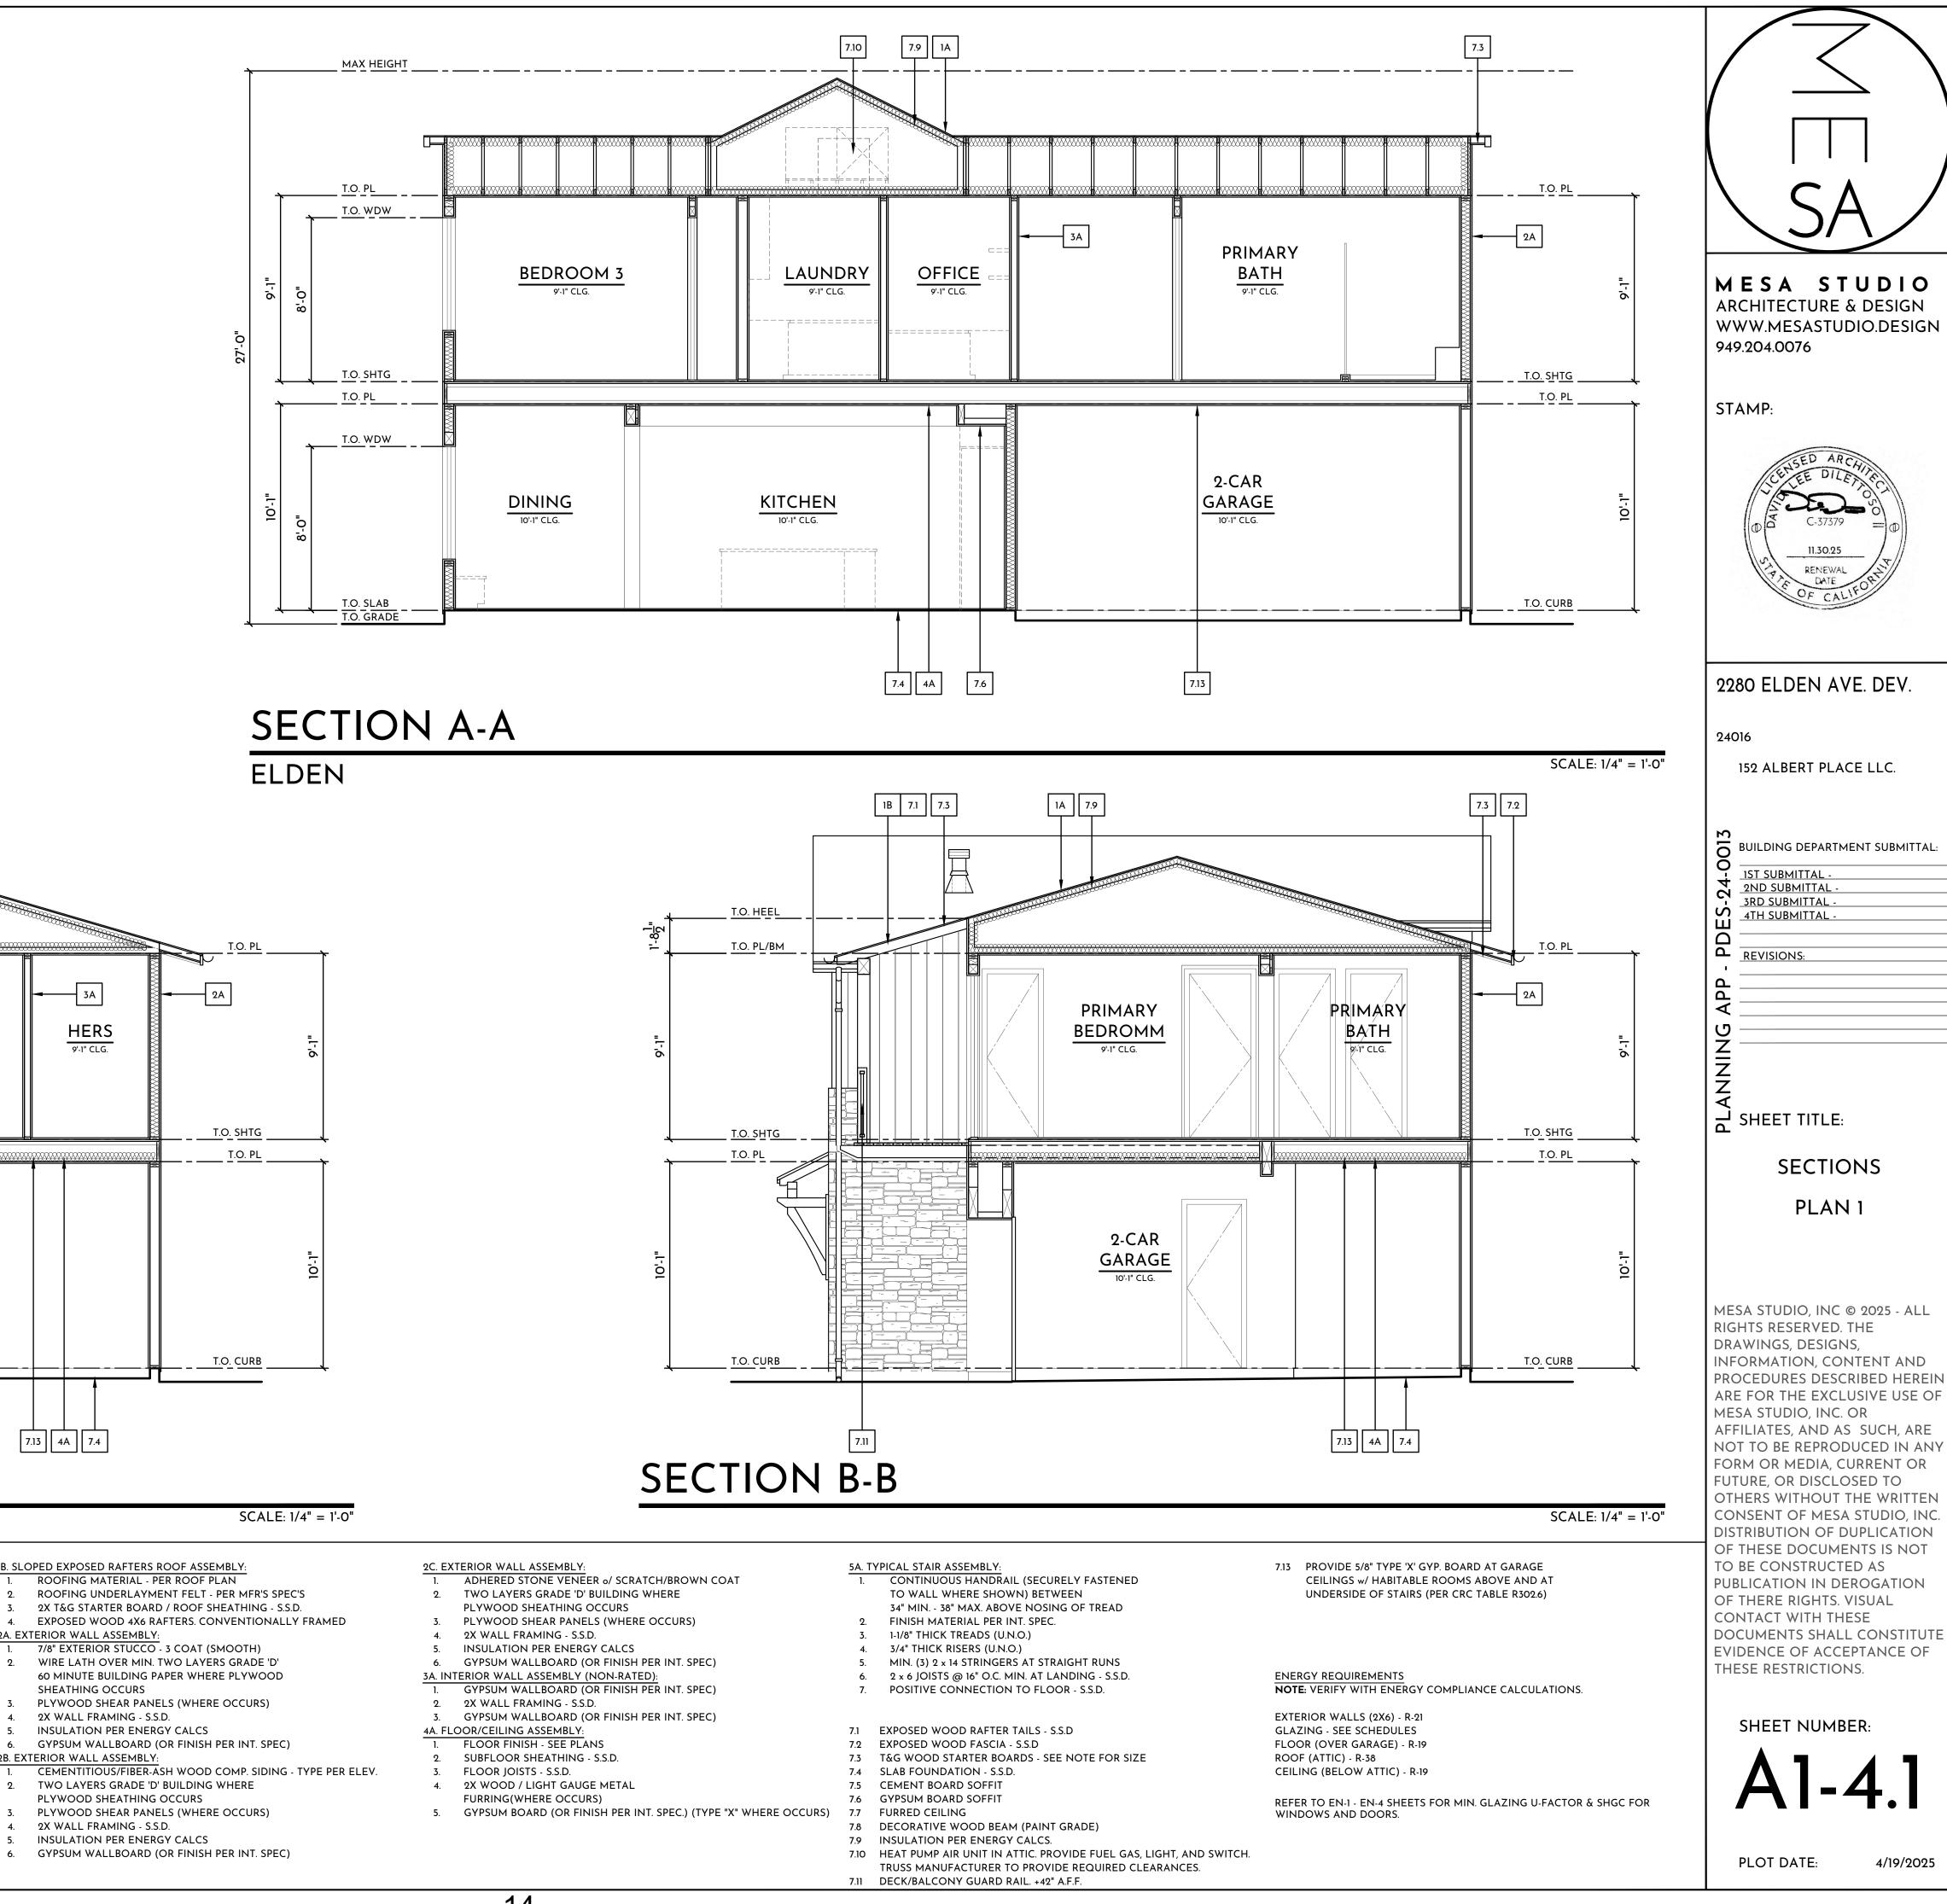


1B. SLOPED EXPOSED RAFTERS ROOF ASSEMBLY:

- ROOFING MATERIAL PER ROOF PLAN ROOFING UNDERLAYMENT FELT - PER MFR'S SPEC'S
- 3. 2X T&G STARTER BOARD / ROOF SHEATHING S.S.D. 4. EXPOSED WOOD 4X6 RAFTERS. CONVENTIONALLY FRAMED
- 2A. EXTERIOR WALL ASSEMBLY:
 - 7/8" EXTERIOR STUCCO 3 COAT (SMOOTH)
 - 60 MINUTE BUILDING PAPER WHERE PLYWOOD
- SHEATHING OCCURS 3. PLYWOOD SHEAR PANELS (WHERE OCCURS)
- 4. 2X WALL FRAMING S.S.D.
- INSULATION PER ENERGY CALCS
- 6. GYPSUM WALLBOARD (OR FINISH PER INT. SPEC)
- CEMENTITIOUS/FIBER-ASH WOOD COMP. SIDING TYPE PER ELEV. 2. TWO LAYERS GRADE 'D' BUILDING WHERE
 - PLYWOOD SHEATHING OCCURS
- 3. PLYWOOD SHEAR PANELS (WHERE OCCURS) 4. 2X WALL FRAMING - S.S.D.
- 5. INSULATION PER ENERGY CALCS
- 6. GYPSUM WALLBOARD (OR FINISH PER INT. SPEC)

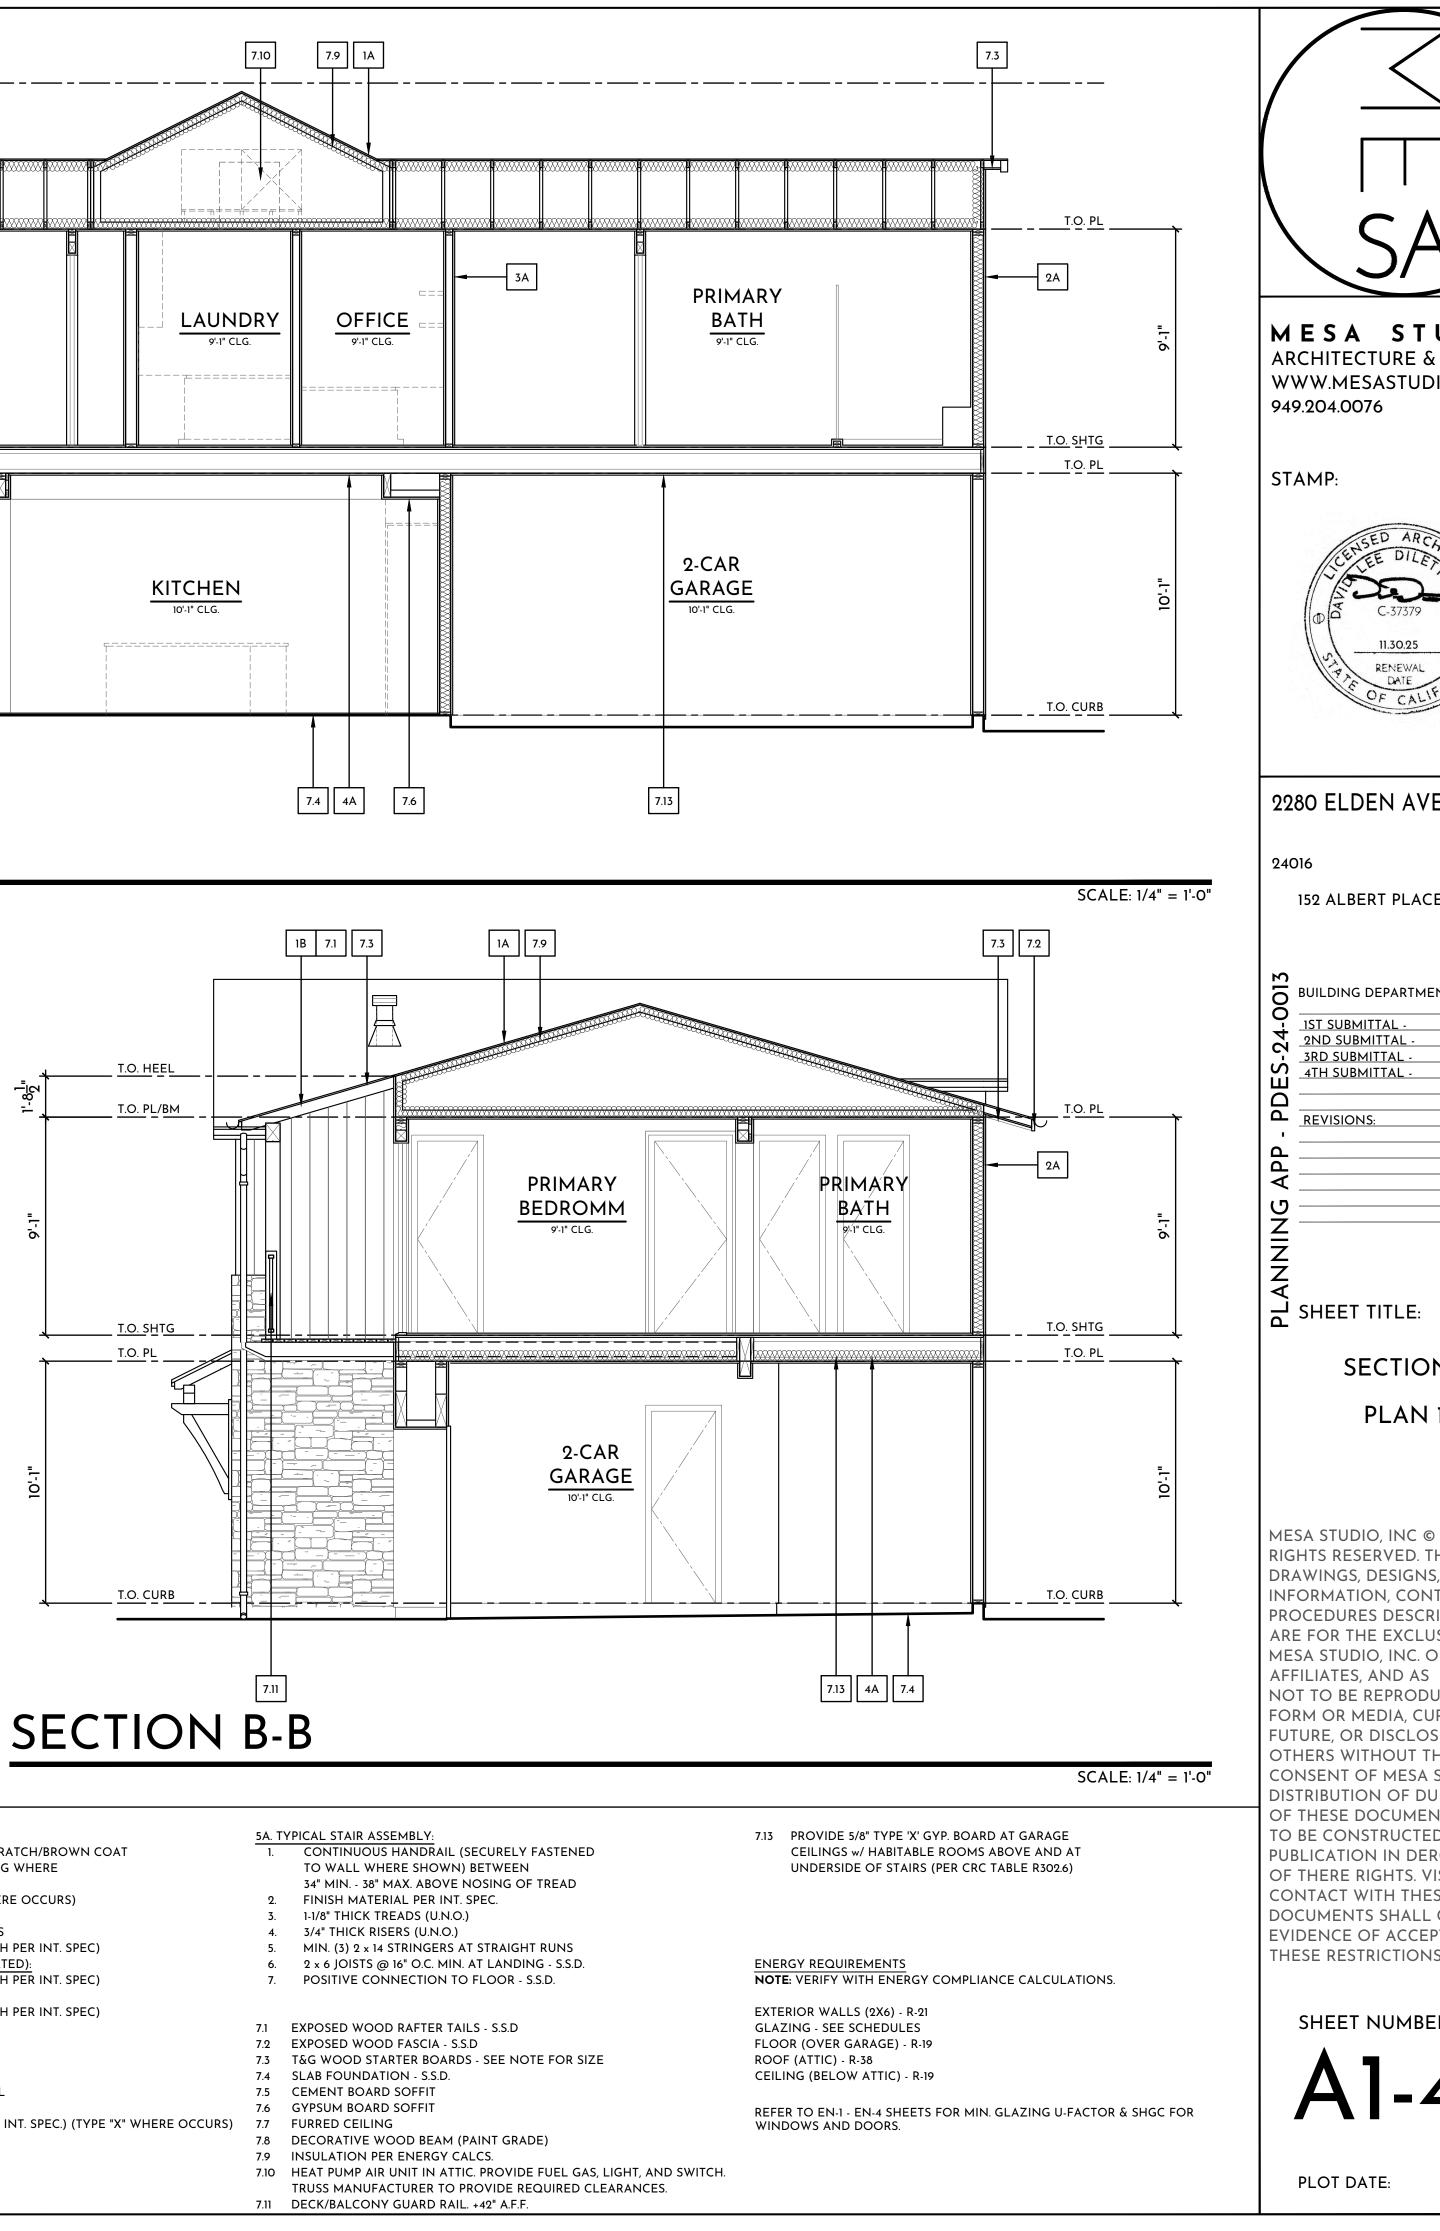

-14-

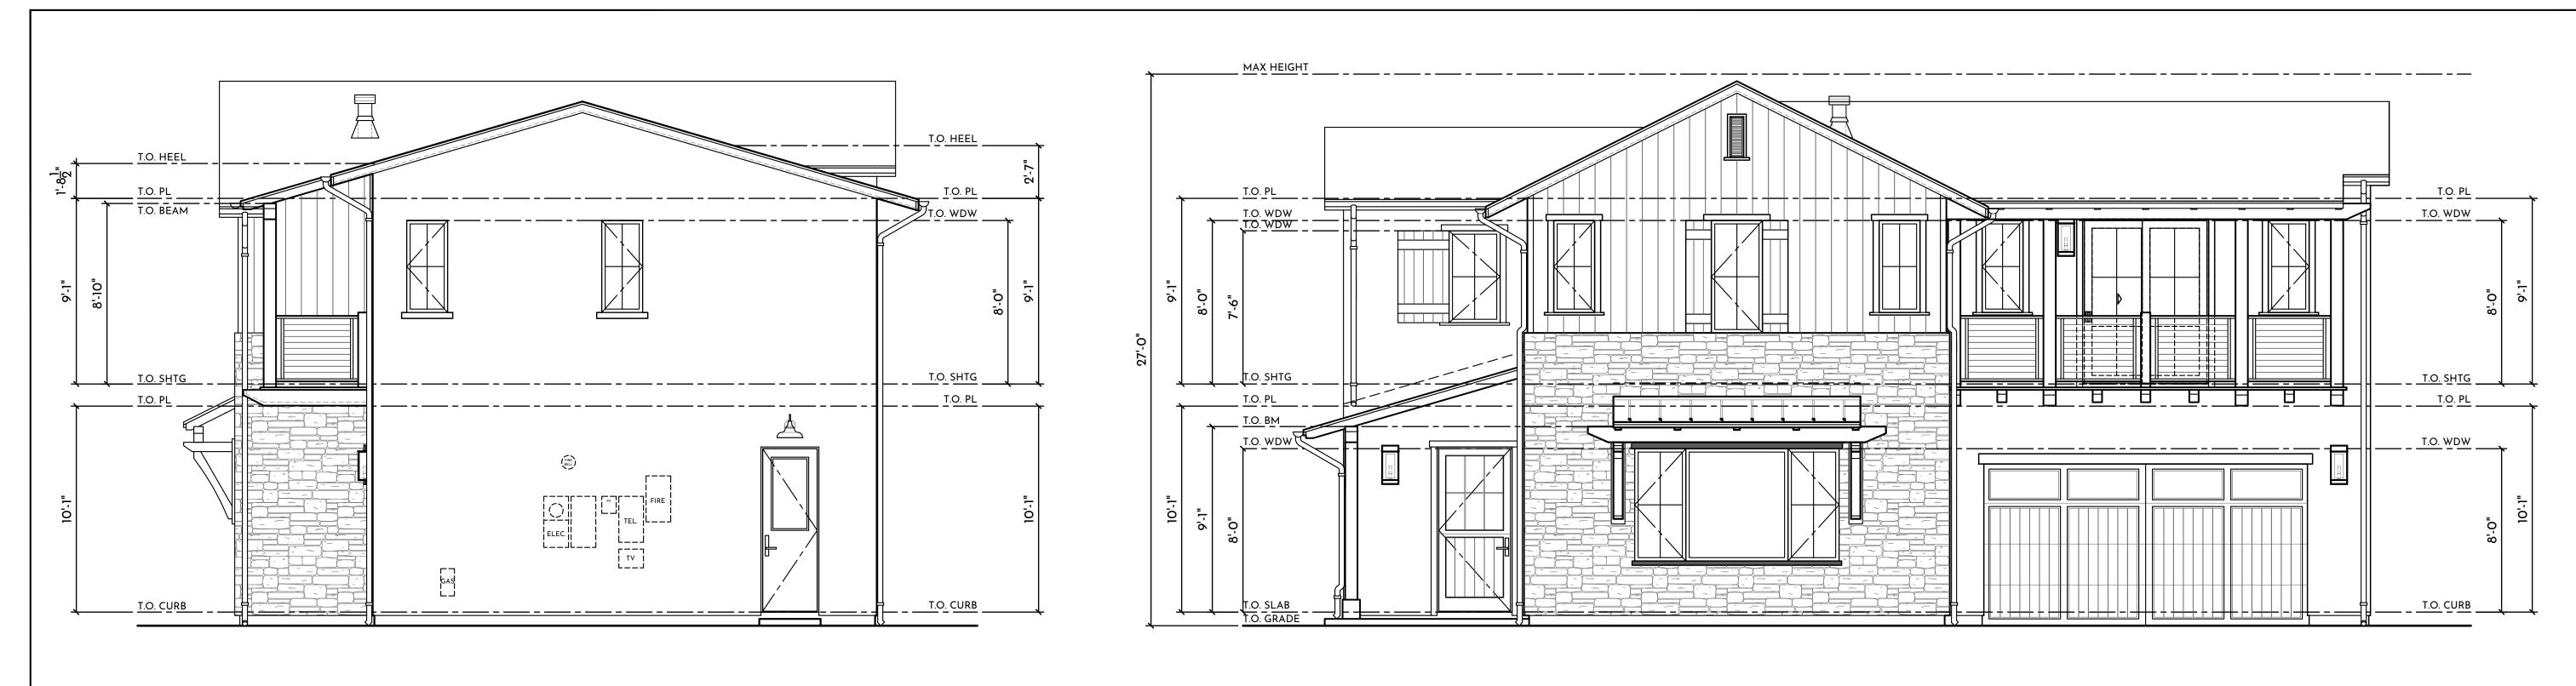

SOUTHWEST ELEVATION



(x)

XX-XX

NORTHEAST ELEVATION

GENERAL NOTES


- 1. HORIZONTAL AND VERTICAL DIMENSIONS SHOWN ARE FROM FACE OF STUD OF FACE OF CONCRETE UNLESS NOTED OTHERWISE 2. ANY DISCREPANCY FOUND IN THESE DRAWINGS IS TO BE BROUGHT
- TO THE ATTENTION OF THE ARCHITECT PRIOR TO ANY CONSTRUCTION 3. FIRST FLOOR DIMENSIONS ARE FROM THE TOP OF HOUSE SLAB
- 4. SECOND FLOOR DIMENSIONS ARE FROM THE TOP OF SUB FLOOR SHEATHING
- 5. ALL EXTERIOR PAVING AND SITE ELEMENTS ARE FOR REFERENCE ONLY.
- 6. ALL MECHANICAL EQUIPMENTS, ELECTRICAL FIXTURES, PLUMBING FIXTURES, AND STRUCTURAL MEMBERS ARE SHOWN FOR REFERENCE ONLY. REFER TO CONSULTANT'S DRAWINGS FOR DESIGN, DETAILS AND DIMENSIONS BY OTHERS.
- 7. CONTRACTOR TO COORDINATE PLUMBING, MECHANICAL, ELECTRICAL PENETRATIONS AND CONNECTIONS WITH SUBCONTRACTORS
- 8. ALL EQUIPMENT, APPLIANCES, AND FIXTURES TO BE INSTALLED PER MANUFACTURER'S INSTRUCTIONS.

SYMBOL LEGEND KEY NOTE X 🚽


DETAIL REFERENCE

0. SPATIAL 0.01 LINE OF WALL BEYOND 0.02 WALL OPENING 2.02 FINISH GRADE 3. CONCRETE 4. MASONRY

NORTHWEST ELEVATION

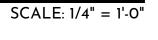

ELDEN

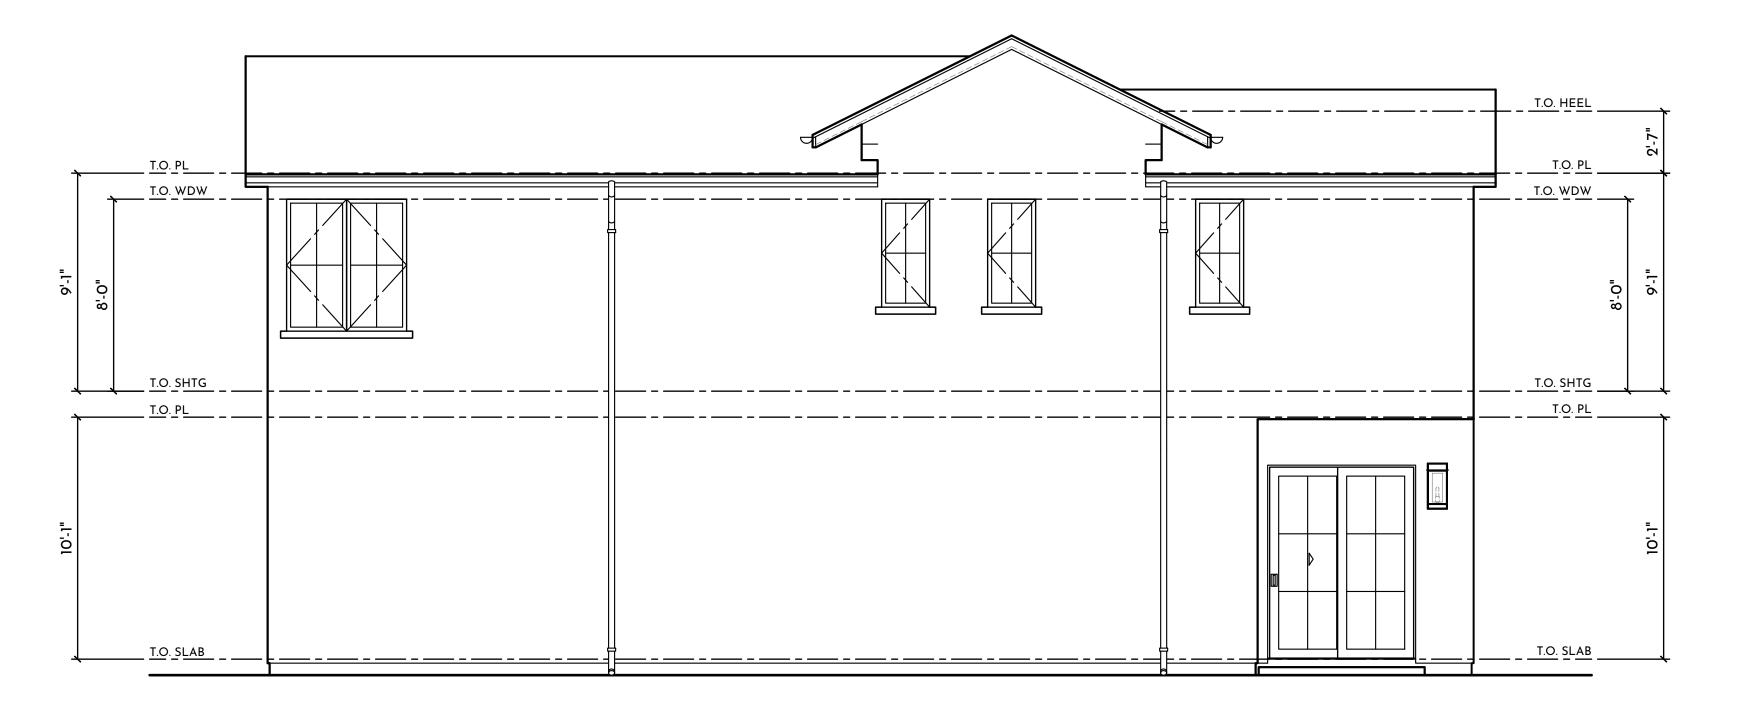

SOUTHEAST ELEVATION

SCALE: 1/4" = 1'-0"

ELEVATION NOTES

- 2. SITE 2.01 SITE WALL | GATE (SEE LANDSCAPE)
- 3.01 CONCRETE SLAB ON GRADE (SEE STRUCTURAL) 3.02 CONCRETE/HARDSCAPE STOOP (SEE LANDSCAPE)
- 4.01 THIN STONE VENEER (ADHERED) w/ MORTAR WASH
- (PLAN 1- WILDFLOWER BY CREATIVE MINES PLAN 2 - GRAND BANKS BY ELDORADO STONE OR APPROVED EQUAL) 4.02 PRECAST CONCRETE TRIM / HEADER (FOAM TRIM w/ SMOOTH PLASTER FINISH ALTERNATE)
- 5.01 C.R. METAL STUCCO WEEP SCREED, TYP. 5.02 C.R. METAL GUTTER, TYP.
- 5.03 C.R. METAL DOWNSPOUT. TIE INTO SITE DRAINAGE PER CIVIL
- 5.04 C.R. METAL FLASHING AT INTERSECTION 5.05 C.R. METAL FLASHING AT TOP OF ALL EXPOSED
- WOOD (TRIM INCLUDED)
- 5.06 LISTED C.R. METAL HORIZONTAL VENT TERMINATION CAP FOR GAS FIREPLACE. PER MANUF. SPECS. SET BOTTOM OF CAP MIN. 8'-0" A.F.H. 5.07 C.R. METAL GUARD AND RAILING SYSTEM. + 42" A.F.F.
- 5.08 STANDING SEAM METAL ROOF
- 5.09 RECESSED METAL LOUVER VENT (FAUX GABLE DETAIL)
- 6. WOOD

5. METALS

- 6.01 WOOD FASCIA
- 6.02 WOOD BARGE 6.03 WOOD RAFTER TAILS
- 6.04 2X WOOD TRIM
- 6.05 WOOD POST
- 6.06 SHAPED WOOD BEAM
- 6.07 WOOD CORBEL
- 6.08 WOOD GUARD AND RAILING SYSTEM. +42" A.F.F.
- 6.09 SHAPED WOOD KNEE BRACE | KICKER 6.10 WOOD TRIM BAND
 - -15-

7. EXTERIOR FINISHES

- 7.01 ROOFING MATERIAL (SEE ROOF PLANS) 7.02 3-COAT EXTERIOR PLASTER/STUCCO (SMOOTH FINISH)
- 7.03 PLASTER CONTROL JOINT 7.04 VERTICAL SIDING - 10X NICKEL-GAP (TRUEXTERIOR SIDING OR
- APPROVED EQUAL) 7.05 HORIZONTAL SIDING - 8X COVE | DUTCH LAP SIDING (TRUEXTERIOR
- SIDING OR APPROVED EQUAL) 7.06 WOOD (COMPOSITE ALTERNATE) SHUTTER
- 8. OPENINGS 8.01 ENTRY DOOR. REFER TO DOOR SCHEDULE 8.02 ACCESS DOOR. REFER TO DOOR SCHEDULE
- 8.03 SECTIONAL ROLL-UP GARAGE DOOR- WOOD GARAGE DOOR (STAIN GRADE)
- 15. MECHANICAL 15.01 A/C CONDENSER LOCATION

SCALE: 1/4" = 1'-0"

SCALE: 1/4" = 1'-0"

- 16. ELECTRICAL 16.01 LIGHT FIXTURE CARSON GOOSENECK WALL SCONCE 12" DOME -BLACK - 16" WALL PROJECTION BY REJUVENATION OR APPROVED EQUAL. SEE UTILITY PLAN FOR HEIGHT
- 16.02 LIGHT FIXTURE 1 FRESNO LARGE $\frac{3}{4}$ WALL LANTERN AGED IRON BY VISUAL COMFORT OR APPROVED EQUAL SEE UTILITY PLAN FOR HEIGHT
- 16.03 LIGHT FIXTURE 2 HALLE LARGE WALL LANTERN AGED IRON BY VISUAL COMFORT OR APPROVED EQUAL. SEE UTILITY PLAN FOR HEIGHT 16.04 ADDRESS SIGN, +66 AFF (U.N.O)

$\left \right\rangle$
$\setminus C \Delta$
MESA STUDIO ARCHITECTURE & DESIGN WWW.MESASTUDIO.DESIGN 949.204.0076
STAMP:
CENSED ARCHITAC
2280 ELDEN AVE. DEV.
24016
152 ALBERT PLACE LLC.
BUILDING DEPARTMENT SUBMITTAL: IST SUBMITTAL - 2ND SUBMITTAL - 3RD SUBMITTAL - 4TH SUBMITTAL - REVISIONS: REVISIONS: SHEET TITLE: ELEVATIONS PLAN 1
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SHEET NUMBER:
A1-51

PLOT DATE:

WINDOW SCHEDULE								
×	SIZE (WxH)	ТҮРЕ	FRAME	COLOR	MANUFACTURER (OR APPROVED EQUAL)	U-FACTOR	SHGC	REMARKS
2A	2'-0" x 4'-6"	CASEMENT	FIBERGLASS	BRONZE	MARVIN	0.29	0.20	
2B	10'-0" x 5'-6"	CASEMENT FIXED		1		0.29	0.22	2 - 2'-6"x5'-6" CASEMENT w/ 5'-0"x5'-6" FIXED, MULLED
2C	2'-6" x 4'-6"	CASEMENT				0.29	0.20	
2D	7'-6" x 4'-6"	BI-FOLD				0.28	0.18	3-PANEL BI-FOLD (ACCORDION) WINDOW. 3 - 2'-6"x4'-6
2E	4'-0" x 4'-6"	CASEMENT				0.29	0.20	2 - 2'-0"x4'-6" CASEMENT, MULLED
2F	5'-0" x 5'-6"	CASEMENT				0.29	0.20	2 - 2'-6"x5'-6" CASEMENT, MULLED
2G	5'-0" x 5'-0"	CASEMENT				0.29	0.20	2 - 2'-6"x5'-0" CASEMENT, MULLED
2H	2'-6" x 5'-6"	CASEMENT				0.29	0.20	
2J	2'-0" x 4'-0"	CASEMENT				0.29	0.20	
2K	2'-6" x 5'-0"	CASEMENT	V	V	₩	0.29	0.20	

2. ALL EXTERIOR WINDOWS SHALL COMPLY WITH CRC 337.8.2

3. CONFIRM ALL WINDOW U-FACTORS AND SHGCS WITH THE ENERGY COMPLIANCE FORMS

4. ALL - ROUGH OPENING VERIFY WITH MANUFACTURER 5. SIMULATED DIVIDED LIGHTS (WINDOW MUNTINS) PER EXTERIOR ELEVATIONS

DO	OR	SCł	HED	ULE

X	SIZE (WxH)	TYPE	THICKNESS	COLOR	MANUFACTURER (OR APPROVED EQUAL)	U-FACTOR	SHGC	REMARKS
201	3'-6" x 8'-0"	ENTRY DOOR		STAINED	CUSTOM	0.30	0.23	SOLID CORE w/ TEMPERED GLAZING, STAIN GRADE, WOOD ENTRY DOOR. FOR EGRESS
202	3'-0" x 8'-0"	FRENCH DOOR	1-3/4"	BRONZE	MARVIN	0.30	0.19	FRENCH DOOR w/ TEMPERED GLAZING
203	2'-8" x 8'-0"	SOLID CORE	1-3/4"	PAINTED		-	-	SOLID CORE, w/ TEMPERED GLAZING, PAINT GRADE, WOOD DOOR
204	16'-0" x 8'-0"	SECTIONAL GAR. DR.		STAINED		-	-	SOLID CORE, WOOD GARAGE DOOR - WOOD PANEL SECTIONAL GARAGE DOOR w/ AUTOMATIC OPENER
205	2'-8" x 8'-0"	SOLID WOOD	1-3/4"	PER INT.		N/A	N/A	SELF-CLOSING, SELF-LATCHING, TIGHT FIT
206	6'-0" x 8'-0"	SLIDING GLASS		BRONZE	MARVIN	0.30	0.19	2-PANEL SLIDING GLASS DOOR OX
21	2'-6" x 8'-0"	HINGED - INTERIOR	1-3/4"	PER INT.		N/A	N/A	SOLID CORE, PAINT GRADE, WOOD INTERIOR DOOR
22	2'-8" x 8'-0"	HINGED - INTERIOR	1-3/4"	PER INT.		N/A	N/A	SOLID CORE, PAINT GRADE, WOOD INTERIOR DOOR
23	3'-0" x 8'-0"	HINGED - INTERIOR	1-3/4"	PER INT.		N/A	N/A	SOLID CORE, PAINT GRADE, WOOD INTERIOR DOOR
24	2'-6" x 8'-0"	POCKET - INTERIOR	1-3/4"	PER INT.		N/A	N/A	SOLID CORE, PAINT GRADE, WOOD INTERIOR DOOR
25	2'-4" x 7'-0"	GLASS - INTERIOR				N/A	N/A	GLASS SWINGING DOOR - TEMPERED
26	6'-0" x 8'-0"	BYPASS - INTERIOR	1-3/4"	PER INT.		N/A	N/A	SOLID CORE, PAINT GRADE, WOOD INTERIOR DOOR
27	8'-0" x 8'-0"	BYPASS - INTERIOR	1-3/4"	PER INT.		N/A	N/A	SOLID CORE, PAINT GRADE, WOOD INTERIOR DOOR
28	2'-4" x 8'-0"	POCKET - INTERIOR	1-3/4"	PER INT.		N/A	N/A	SOLID CORE, PAINT GRADE, WOOD INTERIOR DOOR

DOOR NOTES

1. REFER TO FLOOR PLANS FOR TEMPERED GLASS (SAFETY LOCATIONS) AND EGRESS NOTATIONS

2. ALL EXTERIOR DOORS WITH GLAZING SHALL COMPLY WITH CRC 337.8.2 3. CONFIRM ALL DOORS U-FACTORS AND SHGCS WITH THE ENERGY COMPLIANCE FORMS


4. ALL - ROUGH OPENING VERIFY WITH MANUFACTURER

5. SIMULATED DIVIDED LIGHTS (DOOR MUNTINS) PER EXTERIOR ELEVATIONS

GENERAL NOTES

- HORIZONTAL AND VERTICAL DIMENSIONS SHOWN ARE FROM FACE 1.
- OF STUD OF FACE OF CONCRETE UNLESS NOTED OTHERWISE ANY DISCREPANCY FOUND IN THESE DRAWINGS IS TO BE BROUGHT 2.
- TO THE ATTENTION OF THE ARCHITECT PRIOR TO ANY CONSTRUCTION
- FOR FINISHES REFER TO INTERIOR DESIGNER'S SPEC. 3. 4. ALL MECHANICAL EQUIPMENTS, ELECTRICAL FIXTURES, PLUMBING FIXTURES, AND STRUCTURAL MEMBERS ARE SHOWN FOR REFERENCE
- ONLY. REFER TO CONSULTANT'S DRAWINGS FOR DESIGN, DETAILS AND DIMENSIONS BY OTHERS.
- CONTRACTOR TO COORDINATE PLUMBING, MECHANICAL, ELECTRICAL 5. PENETRATIONS AND CONNECTIONS WITH SUBCONTRACTORS
- 6. ALL EQUIPMENT, APPLIANCES, AND FIXTURES TO BE INSTALLED PER MANUFACTURER'S INSTRUCTIONS.
- PROVIDE THE FOLLOWING AT EGRESS WINDOWS: 5.7 SQ. FT. OF CLEAR 7. OPERABLE AREA; NET OPERABLE HEIGHT SHALL BE 24" MIN.; NET OPERABLE WIDTH SHALL BE 20" MIN,;BOTTOM OF CLEAR OPENING SHALL BE A MAX. HEIGHT OF +44".
- WINDOWS/DOORS TO HAVE LABEL INDICATING U-VALUE AND SHGC 8. PER ENERGY CALCS.
- CONTRACTOR TO PROVIDE/CONFIRM INSULATION IS PROVIDED 9. THROUGHOUT BUILDING ENVELOPE.


SYMBOL LEGEND

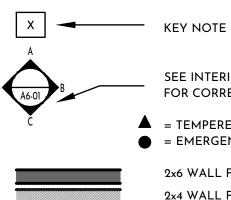


SEE INTERIOR ELEVATION SHEETS FOR CORRESPONDING VIEWS

▲ = TEMPERED GLASS = EMERGENCY EGRESS WINDOW

2x6 WALL FRAMING - S.S.D. 2x4 WALL FRAMING - S.S.D. GARAGE | DWELLING SEPARATION

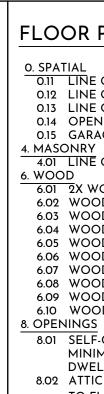

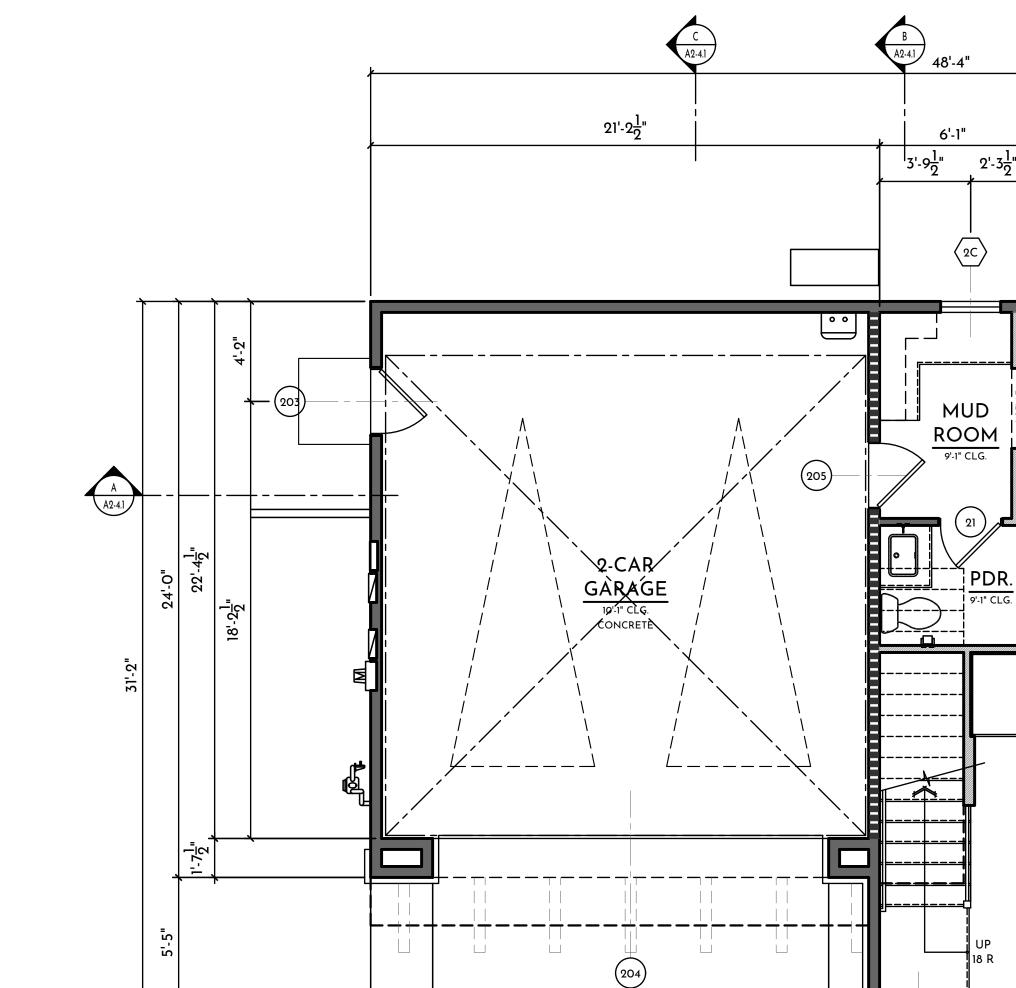

(204) :╆==== $\left(2A \right)$ ●▲(201) 3'-61'' 2'-1" 10'-2" 2'-1' 2'-7" 16'-6" 1'-8" 4'-9" 48'-4" B A2-4.1 A2-4.1

FIRST FLOOR

PLAN 2

FLOOR PLAN NOTES

- 0. SPATIAL 0.11 LINE OF FLOOR, DECK, AND/OR WALL ABOVE 0.12 LINE OF FLOOR AND/OR WALL BELOW 0.13 LINE OF CEILING CHANGE ABOVE
- 0.14 OPENING IN WALL 0.15 GARAGE CLEAR SPACE (10'-0"x20-0" MIN.)
- 4.01 LINE OF ADHERED STONE VENEER FINISH
- 6.01 2X WOOD FRAMING S.S.D.
- 6.02 WOOD HANDRAIL AT 34-38" ABOVE NOSING 6.03 WOOD GUARD AT 42" A.F.F.
- 6.04 WOOD CABINETRY UPPER CABINET 6.05 WOOD CABINETRY - LOWER CABINET
- 6.06 WOOD CABINETRY FULL HEIGHT CABINET
- 6.07 WOOD CABINETRY SHELVES
- 6.08 WOOD CABINETRY FULL HEIGHT CLOSET CABINET 6.09 WOOD CABINETRY - BUILT-IN BANQUETTE SEAT w/ STORAGE BELOW
- 6.10 WOOD SPACED DECKING
- 8.01 SELF-CLOSING, SELF-LATCHING, TIGHT FITTING, SOLID WOOD 1 3/8" MINIMUM THICK DOOR OR 20 MINUTE DOOR AT OPENINGS FROM DWELLING TO GARAGE 8.02 ATTIC ACCESS PANEL 30"X30" MIN CLR MAINTAIN 30"x30" CLEAR SPACE
- TO FLOOR BELOW OPENING

- 9. FINISHES
- 9.01 5/8" GYP. BOARD (1/2" MIN.) AT GARAGE SIDE TO RESIDENCE & AT GARAGE CEILINGS w/ HABITABLE ROOMS ABOVE (CRC TABLE R302.6)
- 9.02 DECORATIVE INTERIOR WALL/CEILING FINISH PER INT. DESIGNER 9.03 GYPSUM BOARD LOW WALL w/ WOOD CAP AT 42" A.F.F.
- 9.04 GYPSUM BOARD NICHE 9.05 COUNTERTOP - FINISH PER INT. DESIGNER
- 9.06 EXPOSED ROOF FRAMING, T&G UNDERSIDE. SEE STRUCT. 10. SPECIALITIES
- 10.01 MUDSET CERAMIC TILED SHAMPOO NICHE, 14" x 20"
- R.O. 48" A.F.F. 10.02 GAS APPLIANCE (FIREPLACE) - MEZZO 60 BY HEAT & GLO. DIRECT VENT, ELECTRIC IGNITION. ANSI Z 21.88-2017 OR APPROVED EQUAL 10.03 PROVIDE SOLID BLOCKING FOR FUTURE GRAB BAR REINFORCEMENT PER CRC 327.1.1 - SEE DETAIL 8/AD-12
- 11. EQUIPMENT 11.01 36" RANGE WITH OVEN BELOW
- 11.02 45" REFRIGERATOR SPACE
- 11.03 24" DISHWASHER 11.04 24" BUILT-IN MICROWAVE DRAWER (w/ TRIM KIT) 11.05 EXHAUST RANGE HOOD - VENT TO OUTSIDE AIR
- 12. FURNISHINGS
- 12.01 SHELF & POLE 12.02 SHELF & DOUBLE POLE
- 12.03 TOWEL BAR MOUNTED AT 54" A.F.F. 12.04 TOILET PAPER HOLDER MOUNTED AT 26" A.F.F.
- 12.05 TOWEL HOOK MOUNTED AT 54" A.F.F.
 - -16-


15. MECHANICAL / PLUMBING / ELECTRICAL 15.01 DROP-IN SINK WITH GARBAGE DISPOSAL 15.02 LAVATORY SINK

5'-0"

9'-1" FLAT

10'-1" CLC

- 15.03 LAUNDRY SINK
- ON LEFT SIDE OF DRYER 15.05 DRYER SPACE - ROUTE DUCT TO OUTSIDE AIR 15.06 HOT-MOPPED SHOWER w/ SHATTER RESISTANT GLASS SHOWER
- ENCLOSURE. PROVIDE NONABSORBENT AT ALL SURFACES IN PRIMARY SHOWERS / WET AREAS. SHOWER SEAT +20" AFF SLOPED 1/2" PER FOOT, WHERE OCCURS
- 15.07 SHATTER RESISTANT GLASS SHOWER DOOR 15.08 FREE STANDING TUB w/ FLOOR MOUNT TUB FILLER
- 15.09 WATER CLOSET (MIN. 30" WIDTH AT WALL & 24" MIN. CLEAR IN FRONT) 15.10 SHOWER HEAD - 82" AFF 15.11 GAS METER - REFER TO EXTERIOR ELEVATIONS FOR LOCATION.
- MAINTAIN 3'-0" CLEARANCE FROM ANY PIPING TO EDGE OF ELECTRICAL METER
- 15.12 ELECTRIC METER. MAINTAIN 3'-0" CLEAR FROM FACE OF PANEL TO ANY WALL SURFACE OR OBSTRUCTIONS.
- 15.13 CABLE TV/PHONE PANELS 15.14 HEAT PUMP AIR UNIT IN ATTIC. PROVIDE FUEL GAS, LIGHT, AND SWITCH
- 15.15 TANKLESS WATER HEATER BOTTOM @ 48" AF.F. REFER TO ENERGY REPORT FOR ENERGY FACTOR SPECS. INSTALL PER MANUFACTURER'S INSTRUCTIONS. 15.16 A/C CONDENSER UNIT
- 15.17 ELECTRICAL SUB-PANEL
- 15.18 MECHANICAL CHASE

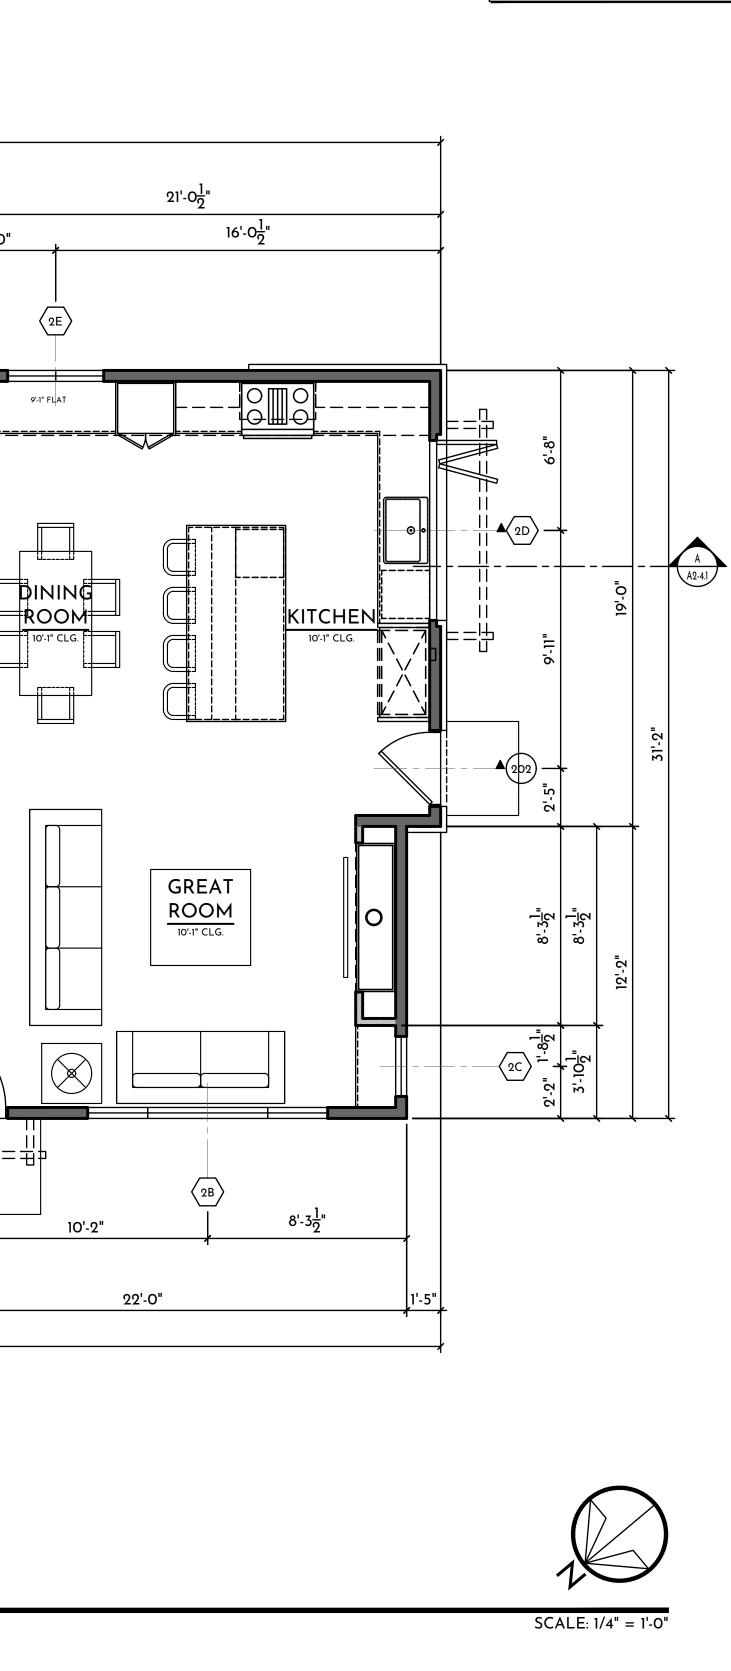

ENERGY NOTE: ALL EXTERIOR DOORS SHALL BE CAULKED

BETWEEN DOOR AND BUILDING, AND SHALL BE WEATHERSTRIPPED

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RIG DR/ INF PRC ARI ME AFF NO FOI FUI OTI CO DIS	SA STUDIO, INC © 2025 - ALL HTS RESERVED. THE AWINGS, DESIGNS, ORMATION, CONTENT AND DCEDURES DESCRIBED HEREIN E FOR THE EXCLUSIVE USE OF SA STUDIO, INC. OR FILIATES, AND AS SUCH, ARE T TO BE REPRODUCED IN ANY RM OR MEDIA, CURRENT OR FURE, OR DISCLOSED TO HERS WITHOUT THE WRITTEN NSENT OF MESA STUDIO, INC. TRIBUTION OF DUPLICATION THESE DOCUMENTS IS NOT
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4/19/2025

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15.04 WASHER SPACE - PROVIDE FLOOR DRAIN AND SMITTY PAN, INSTALL

AREA CALCULATIO	NS - PLAN 2
FIRST FLOOR (LIVE-ABLE)	835 SQ FT
SECOND FLOOR (LIVE-ABLE)	1,329 SQ FT
TOTAL (LIVE-ABLE)	2,164 SQ FT
GARAGE	474 SQ FT
OUTDOOR	

WINDOW SCHEDULE								
×	SIZE (WxH)	ТҮРЕ	FRAME	COLOR	MANUFACTURER (OR APPROVED EQUAL)	U-FACTOR	SHGC	REMARKS
2A	2'-0" x 4'-6"	CASEMENT	FIBERGLASS	BRONZE	MARVIN	0.29	0.20	
2B	10'-0" x 5'-6"	CASEMENT FIXED		1		0.29	0.22	2 - 2'-6"x5'-6" CASEMENT w/ 5'-0"x5'-6" FIXED, MULLED
2C	2'-6" x 4'-6"	CASEMENT				0.29	0.20	
2D	7'-6" x 4'-6"	BI-FOLD				0.28	0.18	3-PANEL BI-FOLD (ACCORDION) WINDOW. 3 - 2'-6"x4'-6
2E	4'-0" x 4'-6"	CASEMENT				0.29	0.20	2 - 2'-0"x4'-6" CASEMENT, MULLED
2F	5'-0" x 5'-6"	CASEMENT				0.29	0.20	2 - 2'-6"x5'-6" CASEMENT, MULLED
2G	5'-0" x 5'-0"	CASEMENT				0.29	0.20	2 - 2'-6"x5'-0" CASEMENT, MULLED
2H	2'-6" x 5'-6"	CASEMENT				0.29	0.20	
2J	2'-0" x 4'-0"	CASEMENT				0.29	0.20	
2K	2'-6" x 5'-0"	CASEMENT	V	V	₩	0.29	0.20	

2. ALL EXTERIOR WINDOWS SHALL COMPLY WITH CRC 337.8.2

3. CONFIRM ALL WINDOW U-FACTORS AND SHGCS WITH THE ENERGY COMPLIANCE FORMS

4. ALL - ROUGH OPENING VERIFY WITH MANUFACTURER 5. SIMULATED DIVIDED LIGHTS (WINDOW MUNTINS) PER EXTERIOR ELEVATIONS

DO	OR	SCł	HED	ULE

X	SIZE (WxH)	TYPE	THICKNESS	COLOR	MANUFACTURER (OR APPROVED EQUAL)	U-FACTOR	SHGC	REMARKS
201	3'-6" x 8'-0"	ENTRY DOOR		STAINED	СИЗТОМ	0.30	0.23	SOLID CORE w/ TEMPERED GLAZING, STAIN GRADE, WOOD ENTRY DOOR. FOR EGRESS
202	3'-0" x 8'-0"	FRENCH DOOR	1-3/4"	BRONZE	MARVIN	0.30	0.19	FRENCH DOOR w/ TEMPERED GLAZING
203	2'-8" x 8'-0"	SOLID CORE	1-3/4"	PAINTED		-	-	SOLID CORE, w/ TEMPERED GLAZING, PAINT GRADE, WOOD DOOR
204	16'-0" x 8'-0"	SECTIONAL GAR. DR.		STAINED		-	-	SOLID CORE, WOOD GARAGE DOOR - WOOD PANEL SECTIONAL GARAGE DOOR w/ AUTOMATIC OPENER
205	2'-8" x 8'-0"	SOLID WOOD	1-3/4"	PER INT.		N/A	N/A	SELF-CLOSING, SELF-LATCHING, TIGHT FIT
206	6'-0" x 8'-0"	SLIDING GLASS		BRONZE	MARVIN	0.30	0.19	2-PANEL SLIDING GLASS DOOR OX
21	2'-6" x 8'-0"	HINGED - INTERIOR	1-3/4"	PER INT.		N/A	N/A	SOLID CORE, PAINT GRADE, WOOD INTERIOR DOOR
22	2'-8" x 8'-0"	HINGED - INTERIOR	1-3/4"	PER INT.		N/A	N/A	SOLID CORE, PAINT GRADE, WOOD INTERIOR DOOR
23	3'-0" x 8'-0"	HINGED - INTERIOR	1-3/4"	PER INT.		N/A	N/A	SOLID CORE, PAINT GRADE, WOOD INTERIOR DOOR
24	2'-6" x 8'-0"	POCKET - INTERIOR	1-3/4"	PER INT.		N/A	N/A	SOLID CORE, PAINT GRADE, WOOD INTERIOR DOOR
25	2'-4" x 7'-0"	GLASS - INTERIOR				N/A	N/A	GLASS SWINGING DOOR - TEMPERED
26	6'-0" x 8'-0"	BYPASS - INTERIOR	1-3/4"	PER INT.		N/A	N/A	SOLID CORE, PAINT GRADE, WOOD INTERIOR DOOR
27	8'-0" x 8'-0"	BYPASS - INTERIOR	1-3/4"	PER INT.		N/A	N/A	SOLID CORE, PAINT GRADE, WOOD INTERIOR DOOR
28	2'-4" x 8'-0"	POCKET - INTERIOR	1-3/4"	PER INT.		N/A	N/A	SOLID CORE, PAINT GRADE, WOOD INTERIOR DOOR

DOOR NOTES

1. REFER TO FLOOR PLANS FOR TEMPERED GLASS (SAFETY LOCATIONS) AND EGRESS NOTATIONS

2. ALL EXTERIOR DOORS WITH GLAZING SHALL COMPLY WITH CRC 337.8.2 3. CONFIRM ALL DOORS U-FACTORS AND SHGCS WITH THE ENERGY COMPLIANCE FORMS


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GENERAL NOTES

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- OF STUD OF FACE OF CONCRETE UNLESS NOTED OTHERWISE ANY DISCREPANCY FOUND IN THESE DRAWINGS IS TO BE BROUGHT 2.
- TO THE ATTENTION OF THE ARCHITECT PRIOR TO ANY CONSTRUCTION
- FOR FINISHES REFER TO INTERIOR DESIGNER'S SPEC. 4. ALL MECHANICAL EQUIPMENTS, ELECTRICAL FIXTURES, PLUMBING FIXTURES, AND STRUCTURAL MEMBERS ARE SHOWN FOR REFERENCE
- ONLY. REFER TO CONSULTANT'S DRAWINGS FOR DESIGN, DETAILS AND DIMENSIONS BY OTHERS.
- CONTRACTOR TO COORDINATE PLUMBING, MECHANICAL, ELECTRICAL 5. PENETRATIONS AND CONNECTIONS WITH SUBCONTRACTORS
- 6. ALL EQUIPMENT, APPLIANCES, AND FIXTURES TO BE INSTALLED PER MANUFACTURER'S INSTRUCTIONS.
- PROVIDE THE FOLLOWING AT EGRESS WINDOWS: 5.7 SQ. FT. OF CLEAR 7. OPERABLE AREA; NET OPERABLE HEIGHT SHALL BE 24" MIN.; NET OPERABLE WIDTH SHALL BE 20" MIN,;BOTTOM OF CLEAR OPENING SHALL BE A MAX. HEIGHT OF +44".
- WINDOWS/DOORS TO HAVE LABEL INDICATING U-VALUE AND SHGC 8. PER ENERGY CALCS.
- CONTRACTOR TO PROVIDE/CONFIRM INSULATION IS PROVIDED 9. THROUGHOUT BUILDING ENVELOPE.


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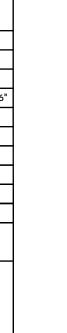



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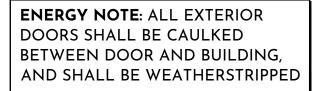



SECOND FLOOR PLAN 2
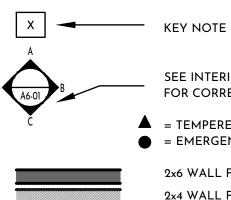
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- 6.01 2X WOOD FRAMING S.S.D.
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- PER CRC 327.1.1 SEE DETAIL 8/AD-12 11. EQUIPMENT 11.01 36" RANGE WITH OVEN BELOW
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- 12.05 TOWEL HOOK MOUNTED AT 54" A.F.F.
 - -17-

- 15. MECHANICAL / PLUMBING / ELECTRICAL 15.01 DROP-IN SINK WITH GARBAGE DISPOSAL 15.02 LAVATORY SINK
- 15.03 LAUNDRY SINK
- ON LEFT SIDE OF DRYER
- 15.05 DRYER SPACE ROUTE DUCT TO OUTSIDE AIR 15.06 HOT-MOPPED SHOWER w/ SHATTER RESISTANT GLASS SHOWER ENCLOSURE. PROVIDE NONABSORBENT AT ALL SURFACES IN PRIMARY SHOWERS / WET AREAS. SHOWER SEAT +20" AFF SLOPED 1/2" PER FOOT, WHERE OCCURS
- 15.07 SHATTER RESISTANT GLASS SHOWER DOOR 15.08 FREE STANDING TUB w/ FLOOR MOUNT TUB FILLER 15.09 WATER CLOSET (MIN. 30" WIDTH AT WALL & 24" MIN. CLEAR IN FRONT)
- 15.10 SHOWER HEAD 82" AFF
- 15.11 GAS METER REFER TO EXTERIOR ELEVATIONS FOR LOCATION. MAINTAIN 3'-0" CLEARANCE FROM ANY PIPING TO EDGE OF ELECTRICAL METER
- 15.12 ELECTRIC METER. MAINTAIN 3'-0" CLEAR FROM FACE OF PANEL TO ANY WALL SURFACE OR OBSTRUCTIONS.
- 15.13 CABLE TV/PHONE PANELS 15.14 HEAT PUMP AIR UNIT IN ATTIC. PROVIDE FUEL GAS, LIGHT, AND SWITCH
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- 15.17 ELECTRICAL SUB-PANEL
- 15.18 MECHANICAL CHASE

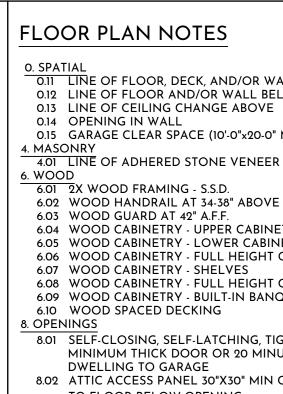

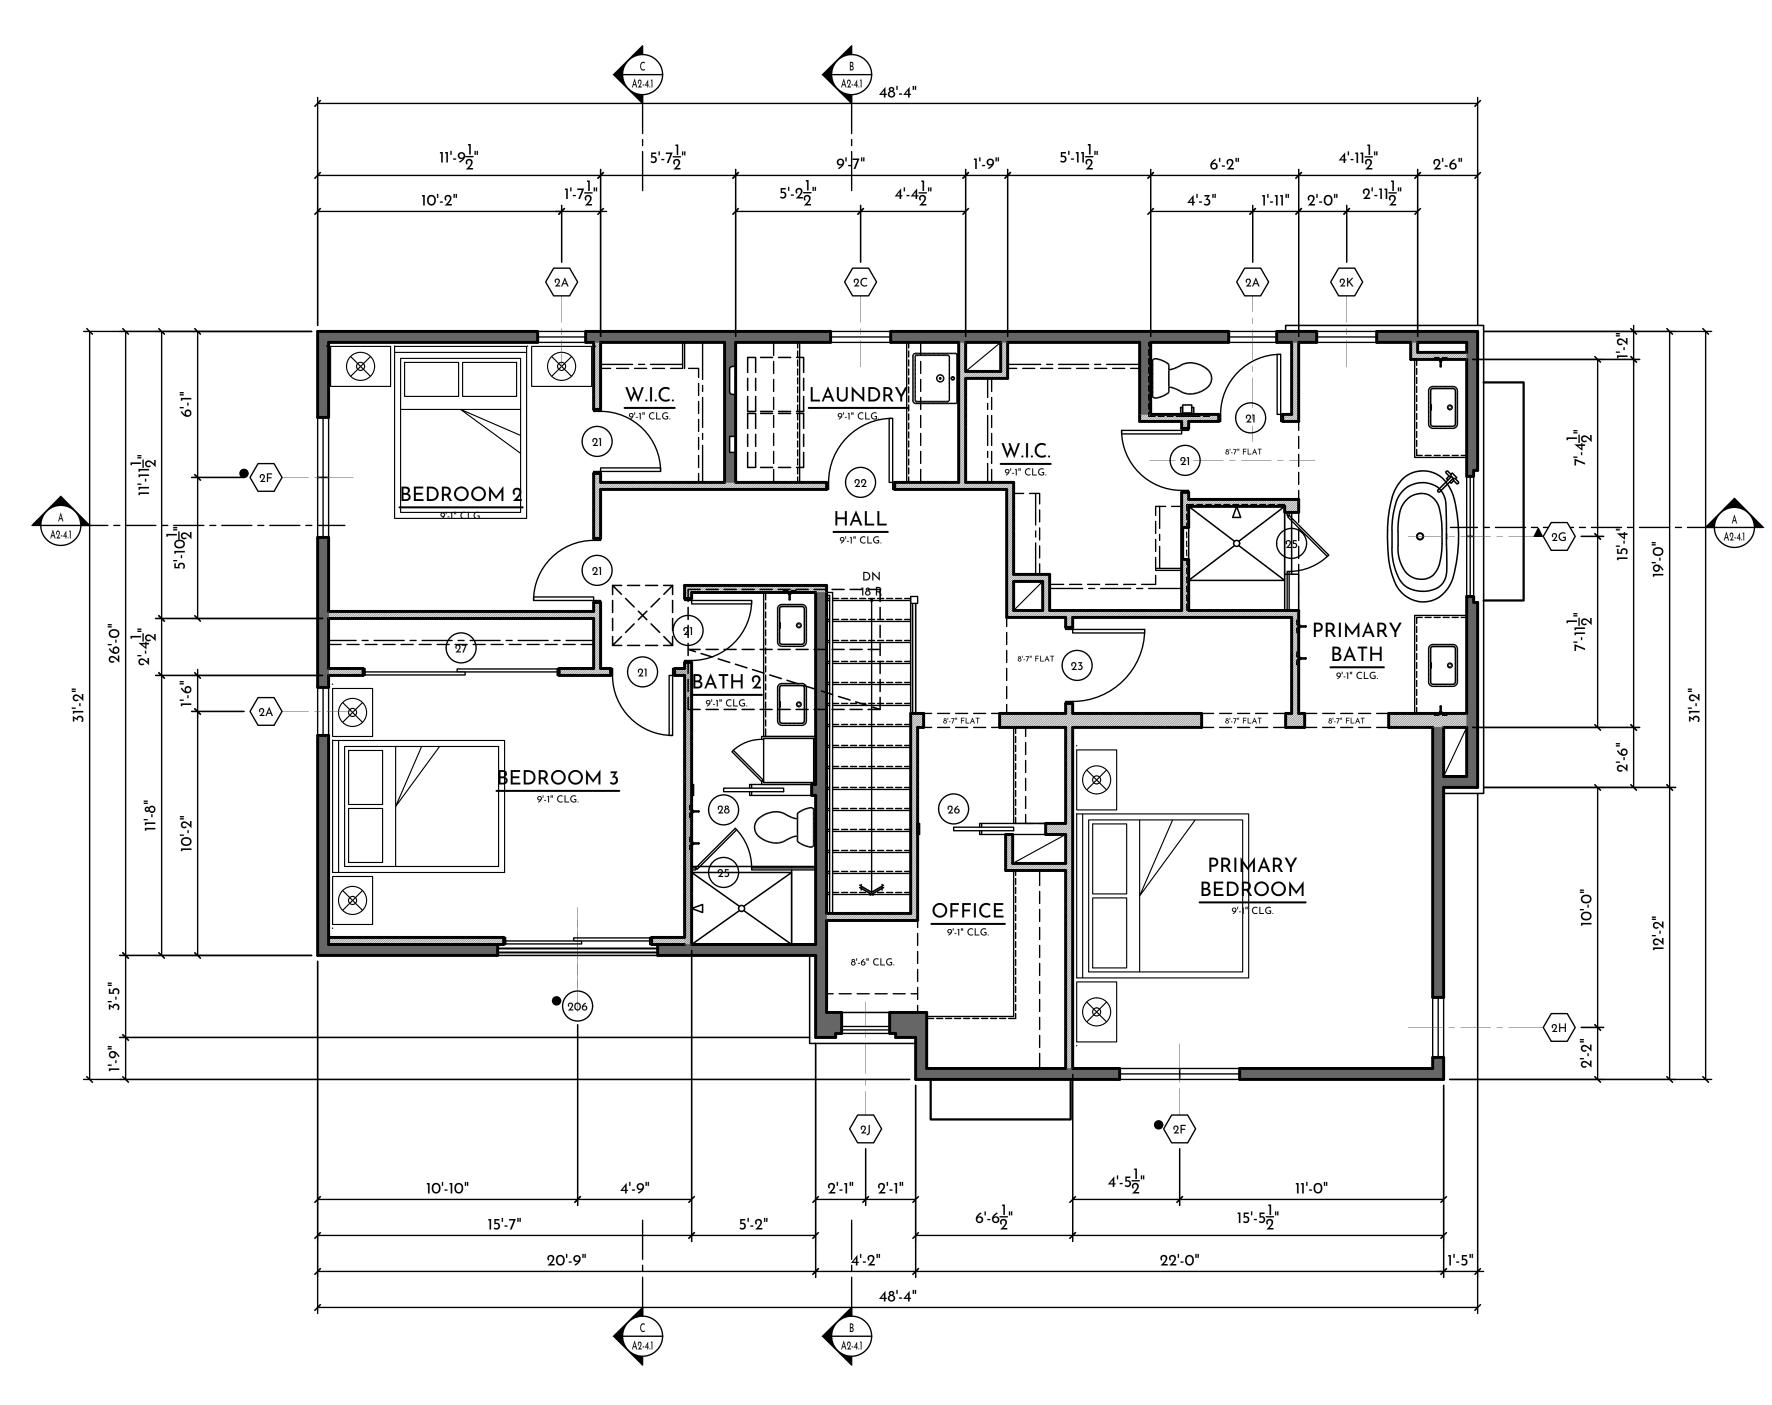

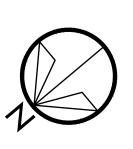SCALE: 1/4" = 1'-0"

AREA CALCULATION	NS - PLAN 2
FIRST FLOOR (LIVE-ABLE)	835 SQ FT
SECOND FLOOR (LIVE-ABLE)	1,329 SQ FT
TOTAL (LIVE-ABLE)	2,164 SQ FT
GARAGE	474 SQ FT
OUTDOOR	

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2280 ELDEN AVE. DEV.
24016 152 ALBERT PLACE LLC.
BUILDING DEPARTMENT SUBMITTAL: IST SUBMITTAL - 2ND SUBMITTAL - 3RD SUBMITTAL - 4TH SUBMITTAL - REVISIONS:
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NNNA ANNA A
2ND FLOOR PLAN
PLAN 2
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PLOT DATE: 4/19/2025

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- 15.04 WASHER SPACE PROVIDE FLOOR DRAIN AND SMITTY PAN, INSTALL

AREA	A		В	C			D
	ATTIC AREA	(SQ. IN.)		VENTS w/ $\frac{1}{8}$ " MESH O'HAGIN VENT=72 (SQ. IN.)		TOTAL VENTING PROVIDED (SQ. IN.)	
	(SQ. FT.)						
		330	HIGH	(5)72=360	HIGH	360	HIGH
AREA 1	1,375	330	LOW	(5)72=360	LOW	360	LOW
REQUIRED AT	TIC VENTILATION						
DIVIDE BY 2 TO 3 VENTING REQUI FREE VENTING F (AT LEAST 40% A REQUIRED VENT HIGH VENTS LO VERTICALLY BEI OF THE SPACE, V PROVIDED BY EA DIVIDE (A) BY 15 CALCULATE THE FREE VENTING A	AREA IN SQUARE INCHES. SET THE MAXIMUM NET FRE RED HIGH AND THE MINIMU REQUIRED LOW. AND NO MORE THAN 50% O TING AREA SHALL BE PROVI CATED NO MORE THAN 3 FI LOW THE RIDGE OR HIGHES WITH THE BALANCE OF VEN AVE/LOW VENTS). O AND MULTIPLY BY 144 TO E TOTAL REQUIRED MINIMU AREA IN SQUARE INCHES. VENTING REQUIREMENTS V	JM NET F THE DED BY EET T POINT ITING M NET					
AREA PROVIDED IN. OF FREE ARE PRIMARY VENT S	INCHES OF NET FREE VENT D BY O'HAGIN ROOF AIR VEN A MIN. EACH VENT) PROVIE SUB-FLASHING w/ 6" FLANGE GH SIDE. VENT FLASHING TO	NTS. (72 SQ. DE O'HAGIN E AND					
G.I.							

HIGH VENT

LOW VENT


VENT NOT REQ. TO MEET HIGH OR LOW

GENERAL NOTES


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- PENETRATIONS AND CONNECTIONS WITH SUBCONTRACTORS ALL EQUIPMENT, APPLIANCES, AND FIXTURES TO BE INSTALLED PER 5.
- MANUFACTURER'S INSTRUCTIONS. 6. ALL ROOFING TO BE A MINIMUM CLASS A (REFLECTANCE = 0.10 &
- EMISSIVITY = 0.85)COMPOSITION ROOF: -GAF TIMBERLINE HD (ESR 1475) OR 'APPROVED EQUAL' STANDING SEAM METAL ROOF:
- -TAYLOR METAL EASY LOCK 24 GAUGE 16" SEAM (UL ER#25913-01)
- 7. PROVIDE THE FOLLOWING MINIMUM DIMENSIONS FOR VERTICAL LEG

ON ROOF UNDERSHOTS: 8" AT COMPOSITION SHINGLE ROOFS.

- PLUMBING VENTS, EXHAUST VENTS OR SIMILAR TERMINATION 8. ACCESSORIES SHALL BE ROUTED TO A PLANE ON THE ROOF THAT IS LEAST VISIBLE FROM PUBLIC VIEW AND GROUPED TOGETHER WHEN POSSIBLE. IT IS THE CONTRACTOR'S RESPONSIBILITY TO NOTIFY THE ARCHITECT PRIOR TO INSTALLATION AND CONFIRM LOCATION. ALL EXPOSED METAL ON ROOF SHALL BE CORROSION RESISTANT
- AND BE PAINTED TO MATCH THE COLOR OF THE ROOF MATERIAL U.N.O.
- 10. ALL PENETRATIONS IN VALLEYS SHALL BE LOCATED 18" MIN. OUTSIDE VALLEY WATERWAYS, AND 18" MIN. FROM OTHER PENETRATIONS OR PROJECTIONS, SUCH AS PIPES, WALLS, CURBS, ETC. ALL PENETRATIONS SHALL BE OFFSET 18" MIN. FROM WATERWAY TERMINATIONS SUCH AS VALLEY ENDS AND TILE PAN ENDS, ETC. ALL PENETRATIONS SHALL BE VERTICALLY PLUMB THROUGH ROOF SHEATHING AND EXTEND 12" MIN. ABOVE SHEATHING. 26 GA. MIN. METAL FLASHING (TYP.)
- FRAMER TO PROVIDE VENTILATION TO AREAS OF ATTIC ISOLATED BY 11. OVER-FRAMING, PROVIDE A 22"X30" ACCESS WAY AT OVER-FRAMING THAT IS OVER 30" CLEAR IN HEIGHT.

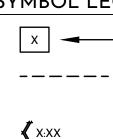

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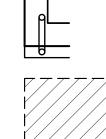
SYMBOL LEGEND

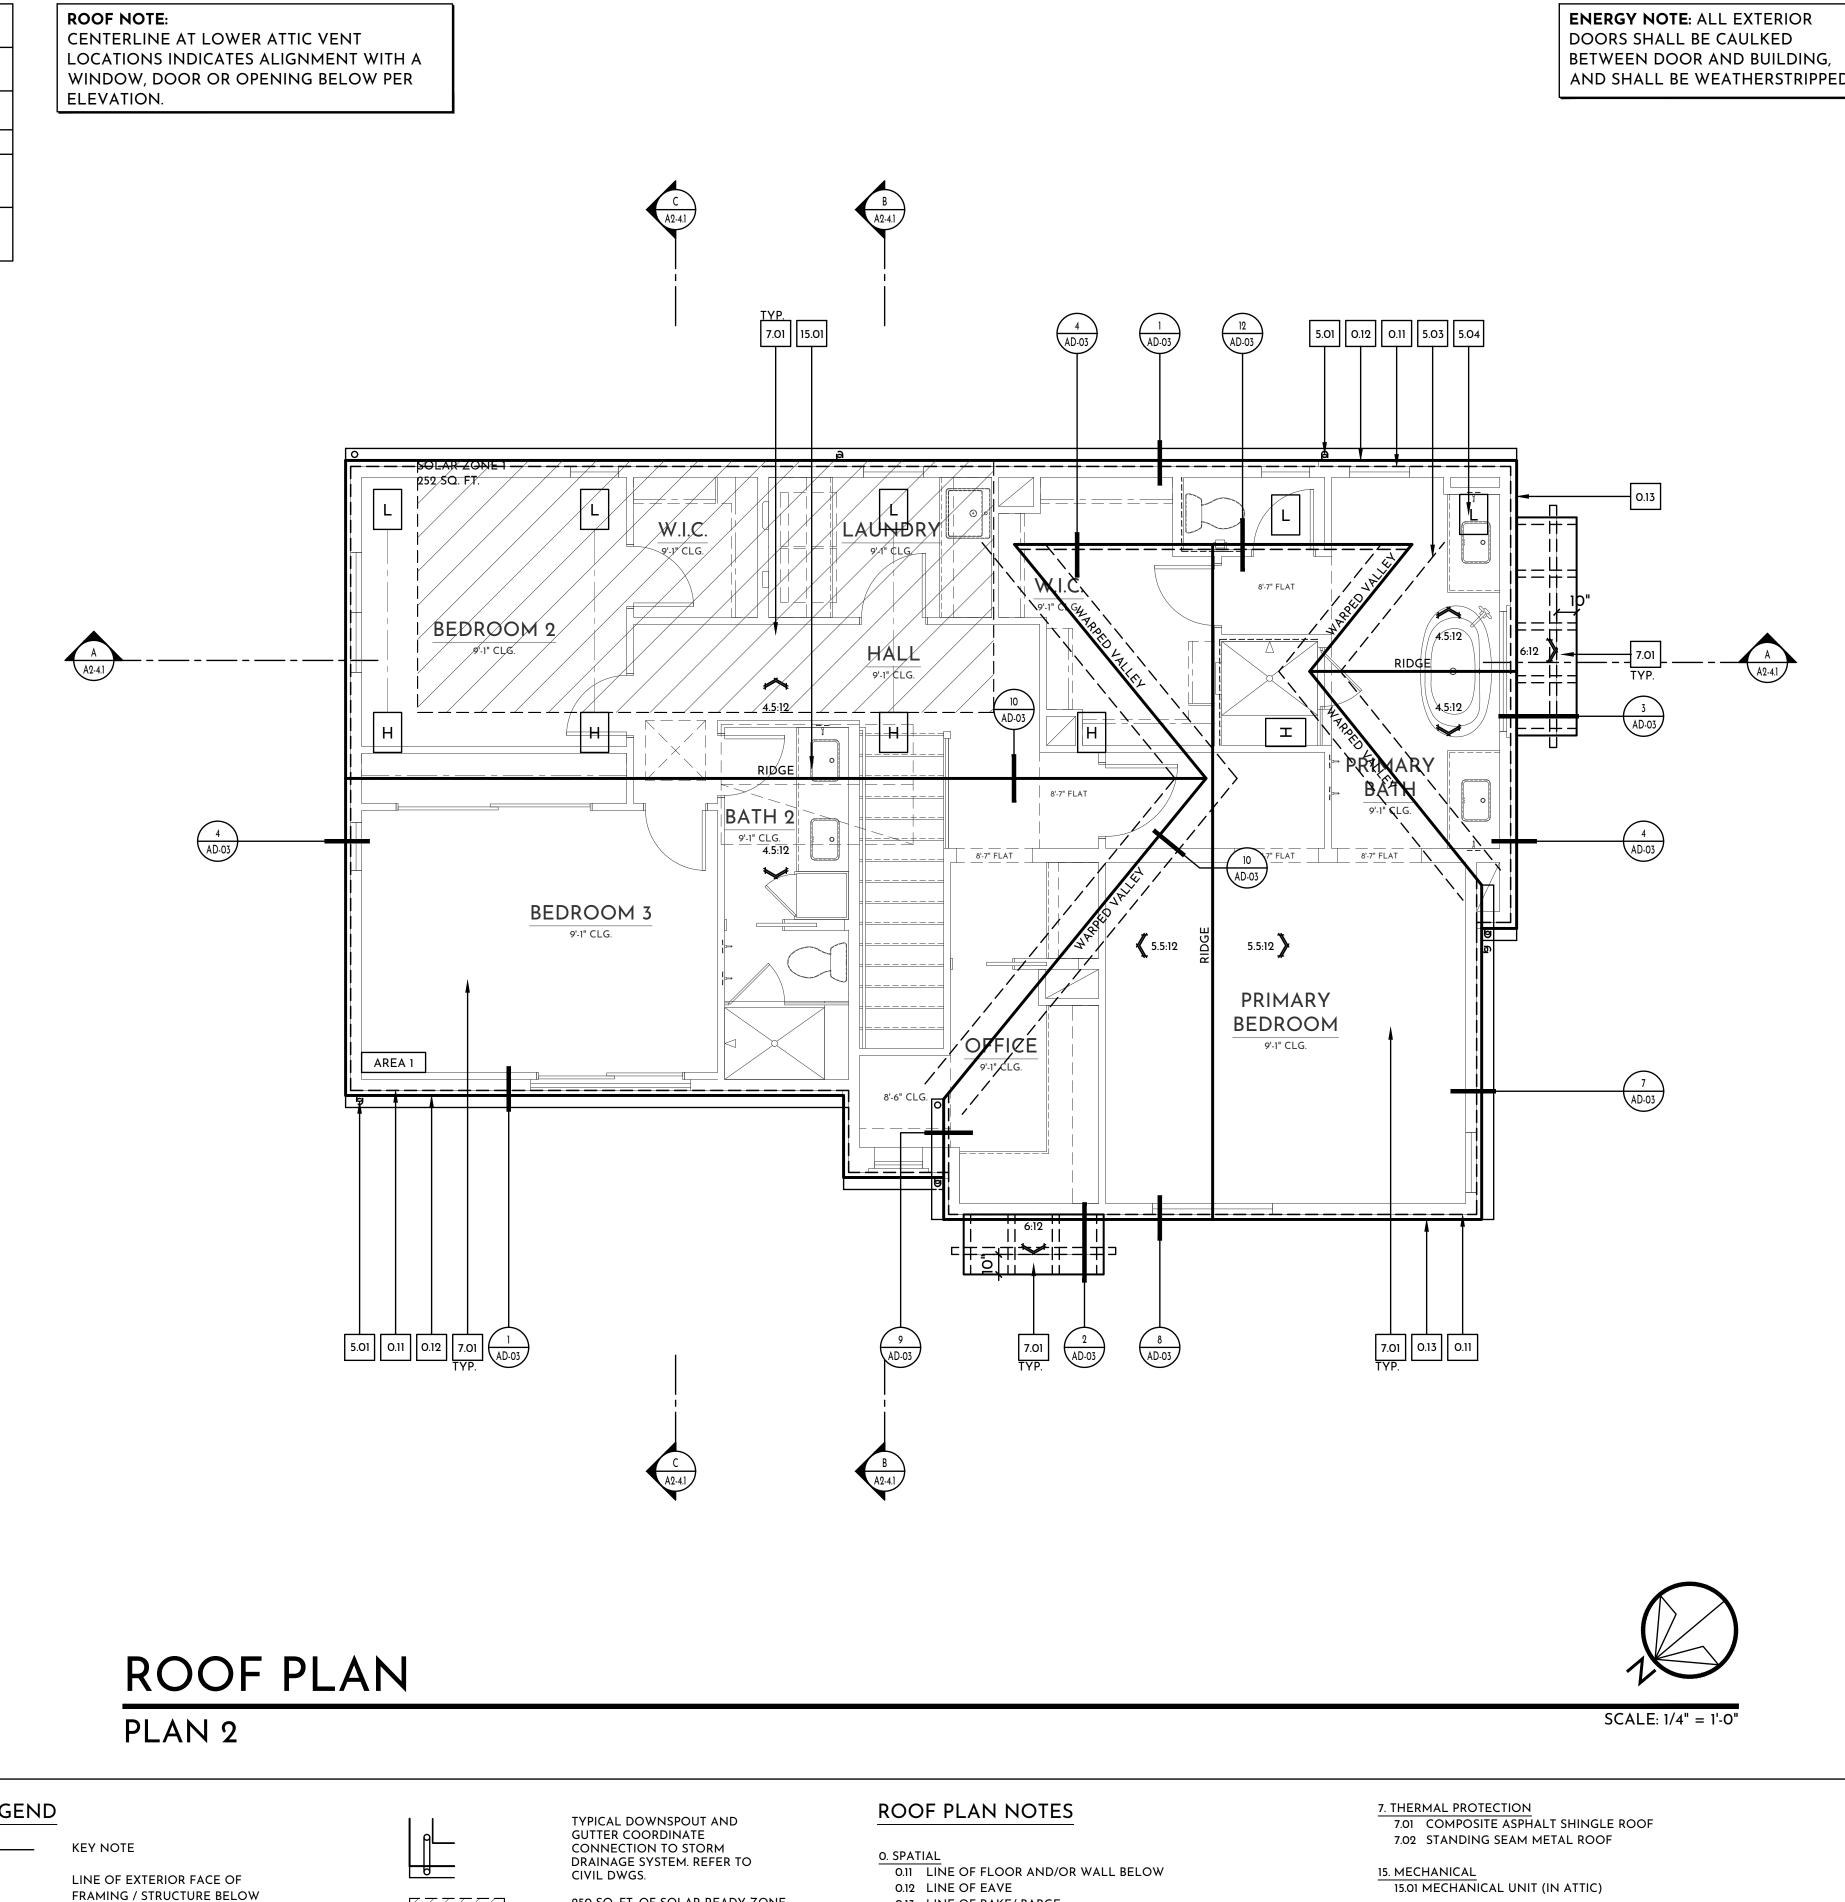ROOF PITCH SYMBOL: ARROW POINTS DOWNSLOPE FIRST NUMBER IS VERTICAL

RISE SECOND NUMBER IS HORIZ. RUN

METAL VALLEY FLASHING

METAL SADDLE AND CRICKET FLASHING



250 SQ. FT. OF SOLAR READY ZONE FOR FUTURE INSTALLATION. PROVIDE A LOCATION FOR INVERTERS AND METERING EQUIPMENT FOR FUTURE SYSTEMS ALONG w/ A PATHWAY FOR ROUTING CONDUIT FROM THE SOLAR ZONES TO THE POINT OF INTERCONNECTION w/ THE ELECTRICAL SERVICE AND PATHWAY FOR ROUTING OF PLUMBING FROM THE SOLAR ZONE TO THE WATER-HEATING SYSTEM.

- 0.12 LINE OF EAVE 0.13 LINE OF RAKE/ BARGE
- 0.14 GABLE END TRUSS W/ RECESSED FALSE VENT DETAIL PER ELEVATION. SEE DETAILS FOR VERTICAL TRUSS MEMBER COORDINATION


5. METALS

5.01 LINE OF C.R. METAL GUTTER / DOWNSPOUT 5.02 C.R. METAL CRICKET/SADDLE FLASHING 5.03 C.R. METAL VALLEY FLASHING

- 5.04 O'HAGIN ROOF VENT
- 5.05 C.R. METAL DIRECT VENT CAP (INSTALL PER MANUFACTURER'S INSTRUCTIONS)


MESA STUDIO ARCHITECTURE & DESIGN WWW.MESASTUDIO.DESIGN 949.204.0076 STAMP: 11.30.25 RENEWAL 2280 ELDEN AVE. DEV. 24016 152 ALBERT PLACE LLC. **6** BUILDING DEPARTMENT SUBMITTAL: Ο IST SUBMITTAL 2ND SUBMITTAL 3RD SUBMITTAL S 4TH SUBMITTAL \cap A REVISIONS: U Ζ ZZ ROOF PLAN PLAN 2 MESA STUDIO, INC © 2025 - ALL RIGHTS RESERVED. THE DRAWINGS, DESIGNS, INFORMATION, CONTENT AND PROCEDURES DESCRIBED HEREIN ARE FOR THE EXCLUSIVE USE OF MESA STUDIO, INC. OR AFFILIATES, AND AS SUCH, ARE NOT TO BE REPRODUCED IN ANY FORM OR MEDIA, CURRENT OR FUTURE, OR DISCLOSED TO OTHERS WITHOUT THE WRITTEN CONSENT OF MESA STUDIO, INC. DISTRIBUTION OF DUPLICATION OF THESE DOCUMENTS IS NOT TO BE CONSTRUCTED AS PUBLICATION IN DEROGATION OF THERE RIGHTS. VISUAL CONTACT WITH THESE DOCUMENTS SHALL CONSTITUTE EVIDENCE OF ACCEPTANCE OF THESE RESTRICTIONS. SHEET NUMBER: A9-3

PLOT DATE:

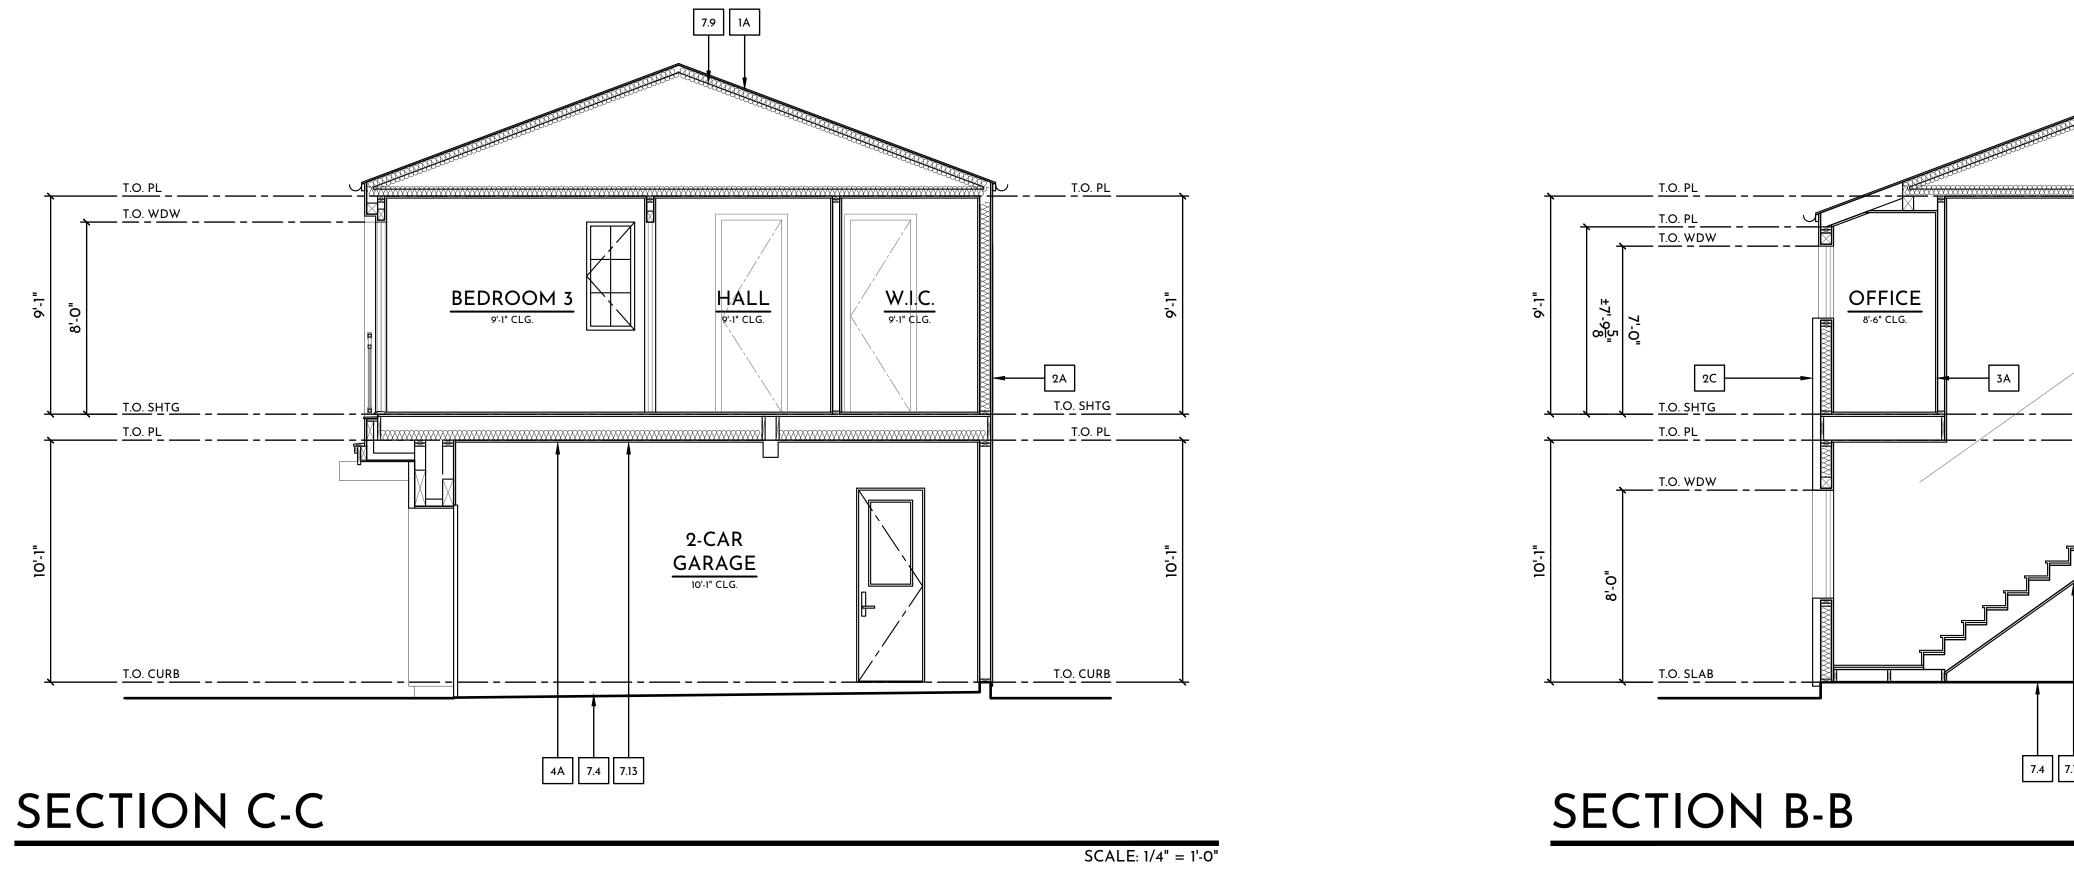


GENERAL NOTES

- HORIZONTAL AND VERTICAL DIMENSIONS SHOWN ARE FROM FACE 1.
- OF STUD OF FACE OF CONCRETE UNLESS NOTED OTHERWISE ANY DISCREPANCY FOUND IN THESE DRAWINGS IS TO BE BROUGHT
- TO THE ATTENTION OF THE ARCHITECT PRIOR TO ANY CONSTRUCTION FIRST FLOOR DIMENSIONS ARE FROM THE TOP OF HOUSE SLAB
- SECOND FLOOR DIMENSIONS ARE FROM THE TOP OF SUB FLOOR 4.
- SHEATHING REFER TO STRUCTURAL DRAWINGS FOR FRAMING MEMBER SPECIES, 5. GRADES, SIZES, SPACING, CONNECTIONS, ROOF AND FLOOR
- SHEATHING, SHEAR WALLS AND ADDITIONAL INFORMATION FOUNDATION: FOUNDATION IS TO BE A CONCRETE SLAB ON GRADE 6.
- SYSTEM (U.N.O). DESIGNED BY OTHERS 7. SOLE PLATES: SOLE PLATES SHALL BE PRESSURE TREATED

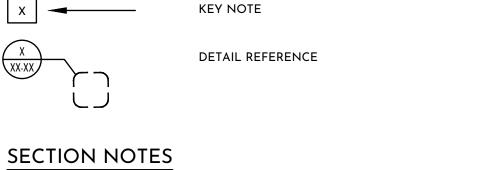

SYMBOL LEGEND

- 1A. SLOPED ROOF ASSEMBLY: ROOFING MATERIAL - PER ROOF PLAN
- ROOFING UNDERLAYMENT FELT PER MFR'S SPEC'S ROOF SHEATHING - S.S.D.
- CALIFORNIA FRAMING (WHERE OCCURS) 4
- DESIGNED WOOD TRUSSES OR 2X RAFTERS
- INSULATION PER ENERGY CALCS 6.
- 2X WOOD FURRING (WHERE OCCURS)
- 8. GYPSUM BOARD AT CEILING (OR FINISH PER INT. SPEC)

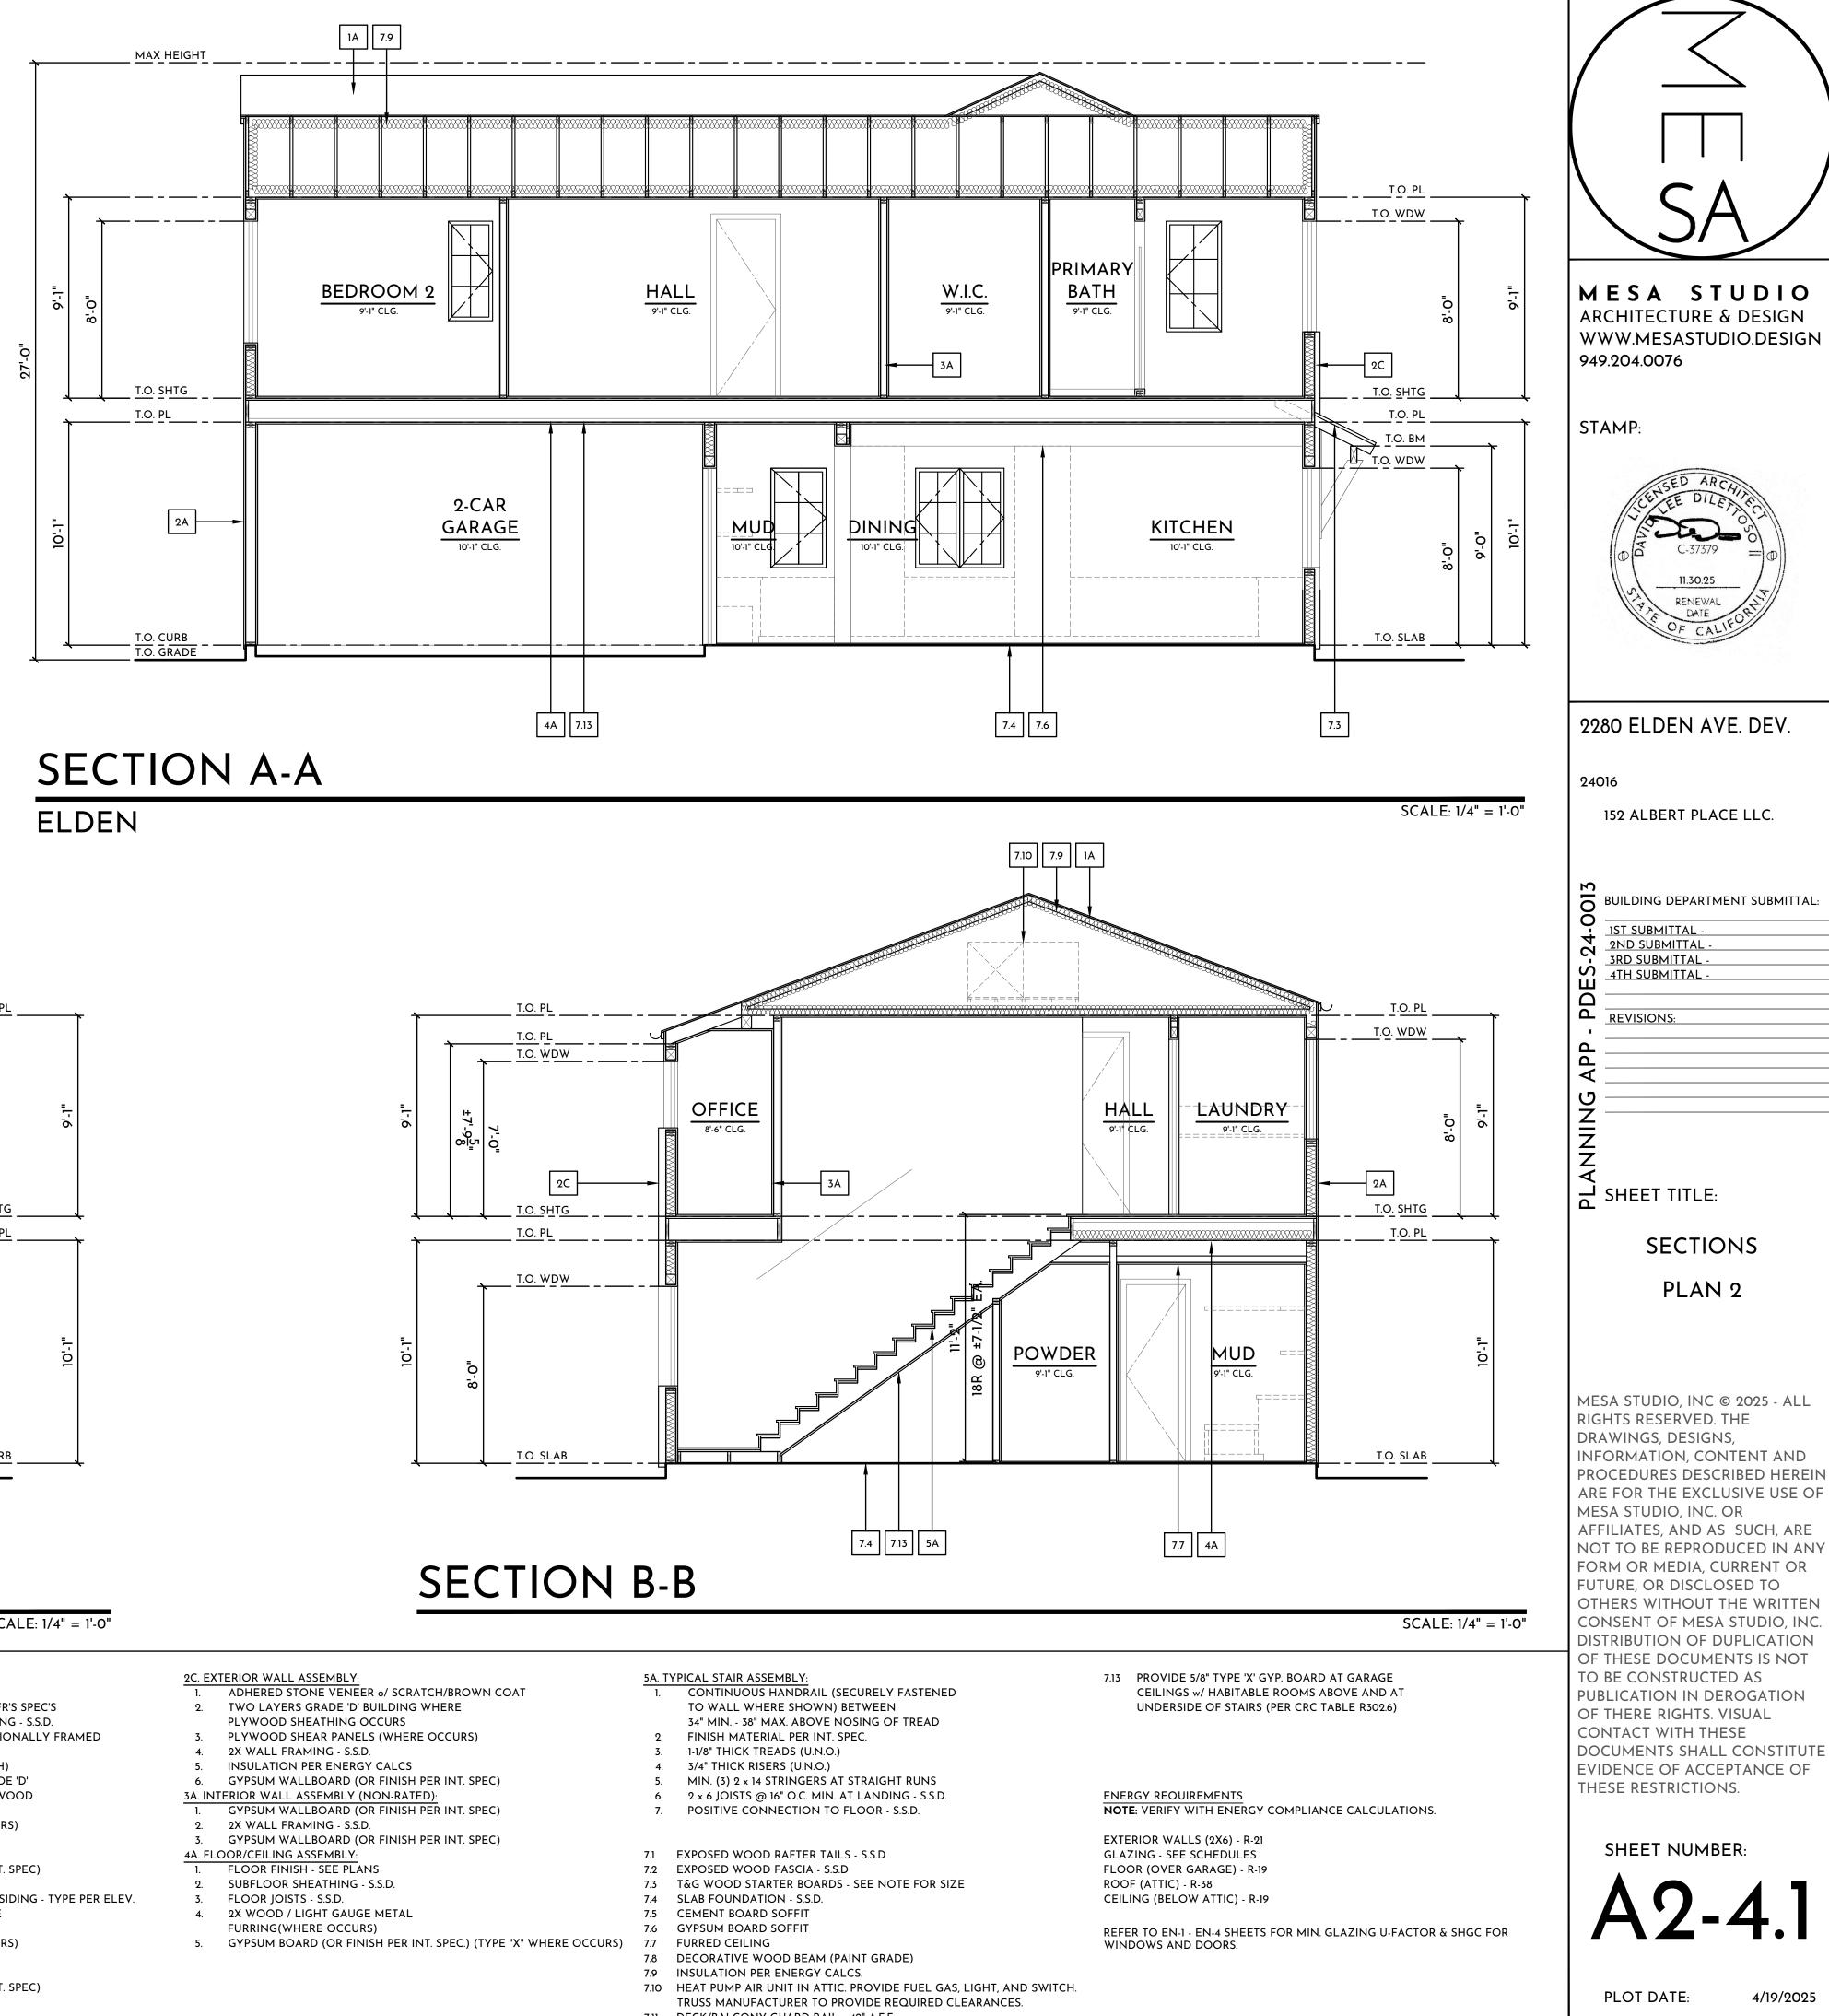


1B. SLOPED EXPOSED RAFTERS ROOF ASSEMBLY:1.ROOFING MATERIAL - PER ROOF PLAN

- ROOFING UNDERLAYMENT FELT PER MFR'S SPEC'S
- 3. 2X T&G STARTER BOARD / ROOF SHEATHING S.S.D. 4. EXPOSED WOOD 4X6 RAFTERS. CONVENTIONALLY FRAMED
- 2A. EXTERIOR WALL ASSEMBLY:

2

- 7/8" EXTERIOR STUCCO 3 COAT (SMOOTH) 2. WIRE LATH OVER MIN. TWO LAYERS GRADE 'D'
 - 60 MINUTE BUILDING PAPER WHERE PLYWOOD
- SHEATHING OCCURS 3. PLYWOOD SHEAR PANELS (WHERE OCCURS)
- 4. 2X WALL FRAMING S.S.D.
- 5. INSULATION PER ENERGY CALCS 6. GYPSUM WALLBOARD (OR FINISH PER INT. SPEC)
- 2B. EXTERIOR WALL ASSEMBLY:
- CEMENTITIOUS/FIBER-ASH WOOD COMP. SIDING TYPE PER ELEV. 2. TWO LAYERS GRADE 'D' BUILDING WHERE
 - PLYWOOD SHEATHING OCCURS
- 3. PLYWOOD SHEAR PANELS (WHERE OCCURS)
- 4. 2X WALL FRAMING S.S.D. 5. INSULATION PER ENERGY CALCS
- 6. GYPSUM WALLBOARD (OR FINISH PER INT. SPEC)

- 7.11 DECK/BALCONY GUARD RAIL. +42" A.F.F.

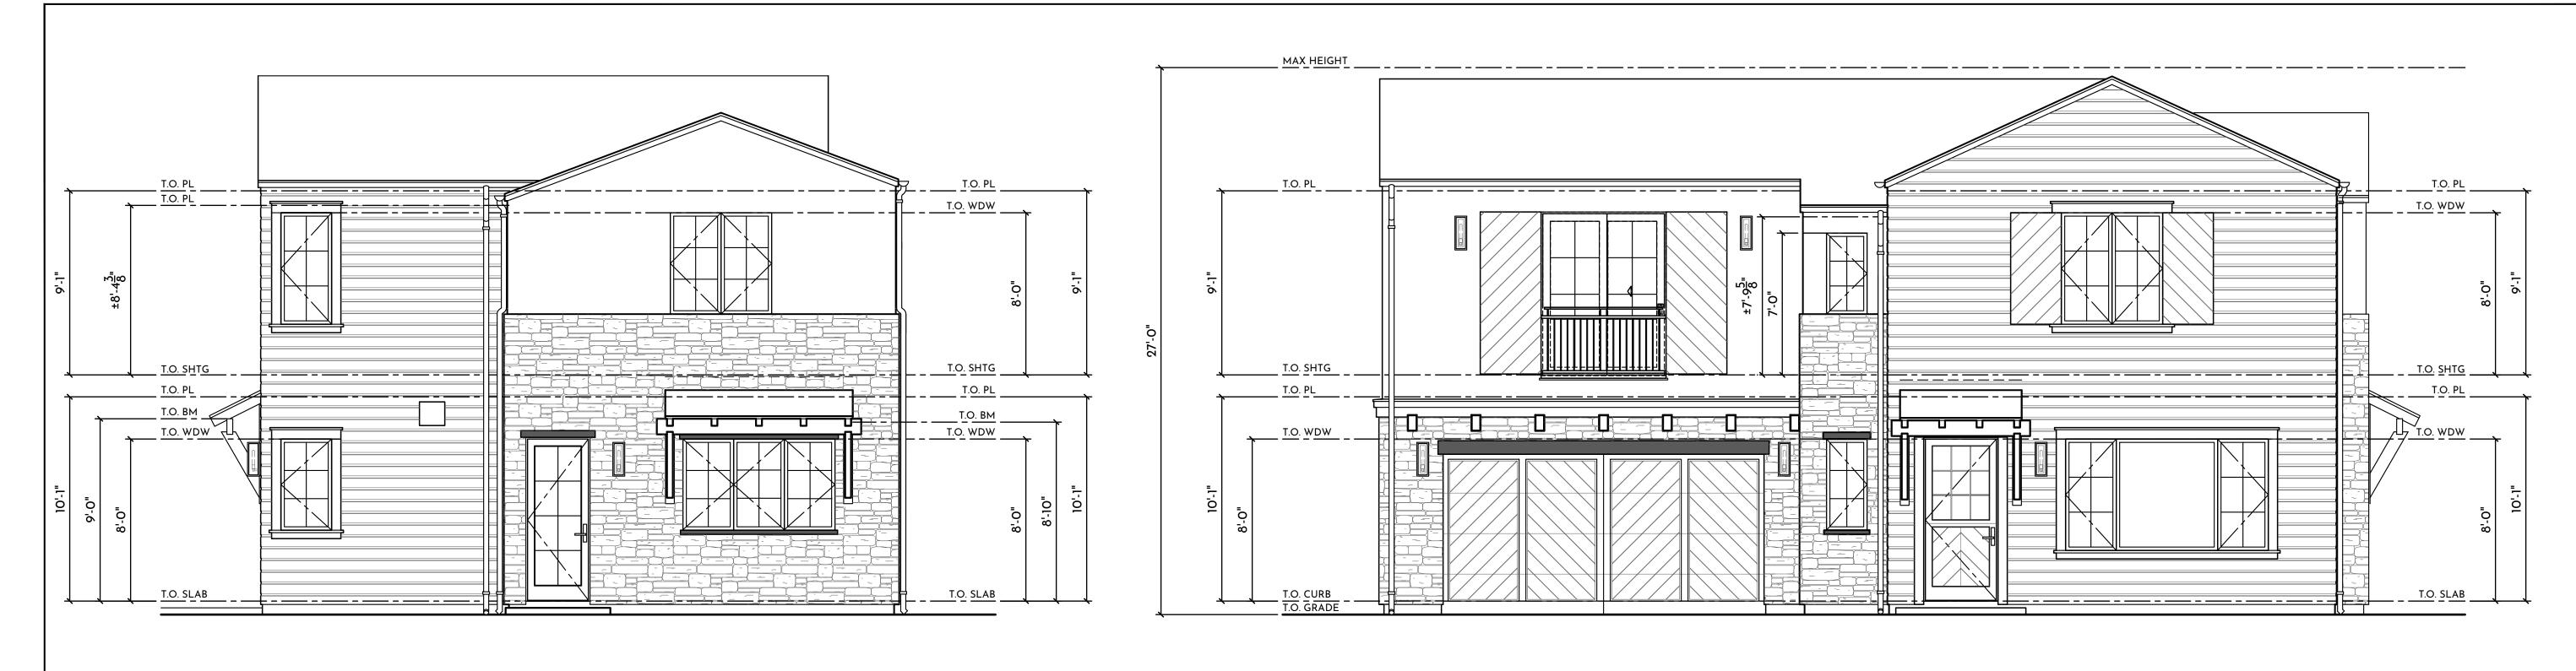

SOUTHWEST ELEVATION




NORTHEAST ELEVATION

GENERAL NOTES

- 1. HORIZONTAL AND VERTICAL DIMENSIONS SHOWN ARE FROM FACE OF STUD OF FACE OF CONCRETE UNLESS NOTED OTHERWISE 2. ANY DISCREPANCY FOUND IN THESE DRAWINGS IS TO BE BROUGHT
- TO THE ATTENTION OF THE ARCHITECT PRIOR TO ANY CONSTRUCTION FIRST FLOOR DIMENSIONS ARE FROM THE TOP OF HOUSE SLAB 3.
- SECOND FLOOR DIMENSIONS ARE FROM THE TOP OF SUB FLOOR 4. SHEATHING
- 5. ALL EXTERIOR PAVING AND SITE ELEMENTS ARE FOR REFERENCE ONLY.
- 6. ALL MECHANICAL EQUIPMENTS, ELECTRICAL FIXTURES, PLUMBING FIXTURES, AND STRUCTURAL MEMBERS ARE SHOWN FOR REFERENCE ONLY, REFER TO CONSULTANT'S DRAWINGS FOR DESIGN, DETAILS AND DIMENSIONS BY OTHERS.
- 7. CONTRACTOR TO COORDINATE PLUMBING, MECHANICAL, ELECTRICAL PENETRATIONS AND CONNECTIONS WITH SUBCONTRACTORS
- 8. ALL EQUIPMENT, APPLIANCES, AND FIXTURES TO BE INSTALLED PER MANUFACTURER'S INSTRUCTIONS.

SYMBOL LEGEND KEY NOTE X -

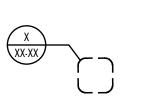

DETAIL REFERENCE

ELEVATION NOTES 0. SPATIAL 0.01 LINE OF WALL BEYOND 0.02 WALL OPENING 2. SITE 2.01 SITE WALL | GATE (SEE LANDSCAPE)


2.02 FINISH GRADE 3. CONCRETE 4. MASONRY

4.01 THIN STONE VENEER (ADHERED) w/ MORTAR WASH (PLAN 1- WILDFLOWER BY CREATIVE MINES PLAN 2 - GRAND BANKS BY ELDORADO STONE OR APPROVED EQUAL) 4.02 PRECAST CONCRETE TRIM / HEADER (FOAM TRIM w/ SMOOTH PLASTER

FINISH ALTERNATE)

NORTHWEST ELEVATION

SCALE: 1/4" = 1'-0"

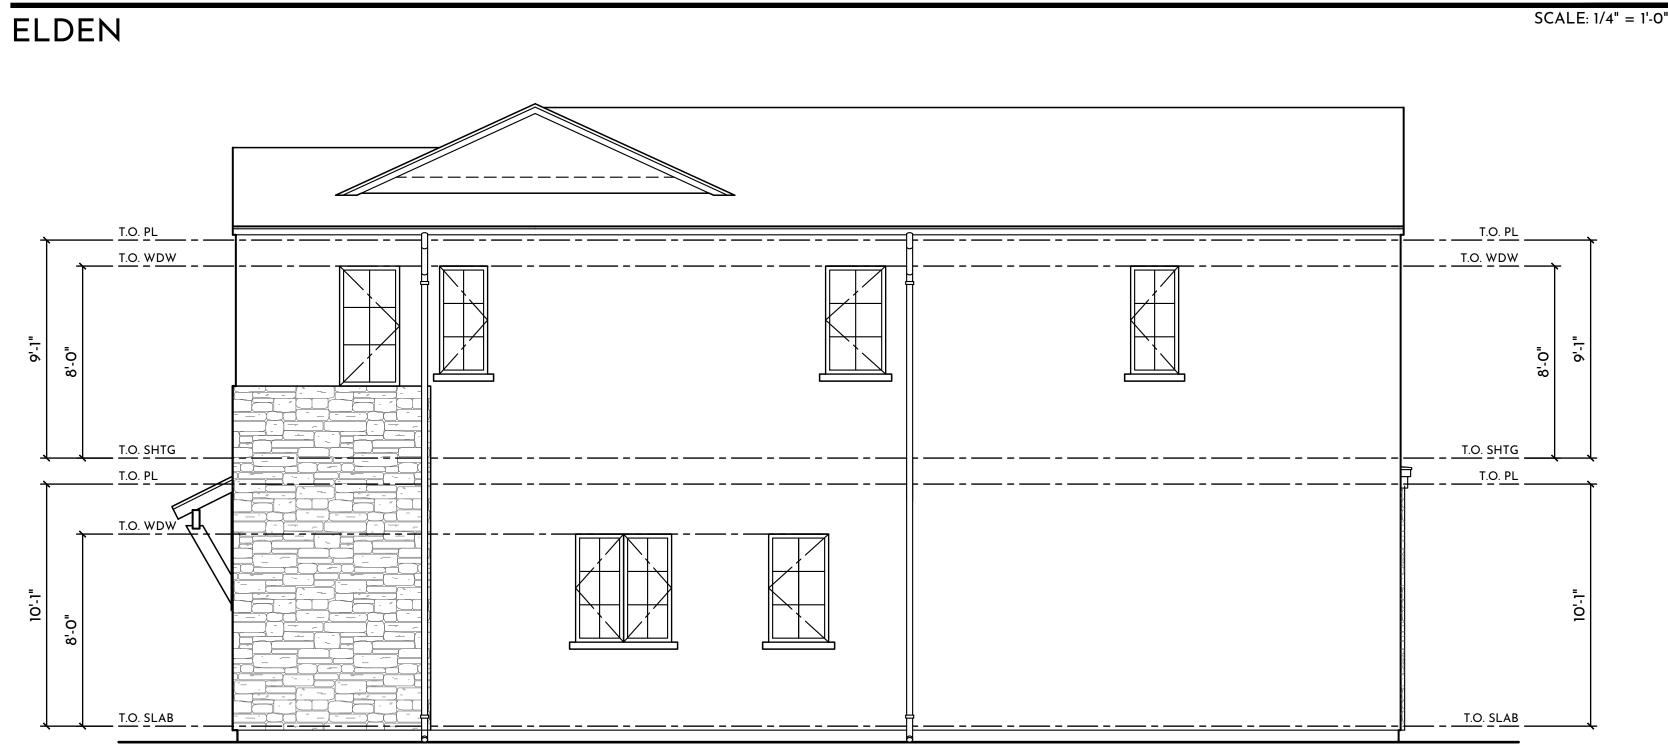

SOUTHEAST ELEVATION

SCALE: 1/4" = 1'-0"

3.01 CONCRETE SLAB ON GRADE (SEE STRUCTURAL) 3.02 CONCRETE/HARDSCAPE STOOP (SEE LANDSCAPE)

- 5. METALS
- 5.01 C.R. METAL STUCCO WEEP SCREED, TYP. 5.02 C.R. METAL GUTTER, TYP.
- 5.03 C.R. METAL DOWNSPOUT. TIE INTO SITE DRAINAGE PER CIVIL
- 5.04 C.R. METAL FLASHING AT INTERSECTION 5.05 C.R. METAL FLASHING AT TOP OF ALL EXPOSED
- WOOD (TRIM INCLUDED)
- 5.06 LISTED C.R. METAL HORIZONTAL VENT TERMINATION CAP FOR GAS FIREPLACE. PER MANUF. SPECS. SET BOTTOM OF CAP MIN. 8'-0" A.F.H. 5.07 C.R. METAL GUARD AND RAILING SYSTEM. + 42" A.F.F.
- 5.08 STANDING SEAM METAL ROOF
- 5.09 RECESSED METAL LOUVER VENT (FAUX GABLE DETAIL)

6. WOOD

- 6.01 WOOD FASCIA 6.02 WOOD BARGE
- 6.03 WOOD RAFTER TAILS
- 6.04 2X WOOD TRIM
- 6.05 WOOD POST
- 6.06 SHAPED WOOD BEAM 6.07 WOOD CORBEL
- 6.08 WOOD GUARD AND RAILING SYSTEM. +42" A.F.F.
- 6.09 SHAPED WOOD KNEE BRACE | KICKER 6.10 WOOD TRIM BAND

-20-

7. EXTERIOR FINISHES

- 7.01 ROOFING MATERIAL (SEE ROOF PLANS) 7.02 3-COAT EXTERIOR PLASTER/STUCCO (SMOOTH FINISH)
- 7.03 PLASTER CONTROL JOINT 7.04 VERTICAL SIDING - 10X NICKEL-GAP (TRUEXTERIOR SIDING OR
- APPROVED EQUAL) 7.05 HORIZONTAL SIDING - 8X COVE | DUTCH LAP SIDING (TRUEXTERIOR
 - SIDING OR APPROVED EQUAL) 7.06 WOOD (COMPOSITE ALTERNATE) SHUTTER
- 8. OPENINGS 8.01 ENTRY DOOR. REFER TO DOOR SCHEDULE 8.02 ACCESS DOOR. REFER TO DOOR SCHEDULE
- 8.03 SECTIONAL ROLL-UP GARAGE DOOR- WOOD GARAGE DOOR (STAIN GRADE)
- **15. MECHANICAL** 15.01 A/C CONDENSER LOCATION

SCALE: 1/4" = 1'-0"

- 16. ELECTRICAL 16.01 LIGHT FIXTURE - CARSON GOOSENECK WALL SCONCE - 12" DOME -BLACK - 16" WALL PROJECTION BY REJUVENATION OR APPROVED EQUAL. SEE UTILITY PLAN FOR HEIGHT
- 16.02 LIGHT FIXTURE 1 FRESNO LARGE $\frac{3}{4}$ WALL LANTERN AGED IRON BY VISUAL COMFORT OR APPROVED EQUAL. SEE UTILITY PLAN FOR HEIGHT
- 16.03 LIGHT FIXTURE 2 HALLE LARGE WALL LANTERN AGED IRON BY VISUAL COMFORT OR APPROVED EQUAL. SEE UTILITY PLAN FOR HEIGHT 16.04 ADDRESS SIGN, +66 AFF (U.N.O)
- MESA STUDIO **ARCHITECTURE & DESIGN** WWW.MESASTUDIO.DESIGN 949.204.0076 STAMP: 2280 ELDEN AVE. DEV. 24016 152 ALBERT PLACE LLC. **5** BUILDING DEPARTMENT SUBMITTAL <u>IST SUBMITTAL</u> 2ND SUBMITTAL 3RD SUBMITTAL 4TH SUBMITTAL \cap **A** REVISIONS: (7 Ī **ELEVATIONS** PLAN 2 MESA STUDIO, INC © 2025 - ALL RIGHTS RESERVED. THE DRAWINGS, DESIGNS, INFORMATION, CONTENT AND PROCEDURES DESCRIBED HEREIN ARE FOR THE EXCLUSIVE USE OF MESA STUDIO, INC. OR AFFILIATES, AND AS SUCH, ARE NOT TO BE REPRODUCED IN ANY FORM OR MEDIA, CURRENT OR FUTURE, OR DISCLOSED TO OTHERS WITHOUT THE WRITTEN CONSENT OF MESA STUDIO, INC DISTRIBUTION OF DUPLICATION OF THESE DOCUMENTS IS NOT TO BE CONSTRUCTED AS PUBLICATION IN DEROGATION OF THERE RIGHTS. VISUAL CONTACT WITH THESE DOCUMENTS SHALL CONSTITUTE EVIDENCE OF ACCEPTANCE OF THESE RESTRICTIONS. SHEET NUMBER:

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