


TIM@HILCODEVELOPMENT.COM

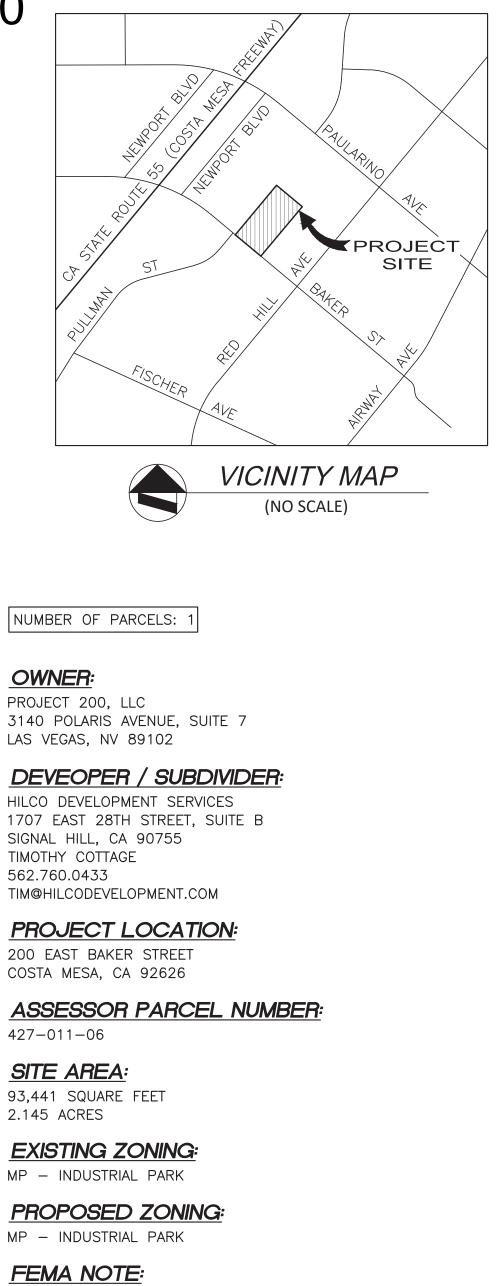

ZONE: "X" AREA OF MINIMAL FLOOD HAZARD

PANEL NO. 06059C 0267J

DATED: DECEMBER 3, 2009

PARKING COUNT:

REGULAR STALLS - 142

ADA STALLS – 6 TOTAL STALLS – 148

LEGAL DESCRIPTION:

THE LAND REFERRED TO HEREIN BELOW IS SITUATED IN THE CITY OF COSTA MESA IN THE COUNTY OF ORANGE, STATE OF CALIFORNIA, AND IS DESCRIBED AS FOLLOWS:

PARCEL 1:

LOT 7 OF TRACT 5769, IN THE CITY OF COSTA MESA, COUNTY OF ORANGE, STATE OF CALIFORNIA, AS SHOWN ON A MAP RECORDED IN BOOK 210, PAGES 9 AND 10 OF MISCELLANEOUS MAPS, IN THE OFFICE OF THE COUNTY RECORDER OF SAID COUNTY.

PARCEL 2:

A NON-EXCLUSIVE EASEMENT FOR THE PURPOSE OF VEHICULAR AND PEDESTRIAN INGRESS AND EGRESS AND INCIDENTAL PURPOSES, OVER THAT PORTION OF LOT 8 OF SAID TRACT NO. 5769 DESCRIBED IN THAT CERTAIN DOCUMENT RECORDED JUNE 29, 1984 AS INSTRUMENT NO. 84-271431, OFFICIAL RECORDS.

Dovelonment	<b>DATE:</b> 10-5-23	TPM No. 2023-167	
l Development Sonsultants	DESIGNED:	FOR CONDOMINIUM PURPOSES	1
thinking, forward planning , Santa Ana, CA 92705	DRAFTED: SZ	200 EAST BAKER STREET APN: 427-011-06	SHEET OF
neers.com	CHECKED: HZ	COSTA MESA, CALIFORNIA	јов no. <b>63</b>

# SHEET LIST

A0.00	COVER SHEET	L0.00	L
A0.01	SURVEY	L8.00	Ρ
A0.02	SITE PLAN	L9.01	Ρ
A0.2A	PARKING ALLOCATION PLAN	L9.02	Ρ
A0.03	REFERENCE SITE PLAN	L9.03	Ρ
A0.04	REFERENCE PARKING PLAN		
A0.11	CODE ANALYSIS - PARKING ANALYSIS		
A0.12	CODE ANALYSIS - EGRESS & PLUMBING FIXTURES		
A0.14	EXISTING PHOTOS		
A0.15	EXISTING PHOTOS		
A0.16	RENDERINGS		
A0.17	RENDERINGS		
A0.21	DEMO PLAN - LEVEL 1		
A0.22	DEMO PLAN - LEVEL 2		
A0.23	DEMO PLAN - ROOF PLAN		
A0.31	DEMO REFLECTED CEILING PLAN - LEVEL 1		
A0.32	DEMO REFLECTED CEILING PLAN - LEVEL 2		
A0.41	DEMO ELEVATIONS		
A2.01	CONSTRUCTION PLAN - LEVEL 1		
A2.02	CONSTRUCTION PLAN - LEVEL 2		
A2.03	CONSTRUCTION - ROOF PLAN		
A3.01	REFLECTED CEILING PLAN - LEVEL 1		
A3.02	REFLECTED CEILING PLAN - LEVEL 2		
A4.01	ELEVATIONS		
A4.02	ELEVATIONS		
A5.01	SECTIONS		

L0.00 LANDSCAPE COVER SHEET PLANTING SCHEDULE PLANTING PLAN PLANTING PLAN PLANTING PLAN

# **200 BAKER**

# CITY OF COSTA MESA

# STATE OF CALIFORNIA



# **PROJECT SCOPE**

AREA OF RENOVATION: 39,457.4 SF

TWO STORY COMMERCIAL OFFICE TENANT IMPROVEMENT:

1. DEMO ALL INTERIOR WALLS AND FINISHES, EXISTING RESTROOMS TO REMAIN & PREP FOR NEW FINISHES

2. DEMISE BUILDING INTO ELEVEN (11) SEPARATE OFFICES, FOR SALE, WITH A WIDE CIRCULATION SPINE IN THE CENTER OF THE EXISTING BUILDING

3. CHANGE OF USE OF 1,622 SF OFFICE SPACE TO 1,622 SF CAFE (RESTAURANT), INCLUDING: (KITCHEN, SINGLE OCCUPANCY RESTROOM, AND 524 SF DINING PATIO)

4. SITE IMPROVEMENTS TO LANDSCAPE & MINOR FACADE UPGRADES AT MAIN ENTRY

# **PROPERTY INFORMATION**

ADDRESS: 200 E. BAKER STREET, COSTA MESA, CALIFORNIA, 92626 .IURISDICTION: CITY OF COSTA MESA APN: 427-011-06

LOT: 7 TRACT: TR5769, MM 210/9-10 YEAR BUILT: 1965 **ZONE:** MP - INDUSTRIAL PARK EXISTING USE: OFFICE (GROUP B) **PROPOSED USE:** OFFICE (GROUP B) & RESTAURANT (GROUP A-2) CONSTRUCTION: TYPE V-A (NO CHANGE)

LOT / PARCEL AREA: 93,441 SQUARE FEET (2.145 AC) FLOOR AREA: 39,457.4 SF STORIES: 2 (NO CHANGE) SPRINKLERED: YES


EXISTING PARKING: 146 SPACES (ONE SPACE REMOVED FOR ADA ACCESSIBLE PATH FROM STREET)

LEGAL DESCRIPTION: THE LAND HERINAFTER REFERRED TO IS SITUATED IN THE CITY OF COSTA MESA, COUNTY OF ORANGE, STATE OF CA, AND IS DESCRIBED AS FOLLOWS

PARCEL 1: LOT 7 OF TRACT NO. 5769, IN THE CITY OF COSTA MESA, COUNTY OF ORANGE, STATE OF CALIFORNIA, AS SHOWN ON MAP RECORDED IN BOOK 210, PAGES 9 AND 10, OF MISCELLANEOUS MAPS, IN THE OFFICE OF THE COUNTY RECORDER OF SAID COUNTY.

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# PARCEL MAP

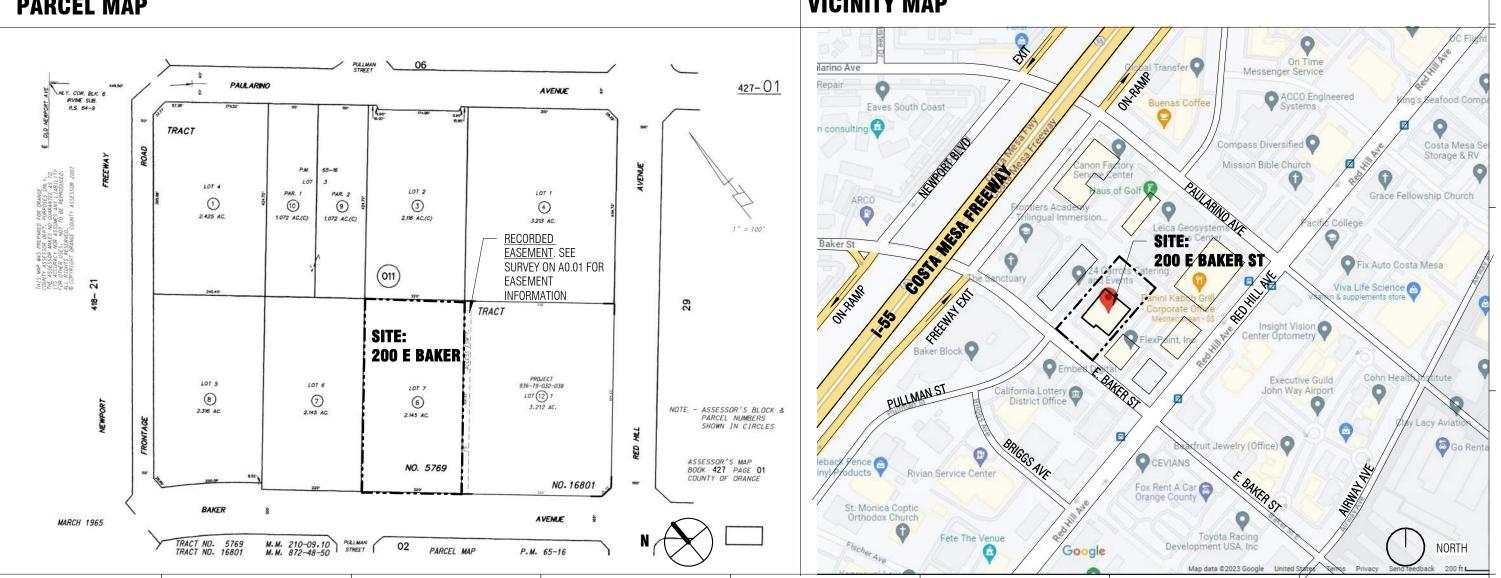

# **DEFERRED SUBMITTAL**

1. SIGNAGE / MONUMENT SIGN

# **DELTA 3** 08/30/2023

# **COMMERCIAL INTERIOR TENANT IMPROVEMENT**

200 E. BAKER ST COSTA MESA, CA 92626

# **PROJECT TEAM**

## BUILDING OWNER: GEB DEVELOPMENT, LLC

ATTN: CAMERON HILDRETH, TIM COTTAGE 3140 POLARIS SUITE #7 LAS VEGAS, NV 89102

PHONE: 562.760.0355 CAMERON@HILCODEVELOPMENT.COM

ARCHITECT: WALKS STUDIO, INC. 1072 ELKGROVE AVE, #4 VENICE, CA 90291 ATTN: CORY WALKER PHONE: (949) 633 0977 EMAIL: CORY@WALKS-STUDIO.COM

CA LICENSE: C-37193

CONTRACTOR: HILCO DEVELOPMENT SERVICES

ATTN: CAMERON HILDRETH 1707 E 28TH STREET, SUITE B SIGNAL HILL, CA, 90775 CA LICENSE # 1070024

PHONE: 562.760.0355 CAMERON@HILCODEVELOPMENT.COM

# **APPLICABLE CODES**

ALL WORK AND MATERIAL SHALL BE PERFORMED AND INSTALLED IN COMPLIANCE WITH THE FOLLOWING CODES AS ADOPTED AND AMENDED BE PROVIDED IN ACCORDANCE WITH THE PROVISIONS OF THE BY THE GOVERNING JURISDICTION. NOTHING IN THESE PLANS IS TO BE CONSTRUED TO PERMIT WORK NOT CONFORMING TO THESE CODES 2022 CALIFORNIA BUILDING CODE (CBC)

2022 CALIFORNIA PLUMBING CODE (CPC)

2022 CALIFORNIA MECHANICAL CODE (CMC) 2022 CALIFORNIA ELECTRICAL CODE (CEC)

2022 CALIFORNIA GREEN BUILDING STANDARDS CODE (CALGREEN) 2022 CALIFORNIA FIRE CODE

2022 CALIFORNIA GREEN BUILDING CODE

2022 CALIFORNIA ENERGY CODE CITY OF COSTA MESA MUNICIPAL CODE, 2022

CONVERSION STANDARDS – THE FACILITY SHALL COMPLY WITH THE REFURBISHING AND RESTORATIONS. ALL MAIN BUILDINGS, Following:

LIFE SAFETY STANDARDS – THE FOLLOWING IMPROVEMENTS SHALL BE ADDITIONAL ELEMENTS AS REQUIRED BY THE FINAL REVIEW PROVIDED IN ACCORDANCE WITH THE PROVISIONS OF THE CALIFORNIA BUILDING CODE OR ANY SUCCESSOR STATUTE OR REGULATION, UNLESS FOR A HIGH STANDARD OF APPEARANCE, QUALITY, AND SAFETY. OTHERWISE NOTED.

I. EACH UNIT SHALL HAVE ACCESS TO THE ELECTRICAL BRANCH CIRCUITS I. INSTALLATION OF ALL REMEDIAL IMPROVEMENTS IDENTIFIED IN THE THAT SERVE THE UNIT.

II. SMOKE DETECTORS SHALL BE INSTALLED AND OPERATING. ALL EXISTING DOCUMENTS REQUIRED HARD-WIRED UNITS SHALL BE IN WORKING ORDER AND ANY ADDITIONAL II. INSTALLATION OF APPROPRIATE IMPROVEMENTS THAT ENSURE UNITS SHALL BE IN WORKING ORDER AND ANY ADDITIONAL SMOKE DETECTORS THAT ARE REQUIRED BY CODE SHALL BE LOCATED AND INSTALLED.

III. GROUND FAULT CIRCUIT INTERRUPTER PROTECTION SHALL BE PROVIDED III. REPLACEMENT OF ALL GAS LINES (BOTH INTERIOR AND EXTERIOR) WHERE REQUIRED BY THE CURRENTLY ADOPTED ELECTRICAL CODE. IV. PORTABLE FIRE EXTINGUISHERS SHALL BE PROVIDED IN ACCORDANCE APPROPRIATE PRESSURE TEST WITH THE CALIFORNIA FIRE CODE OR ANY SUCCESSOR STATUTE OR REGULATION.

# **VICINITY MAP**



# WALKS. studio

1072 ELKGROVE AVE, #4 VENICE, CA 90291 WALKS-STUDIO.COM P.949.633.0977



CA LICENSE NAME: CORY WALKER DISCIPLINE: ARCHITECT CA LICENSE NO: C-37193 RENEWAL DATE: 11-30-2023

ALL DRAWINGS AND DESIGN ARE THE COPYRIGHT PROPERTY OF WALKS STUDIO. REPRODUCTION OF THE DRAWINGS, SPECIFICATIONS, RELATED DOCUMENTS, AND DESIGN, IN WHOLE OR IN PART IS STRICTLY FORBIDDEN WITHOUT WRITTEN PERMISSION

#	DESCRIPTION	DATE
	SCHEMATIC DESIGN 1	04/28/202
	CUP SUBMISSION	05/25/202
	CUP RESUBMISSION	06/26/202
<u>⁄</u> 2	CUP. ADA ROUTE REV.	08/15/202
3	PERMIT SET - 70% CD	08/30/202



# COVER SHEET

## SCALE: as noted DATE: 08/30/2023 JOB NUMBER: 031 DRAWN BY:



SHEET:

REGULATION.

PLUMBING REQUIREMENTS - THE FOLLOWING IMPROVEMENTS SHALL CALIFORNIA PLUMBING CODE AND ANY SUCCESSOR STATUTE OR

I. A TEMPERATURE AND PRESSURE RELIEF VALVE SHALL BE PROVIDED FOR ALL WATER HEATERS. II. WATER HEATERS SHALL BE SEISMICALLY BRACED WITH A MINIMUM

OF TWO (2) STRAPS. III. WATER HEATERS SHALL BE PROPERLY VENTED TO THE OUTSIDE AND SHALL BE PROVIDED WITH SUFFICIENT COMBUSTION AIR. IV. POTABLE WATER SHALL HAVE A BACKFLOW PROTECTION WHERE NECESSARY TO PREVENT POTENTIAL CROSS CONNECTION.

STRUCTURES, WALLS, FENCES, AND CARPORTS, ACCESSORY BUILDINGS. SIDEWALKS. DRIVEWAYS, LANDSCAPED AREAS, AND AUTHORITY SHALL BE REFURBISHED AND RESTORED AS APPROPRIATE SPECIFIC IMPROVEMENTS INCLUDE:

REPORTS SUBMITTED PURSUANT TO BY SECTION 13-54.53(D),

ACCEPTABLE SOUND TRANSMISSION LEVELS BETWEEN EACH UNITS IN EACH BUILDING IN CONFORMANCE WITH THE CURRENT CALIFORNIA BUILDING CODE

THAT DO NOT COMPLY WITH CURRENT CODE AND CONDUCT IV. INSTALLATION OF NEW SINKS, FAUCETS, TOILETS. LOW WATER FLOW PLUMBING FIXTURES ARE RECOMMENDED.

# LEGEND

----- BLOCK WALL

● \_\_\_\_\_ TRAFFIC SIGNAL

٩	_	FIRE HYDRANT	AC	_	ASPHALT PAVEMENT
111		EDGE PAVEMENT	BFD	_	BACK FLOW DEVICE
M	_	WATER VALVE	BW		BACK OF WALK
			EG	—	EDGE OF GUTTER
	_	METER, PULL BOX	EPB		ELECTRICAL PULL BOX
- <del></del> -		SIGN	FC		FINISHED CONCRETE
4		CONCRETE	FDC	—	FIRE DEPARTMENT CONNECTION
	—	BLOCK WALL	FF	-	FINISHED FLOOR
¢		LIGHT STANDARD	FL	—	FLOW LINE
		TRAFFIC SIGNAL	FH	—	FIRE HYDRANT
M			GEN	—	GENERATOR
- A	-	STREET LIGHT	GM	_	GAS METER
Ł	_	HANDICAP STALL	GP	_	GUARD POST
00000	—	WROUGHT IRON FENCE	L	—	LOT LINE
	—	WOOD FENCE	NG	—	NATURAL GROUND
* * * * *		CHAINLINK FENCE	PA	—	PLANTER AREA
$\langle \cdot \rangle$			PB	—	PULL BOX
Ý		PARKING COUNT	PL	—	PROPERTY LINE
$\wedge$	_	BUILDING HEIGHT INDICATOR	PP	_	POWER POLE
			R		RAMP
			R/W	—	RIGHT OF WAY
			SDMH	—	STORM DRAIN MANHOLE
			SMH	—	SEWER MANHOLE
			TC	<del>0</del> -	TOP OF CURB
			TE		TRASH ENCLOSURE
			TW		TOP OF WALL
			ТΧ		TOP OF X

# UTILITIES INFORMATION

ELECTRICITY SOUTHERN CALIFORNIA EDISON 7301 FENWICK LANE WESTMINSTER, CA 92683 (800) 655-4555

WASTE DISPOSAL COSTA MESA SANITARY DISTRICT 290 PAULARINO AVENUE COSTA MESA, CA 92626 (949) 645-8400

UB - UTILITY BOX

WM --- WATER METER WV --- WATER VALVE


SOUTHERN CALIFORNIA GAS COMPANY 1919 S. STATE COLLEGE BLVD. ANAHEIM, CA 92806 (800) 427-2200

SEWER AND WATER SERVICES MESA WATER DISTRICT 1965 PLACENTIA AVENUE COSTA MESA, CA 92627 (949) 631-1201


THE EXISTENCE AND APPROXIMATE LOCATION OF UNDERGROUND UTILITIES OR STRUCTURES SHOWN ON THESE PLANS WERE DETERMINED BY A SEARCH OF THE AVAILABLE PUBLIC RECORDS AND ABOVE GROUND OBSERVANCE. THE SURVEYOR MAKES NO GUARANTEE THAT THE UNDERGROUND UTILITIES SHOWN COMPRISE ALL UTILITIES IN THE AREA, EITHER IN SERVICE OR ABANDONED. THE SURVEYOR FURTHER DOES NOT WARRANT THAT THE UNDERGROUND UTILITIES SHOWN ARE IN THE EXACT LOCATION INDICATED ALTHOUGH HE/SHE DOES CERTIFY THAT THEY ARE LOCATED AS ACCURATELY AS POSSIBLE FROM INFORMATION AVAILABLE. THE SURVEYOR HAS NOT PHYSICALLY LOCATED THE UNDERGROUND UTILITIES.

# GENERAL NOTES

- SURVEYOR HAS RELIED UPON INFORMATION SUPPLIED IN THE CURRENT TITLE REPORT BY CALIFORNIA BEST TITLE COMPANY REPORT NO. CBT-22004303 DATED APRIL 12, 2022 TO DISCLOSE RECORD EASEMENTS THAT BURDEN OR BENEFIT THIS PROPERTY.
- 2. MONUMENTATION WAS NOT FOUND OR SET AT THE PROPERTY CORNERS UNLESS NOTED OTHERWISE.
- 3. ASSESSORS PARCEL NUMBER FOR THIS PROPERTY IS 427-011-06.
- 4. SURVEYOR TAKES NO RESPONSIBILITY OF ITEMS OMITTED DUE TO A RESULT OF VISUAL OBSTRUCTIONS, SUCH AS AUTOMOBILES, EQUIPMENT & THICK SHRUBBERY.
- 5. THE BUILDING SQUARE FOOTAGE INDICATED ON THIS PLAN IS BASED ON EXTERIOR DIMENSIONS AT GROUND LEVEL ONLY.
- 6. THIS PLAN AND/OR DATA FILES INCLUDING ALL CONTENTS HEREIN ARE FOR THE SOLE USES AND PARTIES INDICATED HEREON INCLUDING THEIR SUCCESSORS AND ASSIGNS. ANY DEVIATION OR MISUSES OF THIS PLAN AND/OR DATA FILES WITHOUT PRIOR WRITTEN AGREEMENTS BY ANACAL ENGINEERING IS PROHIBITED AND IS THE RESPONSIBILITY OF THE PARTIES USING SAID DRAWING AND/OR DATA FILES, UPON THE REUSE OF THIS PLAN AND/OR DATA FILES ANACAL ENGINEERING RELINQUISHES ALL RESPONSIBILITIES OF THE ACCURACY AND GENERAL CONTENT OF SAID PLAN AND/OR DATA FILES CONTAINED HEREIN.
- 7. BY OBSERVATION NO CEMETERIES ARE KNOWN OR FOUND ON SUBJECT PROPERTY.
- 8. THERE IS NO EVIDENCE OF EARTH MOVING WORK, EXTERIOR BUILDING CONSTRUCTION OR BUILDING ADDITIONS OBSERVED THAT HAVE BEEN DONE WITHIN RECENT MONTHS.
- 9. THERE IS NO EVIDENCE OF SOLID WASTE DUMP, SUMP OR SANITARY LAND FILL USE.
- 10. THERE WAS NO RESEARCH DONE AT THE CITY'S &/OR COUNTY'S PUBLIC WORKS DEPARTMENTS TO INDICATE THAT THERE ARE ANY CHANGES IN THE STREET RIGHT OF WAY LINES AS SHOWN HEREON. FURTHERMORE THERE IS NO OBSERVABLE EVIDENCE OF ANY RECENT STREET OR SIDEWALK CONSTRUCTION OR REPAIRS UNLESS OTHERWISE NOTED ON THE SURVEY. IT IS THE RESPONSIBILITY OF THE DESIGN PROFESSIONAL TO VERIFY THIS INFORMATION PRIOR TO ANY FUTURE DESIGN WORK.
- 11. THIS PLAN DOES NOT CONTAIN SUFFICIENT DATA FOR DESIGN PURPOSES AND IS NOT FOR CONSTRUCTION PURPOSES.
- 12. BASED ON VISUAL OBSERVATION, THE SUBJECT SITE IS SERVICED BY ALL THE NECESSARY UTILITIES REQUIRED TO MAINTAIN NORMAL OPERATION AND ENTER THROUGH ADJOINING STREETS AND/OR EASEMENTS OF RECORD. UNDERGROUND EVIDENCE FROM PLANS WAS NOT PROVIDED.
- 13. ALL FIELD MEASUREMENTS MATCHED RECORD DIMENSIONS WITHIN THE PRECISION REQUIREMENTS OF ALTA/NSPS SPECIFICATIONS UNLESS OTHERWISE NOTED.
- 14. SITE HAS DIRECT ACCESS E. BAKER STREET, A PUBLIC RIGHT-OF-WAY.
- 15. SURVEYOR DOES NOT ASCERTAIN OWNERSHIP OF FENCES AND PERIMETER WALLS.
- 16. ALL STATEMENTS WITHIN THE CERTIFICATION, AND OTHER REFERENCES LOCATED ELSEWHERE HEREON, RELATED TO: UTILITIES, IMPROVEMENTS, STRUCTURES, BUILDINGS, PARTY WALLS, PARKING, EASEMENT, SERVITUDES, AND ENCROACHMENTS; ARE BASED SOLELY ON ABOVE GROUND, VISIBLE EVIDENCE, UNLESS ANOTHER SOURCE OF INFORMATION IS SPECIFICALLY REFERENCED HEREON.
- 17. THE DIFFERENCES BETWEEN CALLS OF RECORD AND THOSE THAT WERE FOUND DO NOT CREATE ANY GAPS OR GORES BETWEEN ALL PUBLIC RIGHTS OF WAY. THE SUBJECT PROPERTY FORMS A MATHEMATICALLY CLOSED FIGURE, WHICH CONSTITUTES A CONTIGUOUS PARCEL OF
- 18. THE ACCOMPANYING SURVEY WAS MADE ON THE GROUND AND CORRECTLY SHOWS THE LOCATION OF THE BUILDINGS, STRUCTURES AND OTHER IMPROVEMENTS SITUATED ON THE ABOVE PREMISES: THERE ARE NO VISIBLE ENCROACHMENTS ON THE SUBJECT PROPERTY OR UPON ADJACENT LAND ABUTTING SAID PROPERTY EXCEPT AS SHOWN HEREON AND WAS MADE IN ACCORDANCE WITH LAWS AND/OR MINIMUM STANDARDS OF THE STATE OF CALIFORNIA.
- 19. THE PROPERTY HEREON IS THE SAME PROPERTY DESCRIBED IN REPORT NO. CBT-22004303 WITH AN EFFECTIVE DATE OF APRIL 12, 2022 AND THAT ALL EASEMENTS, COVENANTS AND RESTRICTIONS REFERENCED IN SAID TITLE COMMITMENT OR APPARENT FROM A PHYSICAL INSPECTION OF THE SITE OR OTHERWISE KNOWN TO ME HAVE BEEN PLOTTED HEREON OR OTHERWISE NOTED AS TO THEIR EFFECT ON THE SUBJECT PROPERTY.
- 20. THE LEGAL DESCRIPTION DESCRIBES THE SAME PROPERTY AS INSURED IN THE TITLE COMMITMENT AND ANY EXCEPTIONS HAVE BEEN NOTED.

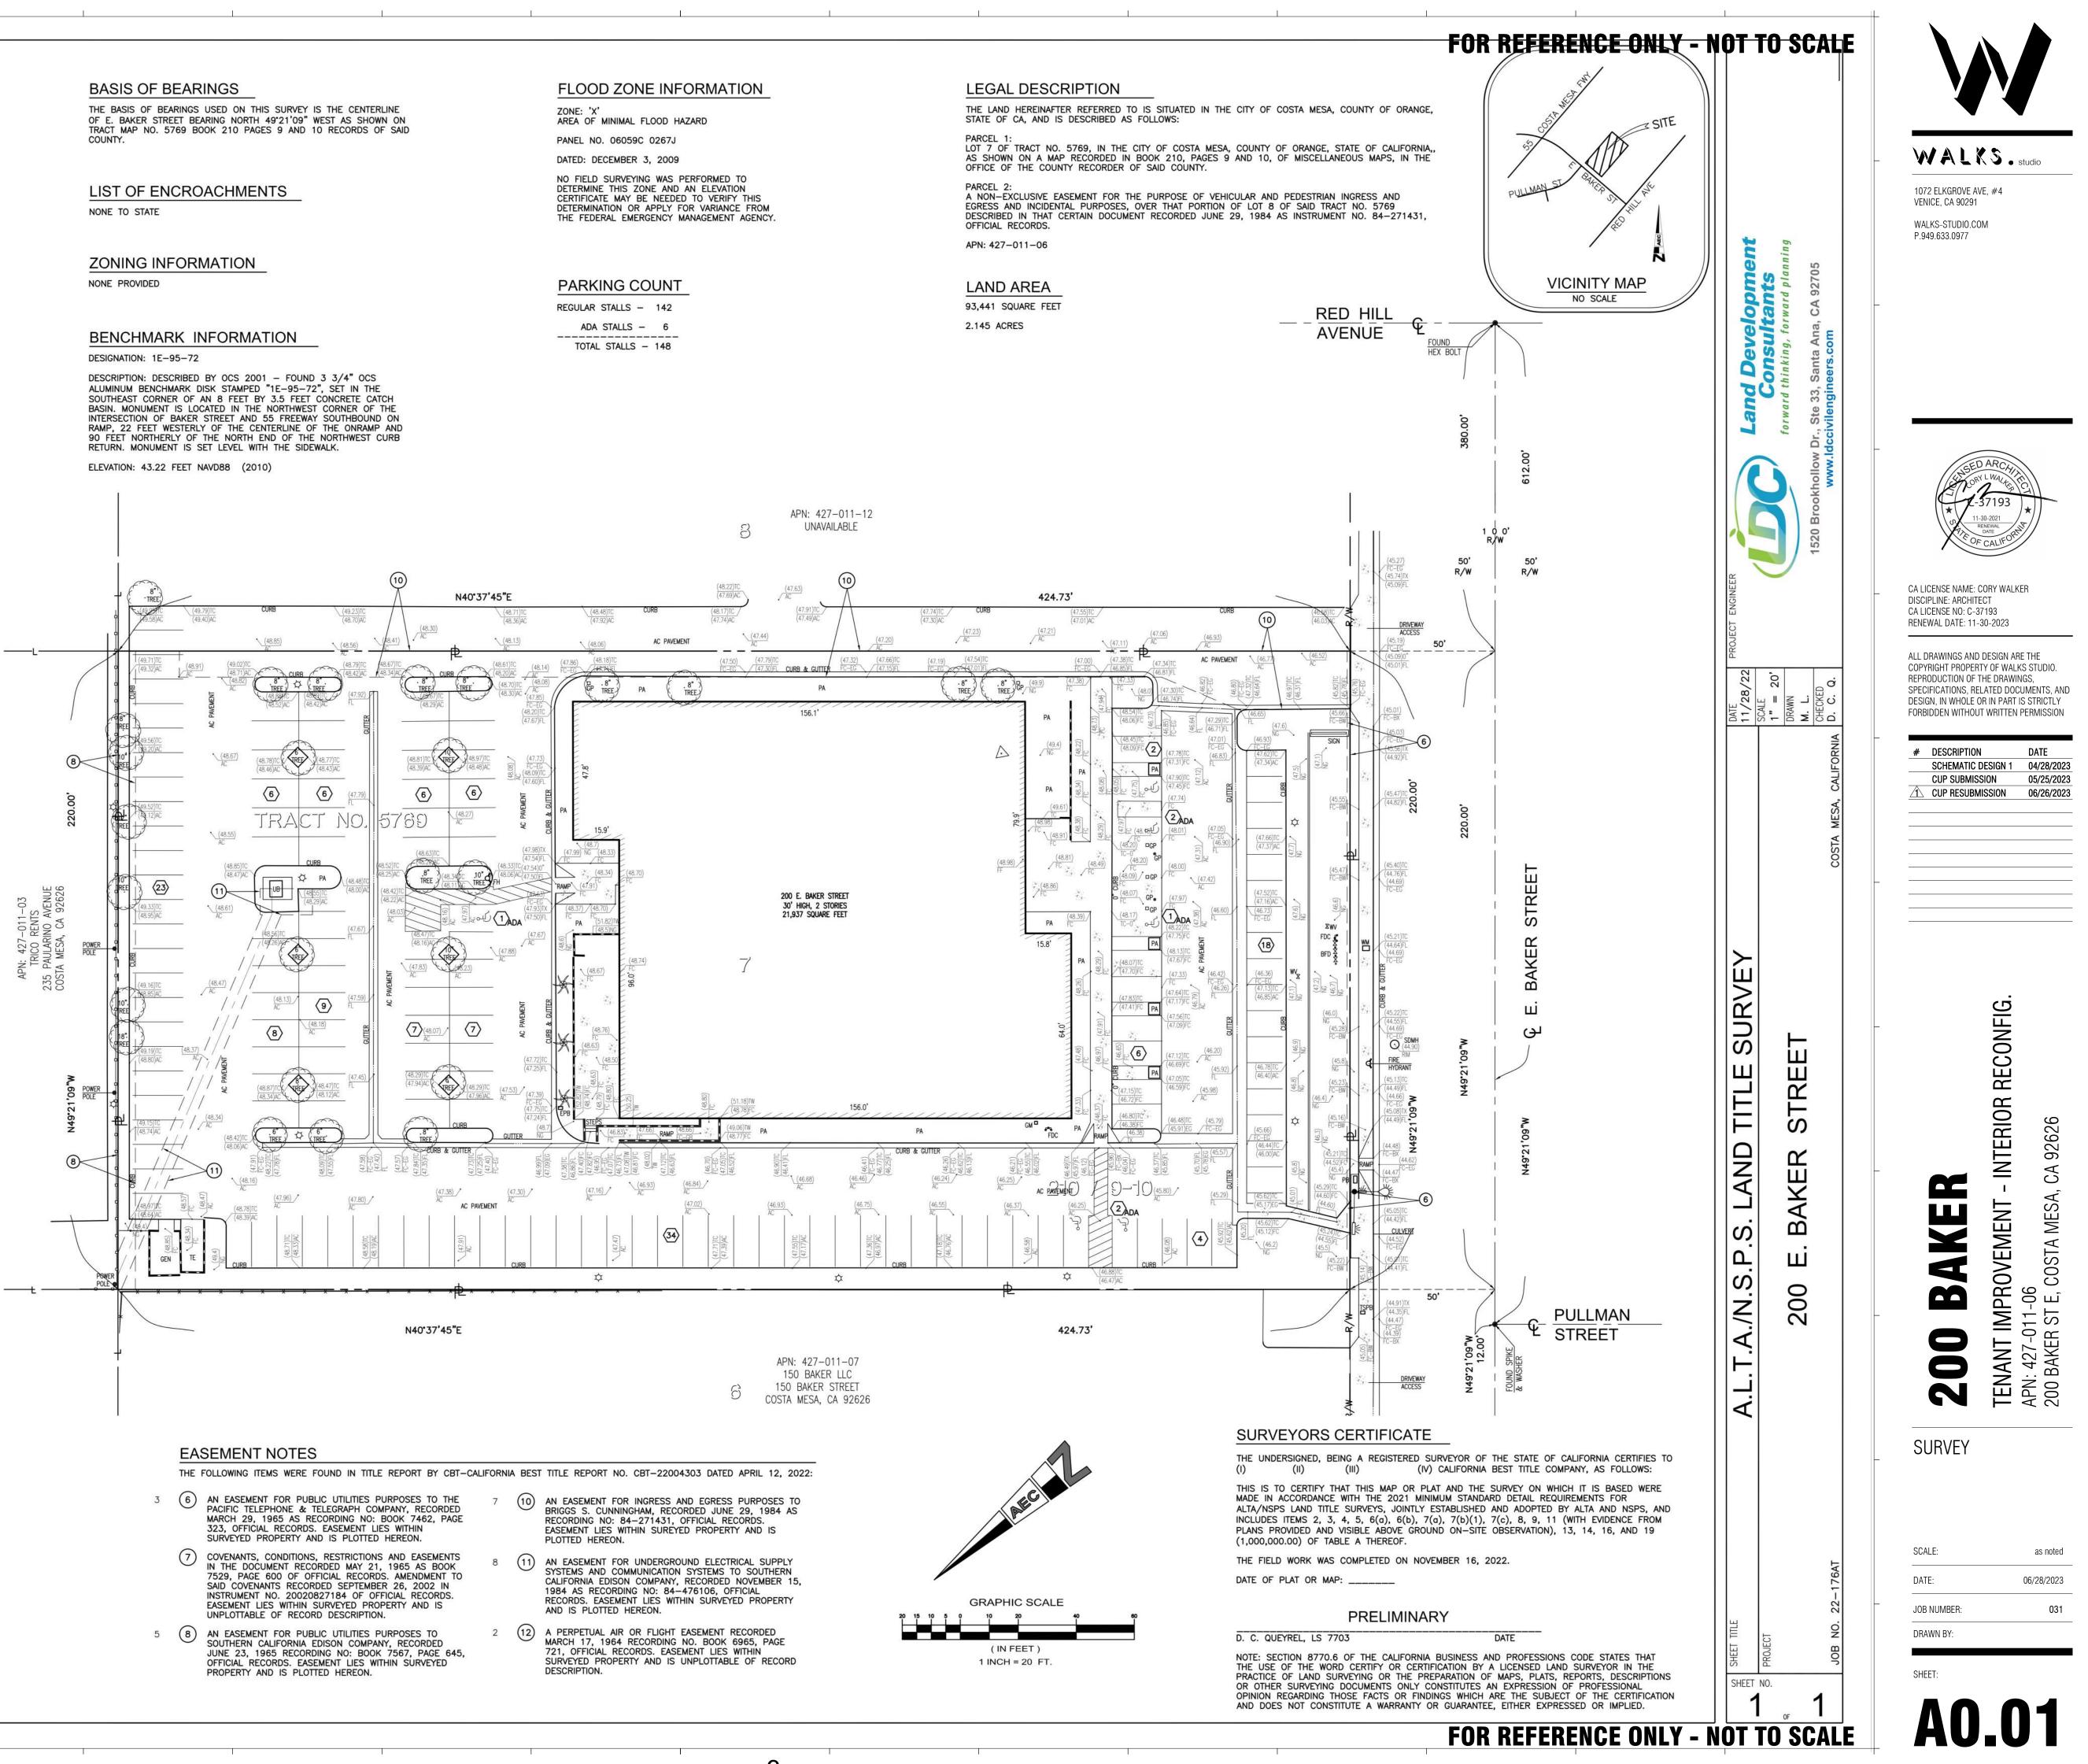

-3-

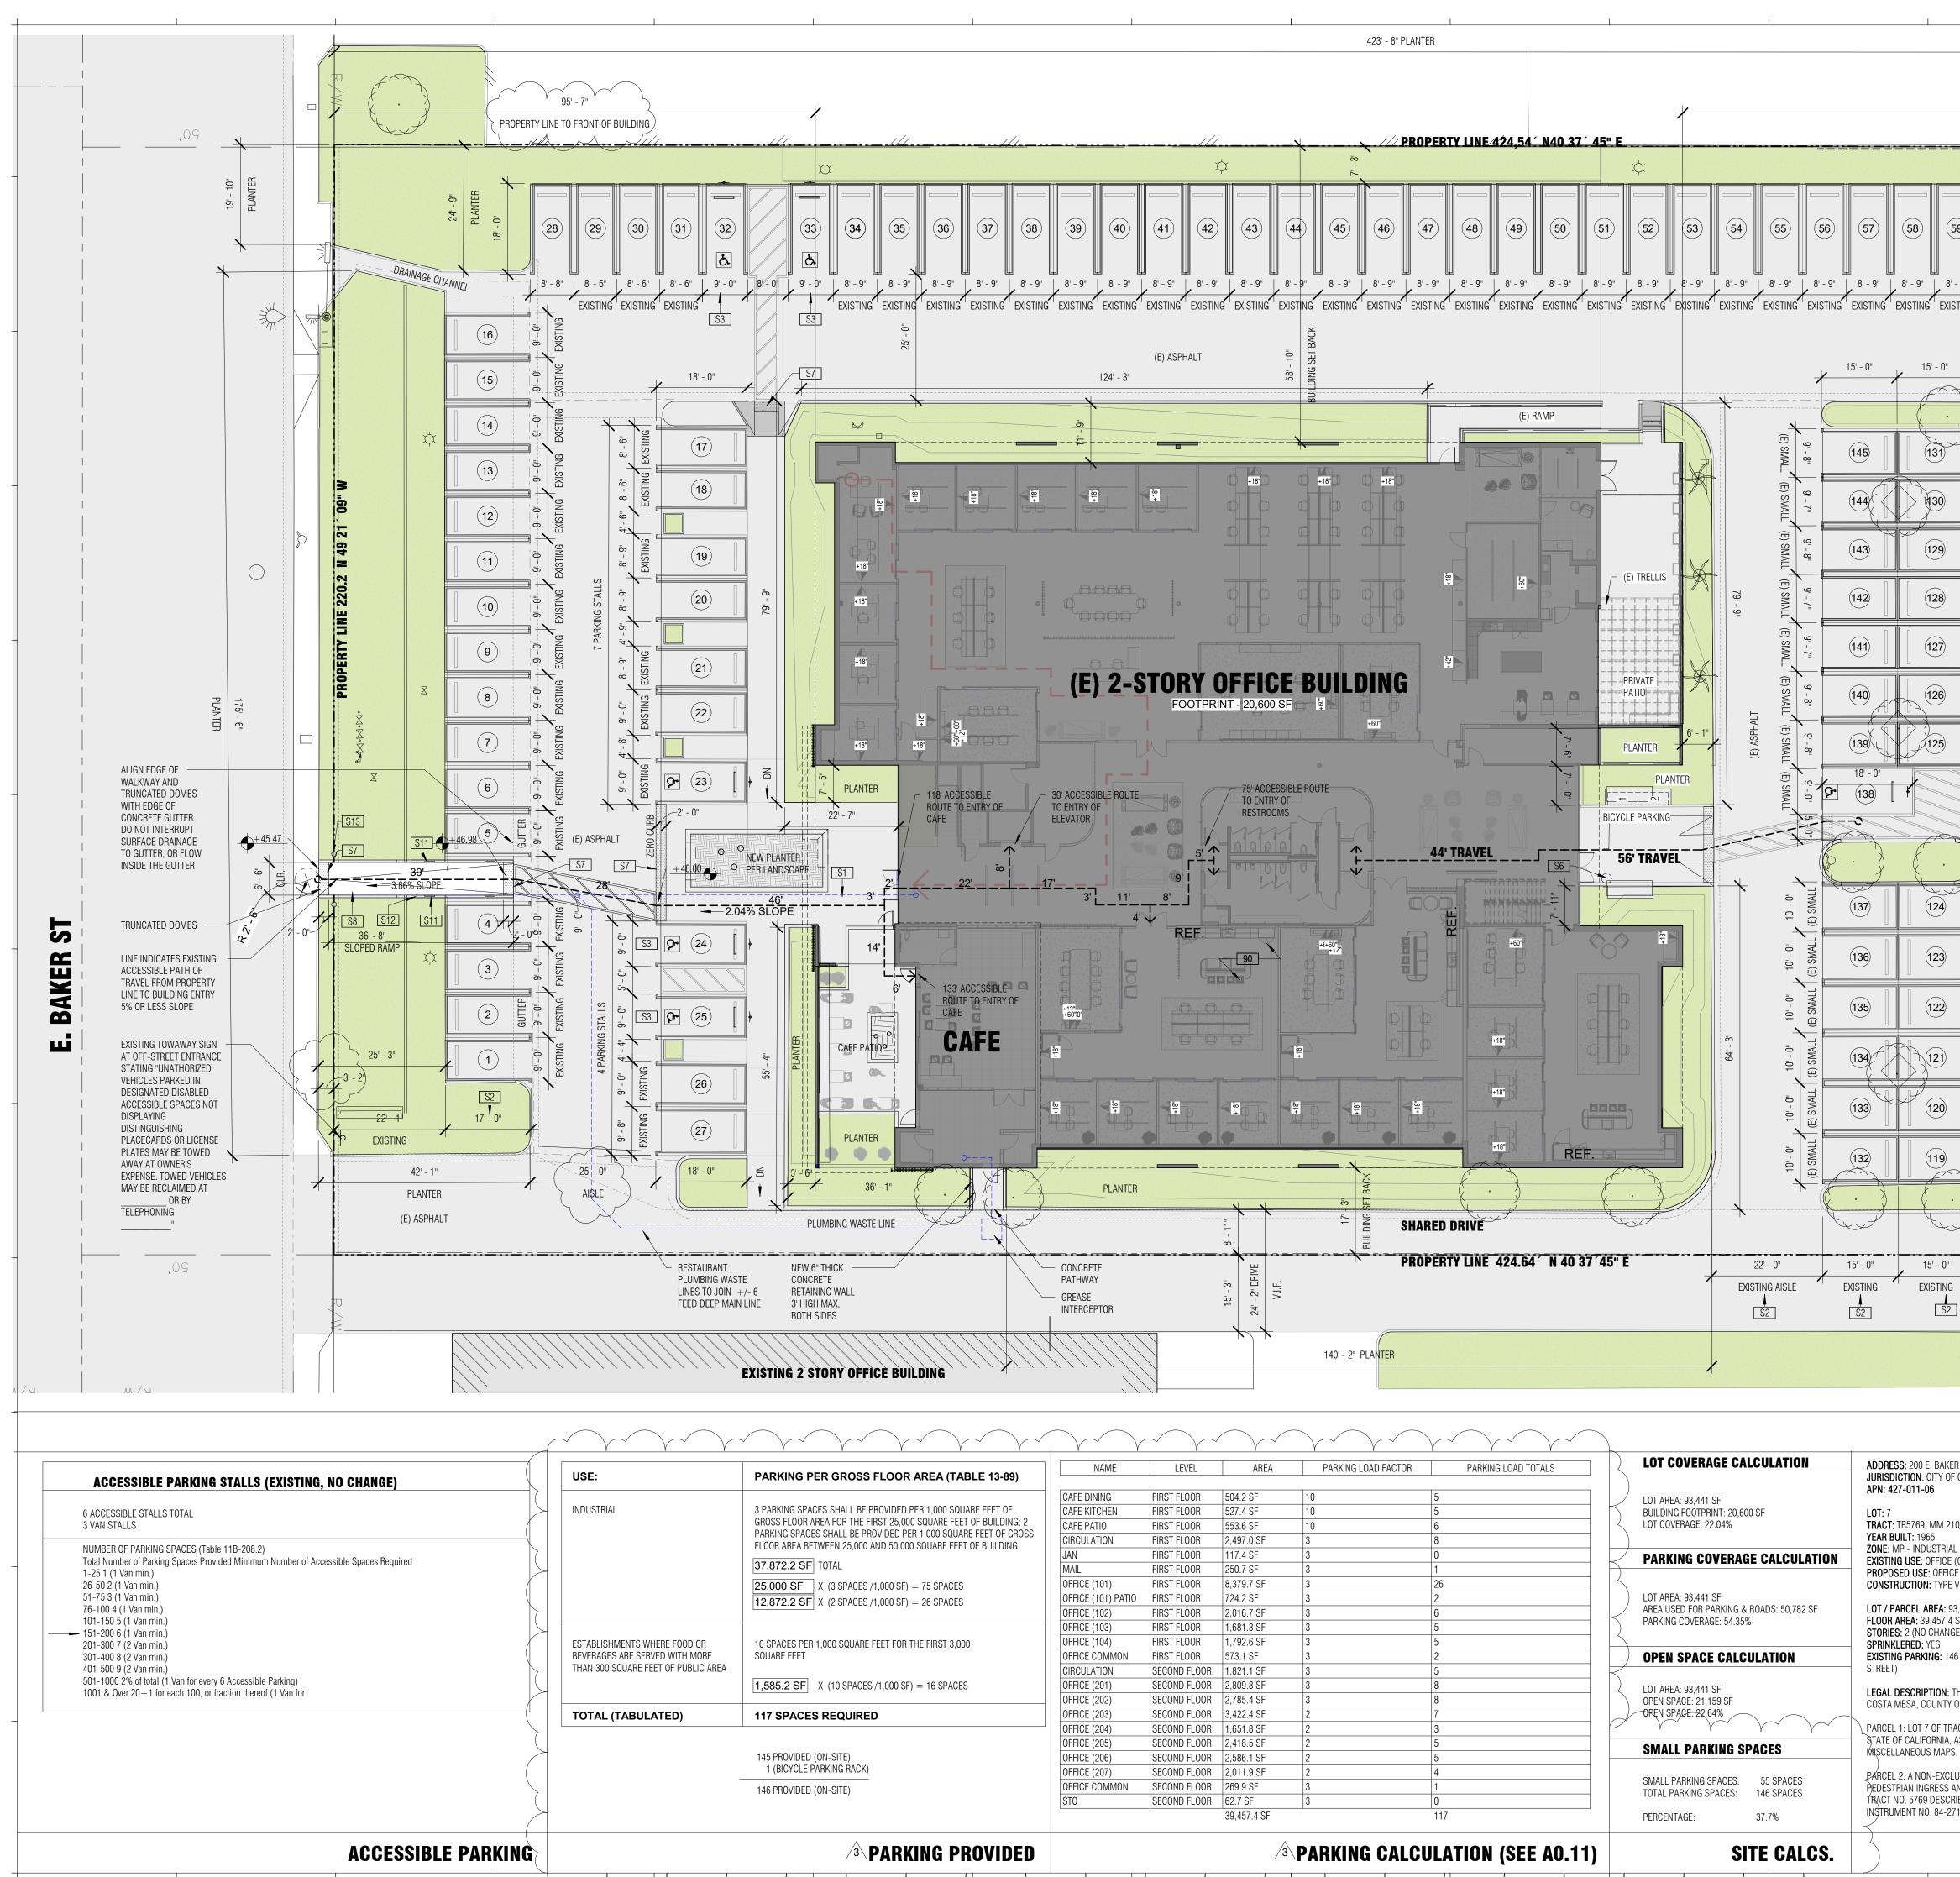



I	423' - 8" PLANTER				
		54´ N40 37´ 45" E	156' - 10" EXISTING BUILDING SETBACK		
36     37     38       8' - 9"     8' - 9"     8' - 9"       EXISTING     EXISTING     EXISTING	$\begin{array}{c ccccccccccccccccccccccccccccccccccc$		$\begin{array}{c ccccccccccccccccccccccccccccccccccc$	9" 8' - 9" ING EXISTING	WALKS-STUDIO.COM P.949.633.0977
ROUTE TO ENTRY OF TO	CE) 2-STORY OFFICE BUILDING FOOTPRINT - 20,600 SF	9 - 7' 9 - 8' 9 - 7' 9 - 8' 9 - 7' 9 - 8' 9 - 7' 9 - 8' 9 - 7' 9 - 8' 9 - 7' 9 - 8' 9 - 7' 9 - 8' 9 - 7' 9 - 8' 9 - 7' 9 - 8' 9 - 7' 9 - 8' 9 - 10' 9 -	0. 10-0' ALL (E) SMALL (E	All and all a	#       DESCRIPTION       DATE         SCHEMATIC DESIGN 1       04/28/2023         CUP SUBMISSION       05/25/2023         CUP SUBMISSION       05/25/2023         CUP SUBMISSION       05/25/2023         CUP RESUBMISSION       06/26/2023         CUP SUBMISSION       06/26/2023         CUP RESUBMISSION       06/26/2023         DESCRIPTION       DATE         SCHEMATIC DESIGN       06/26/2023         DESCRIPTION       DATE         DESCRIPTION       DATE         SCHEMATIC DESIGN 1       04/28/2023         CUP RESUBMISSION       05/25/2023         DESCRIPTION       DATE         SCHEMATIC DESIGN       06/26/2023         DESCRIPTION       DATE         SCHEMATIC DESIGN       06/26/2023         DESCRIPTION       DATE         SCHEMATIC DESIGN       06/26/2023         DESCRIPTION       DATE
	PLANTER PLA	0     0 <td><math display="block">\begin{array}{c} 0 \\ 0 \\ 0 \\ 0 \\ 0 \\ 0 \\ 0 \\ 0 \\ 0 \\ 0 </math></td> <td>10     10     0     10     <t< td=""><td>AKER Vement - Interior Reconfig. Osta mesa, ca 92626</td></t<></td>	$\begin{array}{c} 0 \\ 0 \\ 0 \\ 0 \\ 0 \\ 0 \\ 0 \\ 0 \\ 0 \\ 0 $	10     10     0     10 <t< td=""><td>AKER Vement - Interior Reconfig. Osta mesa, ca 92626</td></t<>	AKER Vement - Interior Reconfig. Osta mesa, ca 92626
ER 1,000 SQUARE FEET OF SQUARE FEET OF BUILDING; 2 R 1,000 SQUARE FEET OF GROSS SQUARE FEET OF BUILDING	NAME     LEVEL     AREA     PARKING LOAD FACTOR     PARKING LOA       CAFE DINING     FIRST FLOOR     504.2 SF     10     5       CAFE KITCHEN     FIRST FLOOR     527.4 SF     10     5       CAFE PATIO     FIRST FLOOR     53.6 SF     10     6       CIRCULATION     FIRST FLOOR     2,497.0 SF     3     8       IAN     FIRST FLOOR     117.4 SF     3     0	LOT AREA: 93,441 SF BUILDING FOOTPRINT: 20,600 SF LOT COVERAGE: 22.04% UT COVERAGE: 22.04% UT COVERAGE: 22.04% UT COVERAGE: 22.04%	210/9-10 S	SCALE: 1/16" = 1'-0" <b>O4. SITE</b> 1 PER ROOF INSPECTION REPORT, THERE ARE MULTIPLE AREAS EXPERIENCING DEFLECTION, DUE TO DAMAGED PLYWOOD DECKING DUE TO WATER INTRUSION. THE EXISING ROOF MEMBRANE IS PRONE TO LEAKS AND IS IN NEED OF DEFLECTION. AMS RECOMMENDS EITHER REPLACING THE ROOF MEMBRANE OR APPLYING A RESTORATION COATING TO WATERTIGHT THE EXISTING ROOF PER PLUMBING REPORT, EXCAVATE ASPHALT APPROXIMATELY 6 FEET DEEP, UPSTREAM 6 TO 10 INCHES UNDER CONCRETE APROL TO GET TO THE OFFSET PIE TO RECONFIGURE / FIX THE OFFSET AND INSTALL A DUAL SWEEP CLEAN OUT FROM THE	<b>ZOO BA</b> APN: 427-011-06 200 BAKER ST E, CC
= 75 SPACES = 26 SPACES THE FIRST 3,000 ) = 16 SPACES	JAN         FIRST FLOOR         117.4 SF         3         0           MAIL         FIRST FLOOR         250.7 SF         3         1           OFFICE (101)         FIRST FLOOR         8,379.7 SF         3         26           OFFICE (101)         FIRST FLOOR         8,379.7 SF         3         2           OFFICE (101)         FIRST FLOOR         724.2 SF         3         2           OFFICE (102)         FIRST FLOOR         2,016.7 SF         3         6           OFFICE (102)         FIRST FLOOR         1,681.3 SF         3         5           OFFICE (103)         FIRST FLOOR         1,681.3 SF         3         5           OFFICE (104)         FIRST FLOOR         1,792.6 SF         3         5           OFFICE (104)         FIRST FLOOR         573.1 SF         3         2           CIRCULATION         SECOND FLOOR         1,821.1 SF         3         5           OFFICE (201)         SECOND FLOOR         2,899.8 SF         3         8           OFFICE (202)         SECOND FLOOR         2,785.4 SF         3         8           OFFICE (203)         SECOND FLOOR         3,422.4 SF         2         7           OFFICE (204) <t< td=""><td>PARKING COVERAGE CALCULATIONEXISTING USE: 0FFILOT AREA: 93,441 SF AREA USED FOR PARKING &amp; ROADS: 50,782 SF PARKING COVERAGE: 54.35%LOT / PARCEL AREA FLOOR AREA: 39,453 STORIES: 2 (NO CHA SPRINKLERED: YES EXISTING PARKING: STREET)LOT / PARCEL AREA FLOOR AREA: 39,453 STORIES: 2 (NO CHA SPRINKLERED: YES EXISTING PARKING: STREET)LOT AREA: 93,441 SF OPEN SPACE: 21,159 SF OPEN SPACE: 21,159 SF OPEN SPACE: 22,64%LEGAL DESCRIPTION COSTA MESA, COUN PARCEL 1: LOT 7 OF STATE OF CALIFORN MSCELLANEOUS MASMALL PARKING SPACES: TOTAL PARKING SPACES: TOTAL PARKING SPACES: 146 SPACESSACES TAGE PARCES</td><td>CE (GROUP B)       S.         FICE (GROUP B) &amp; RESTAURANT (GROUP A-2)       S.         PE V-A (NO CHANGE)       S.         S: 93,441 SQUARE FEET (2.145 AC)       .4 SF         NGE)       S.         146 SPACES (ONE SPACE REMOVED FOR ADA ACCESSIBLE PATH FROM S.       S.         I: THE LAND HERINAFTER REFERRED TO IS SITUATED IN THE CITY OF TY OF ORANGE, STATE OF CA, AND IS DESCRIBED AS FOLLOWS       S.         IRACT NO. 5769, IN THE CITY OF COSTA MESA, COUNTY OF ORANGE, A, AS SHOWN ON MAP RECORDED IN BOOK 210, PAGES 9 AND 10, OF PS, IN THE OFFICE OF THE COUNTY RECORDER OF SAID COUNTY.       S.         CLUSIVE EASEMENT FOR THE PURPOSE OF VEHICULAR AND S AND INCEDENTAL PURPOSES, OVER THAT PORTION OF LOT 8 OF SAID CRIBED IN THAT CERTAIN DOCUMENT RECORDED JUNE 29, 1984 AS       S</td><td><ul> <li>UPSTREAM. SEE PLUMBING REPORT BY JULIO'S ECONOMY PLUMBING, INC.</li> <li>SEE EXISTING PERMITTED SITE PLAN / PARKING PLAN ON SHEET A0.04. THIS PLAN CONTAINS EXISTING DIMENSIONS. NOTE, EXCEPTION 7 IN THE CITY OF COSTA MESA PARKING DESIGN STANDARDS STATES: WHEN NECESSARY DUE TO CONSTAINTS, MINOR REDUCTIONS IN THE AISLE WIDTH MAY BE APPROVED BY THE PLANNING DIVISION, PROVIDED THE STALL WIDTH IS INCREASED ACCORDINGLY</li> <li>RESTRIPE ACCESSIBLE PARKING TO MEET ACCESSIBLE PARKING STALL STANDARD DIMENSIONS, AS SHOWN ON PLAN 18FT DEPTH</li> <li>CONFIRM EXISTING PARKING STOPS MEET THE CODE REQUIRED 2FT OVERHANG, MODIFY AS NECESSARY TO MEET CODE</li> <li>(E) ACCESSIBLE PUSH BUTTON TO OPEN BUILDING DOOR</li> <li>PROVIDE YELLOW TRUNCATED DOMES SPECIFICATION: STEPSTONE, INC - TRUNCATED DOME PAVER 2 - DAVID FEDERAL YELLOW LIGHT SANDBLAST 1814. CHIP OUT EXISTING CONCRETE SO TRUNCATED DOME TILES ARE FLUSH WITH EXISTING CONCRETE</li> <li>ACCESSIBLE PATH FROM PUBLIC RIGHT-OF-WAY. SEE PREVIOUSLY PERMITTED PATHWAY ON SHEET A1.03</li> <li>RECESSED LINEAR PATH LIGHT BOTH SIDES</li> <li>6" CONCRETE RETAINING WALL, BOARD FORMED 3'-6" TALL, BOTH SIDES. PROVIDE</li> </ul></td><td>STEPLAN SCALE: as noted DATE: 08/30/2023 JOB NUMBER: 031 DRAWN BY: SHEET:</td></t<>	PARKING COVERAGE CALCULATIONEXISTING USE: 0FFILOT AREA: 93,441 SF AREA USED FOR PARKING & ROADS: 50,782 SF PARKING COVERAGE: 54.35%LOT / PARCEL AREA FLOOR AREA: 39,453 STORIES: 2 (NO CHA SPRINKLERED: YES EXISTING PARKING: STREET)LOT / PARCEL AREA FLOOR AREA: 39,453 STORIES: 2 (NO CHA SPRINKLERED: YES EXISTING PARKING: STREET)LOT AREA: 93,441 SF OPEN SPACE: 21,159 SF OPEN SPACE: 21,159 SF OPEN SPACE: 22,64%LEGAL DESCRIPTION COSTA MESA, COUN PARCEL 1: LOT 7 OF STATE OF CALIFORN MSCELLANEOUS MASMALL PARKING SPACES: TOTAL PARKING SPACES: TOTAL PARKING SPACES: 146 SPACESSACES TAGE PARCES	CE (GROUP B)       S.         FICE (GROUP B) & RESTAURANT (GROUP A-2)       S.         PE V-A (NO CHANGE)       S.         S: 93,441 SQUARE FEET (2.145 AC)       .4 SF         NGE)       S.         146 SPACES (ONE SPACE REMOVED FOR ADA ACCESSIBLE PATH FROM S.       S.         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PROVIDE</li> </ul>	STEPLAN SCALE: as noted DATE: 08/30/2023 JOB NUMBER: 031 DRAWN BY: SHEET:
XING PROVIDED	39,457.4 SF 117	PERCENTAGE: 37.7%	-271431	MOCK-UP OF BOARD FORM PRIOR TO CONSTRUCITON 13 BEGA BOLLARD (GET SPEC FROM LANDSCAPE) SHEET NOTES	<b>A0.02</b>




	///	<u></u>	<u>) 37´ 45" E</u>	
	\$		ф.	
17 18 19 20	21 22 23 24 25		1 32 33 34 35	1 2 3 4
			(E) TRELLIS (E) TRELLIS PATIO PATIO PATIO PLANTER	
(E) 2-	STORY OFFICE BUI	LDING	BICYCLE STALL	
CAFE				
		SHARED DRIVE		
		PROPERTY LINE 424.64´N4	40 37´45" E	

NAME	LEVEL	AREA	PARKING LOAD FACTOR	PARKING LOAD TOTALS
				- 1
CAFE DINING	FIRST FLOOR	504.2 SF	10	5
CAFE KITCHEN	FIRST FLOOR	527.4 SF	10	5
CAFE PATIO	FIRST FLOOR	553.6 SF	10	6
CIRCULATION	FIRST FLOOR	2,497.0 SF	3	8
JAN	FIRST FLOOR	117.4 SF	3	0
MAIL	FIRST FLOOR	250.7 SF	3	1 VISITOR
OFFICE (101)	FIRST FLOOR	8,379.7 SF	3	26
OFFICE (101) PATIO	FIRST FLOOR	724.2 SF	3	2
OFFICE (102)	FIRST FLOOR	2,016.7 SF	3	6
OFFICE (103)	FIRST FLOOR	1,681.3 SF	3	5
OFFICE (104)	FIRST FLOOR	1,792.6 SF	3	5
OFFICE COMMON	FIRST FLOOR	573.1 SF	3	2 VISITOR
CIRCULATION	SECOND FLOOR	1,821.1 SF	3	5
OFFICE (201)	SECOND FLOOR	2,809.8 SF	3	8
OFFICE (202)	SECOND FLOOR	2,785.4 SF	3	8
OFFICE (203)	SECOND FLOOR	3,422.4 SF	2	7
OFFICE (204)	SECOND FLOOR	1,651.8 SF	2	3
OFFICE (205)	SECOND FLOOR	2,418.5 SF	2	5
OFFICE (206)	SECOND FLOOR	2,586.1 SF	2	5
OFFICE (207)	SECOND FLOOR	2,011.9 SF	2	4
OFFICE COMMON	SECOND FLOOR	269.9 SF	3	1 VISITOR
STO	SECOND FLOOR	62.7 SF	3	0
		39,457.4 SF		117

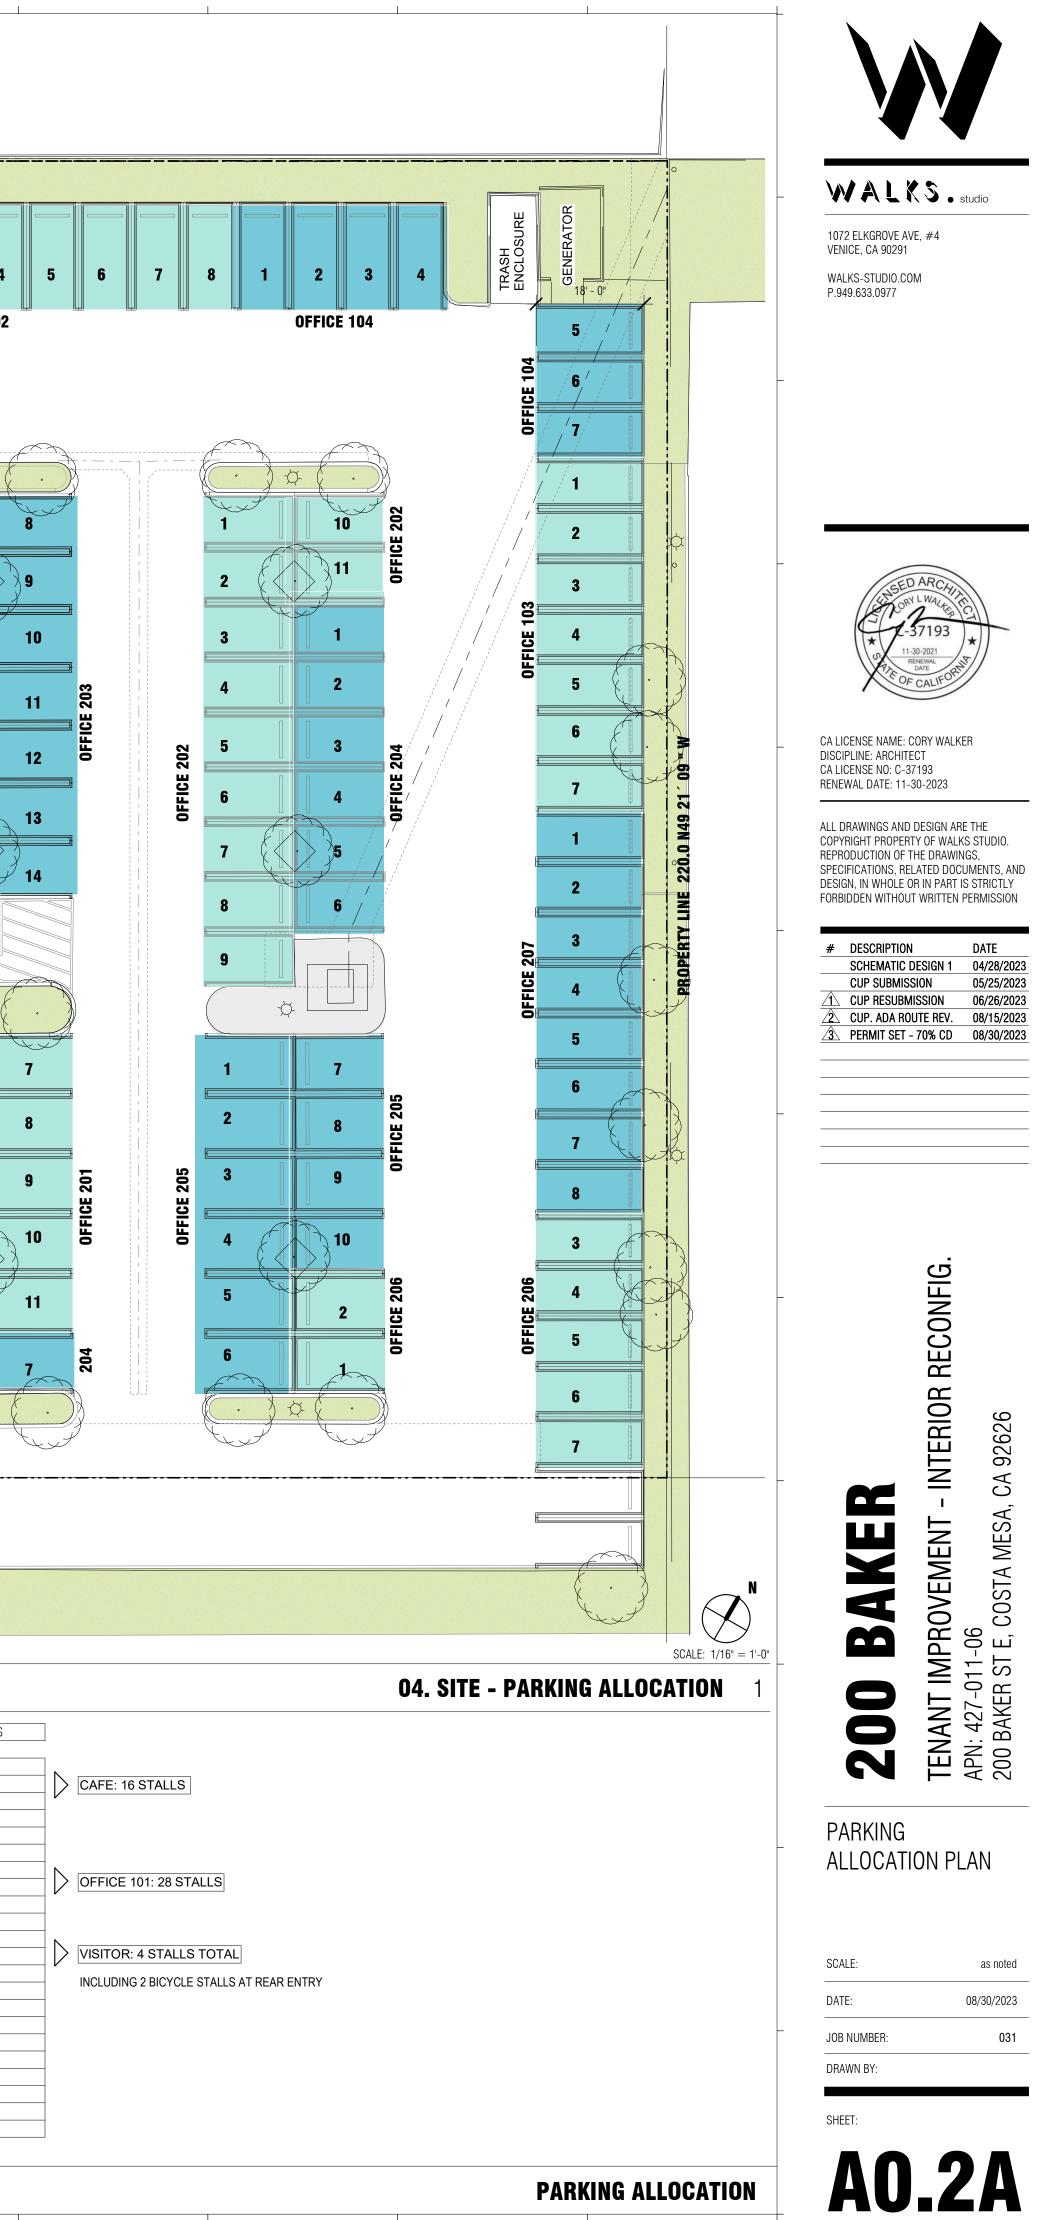


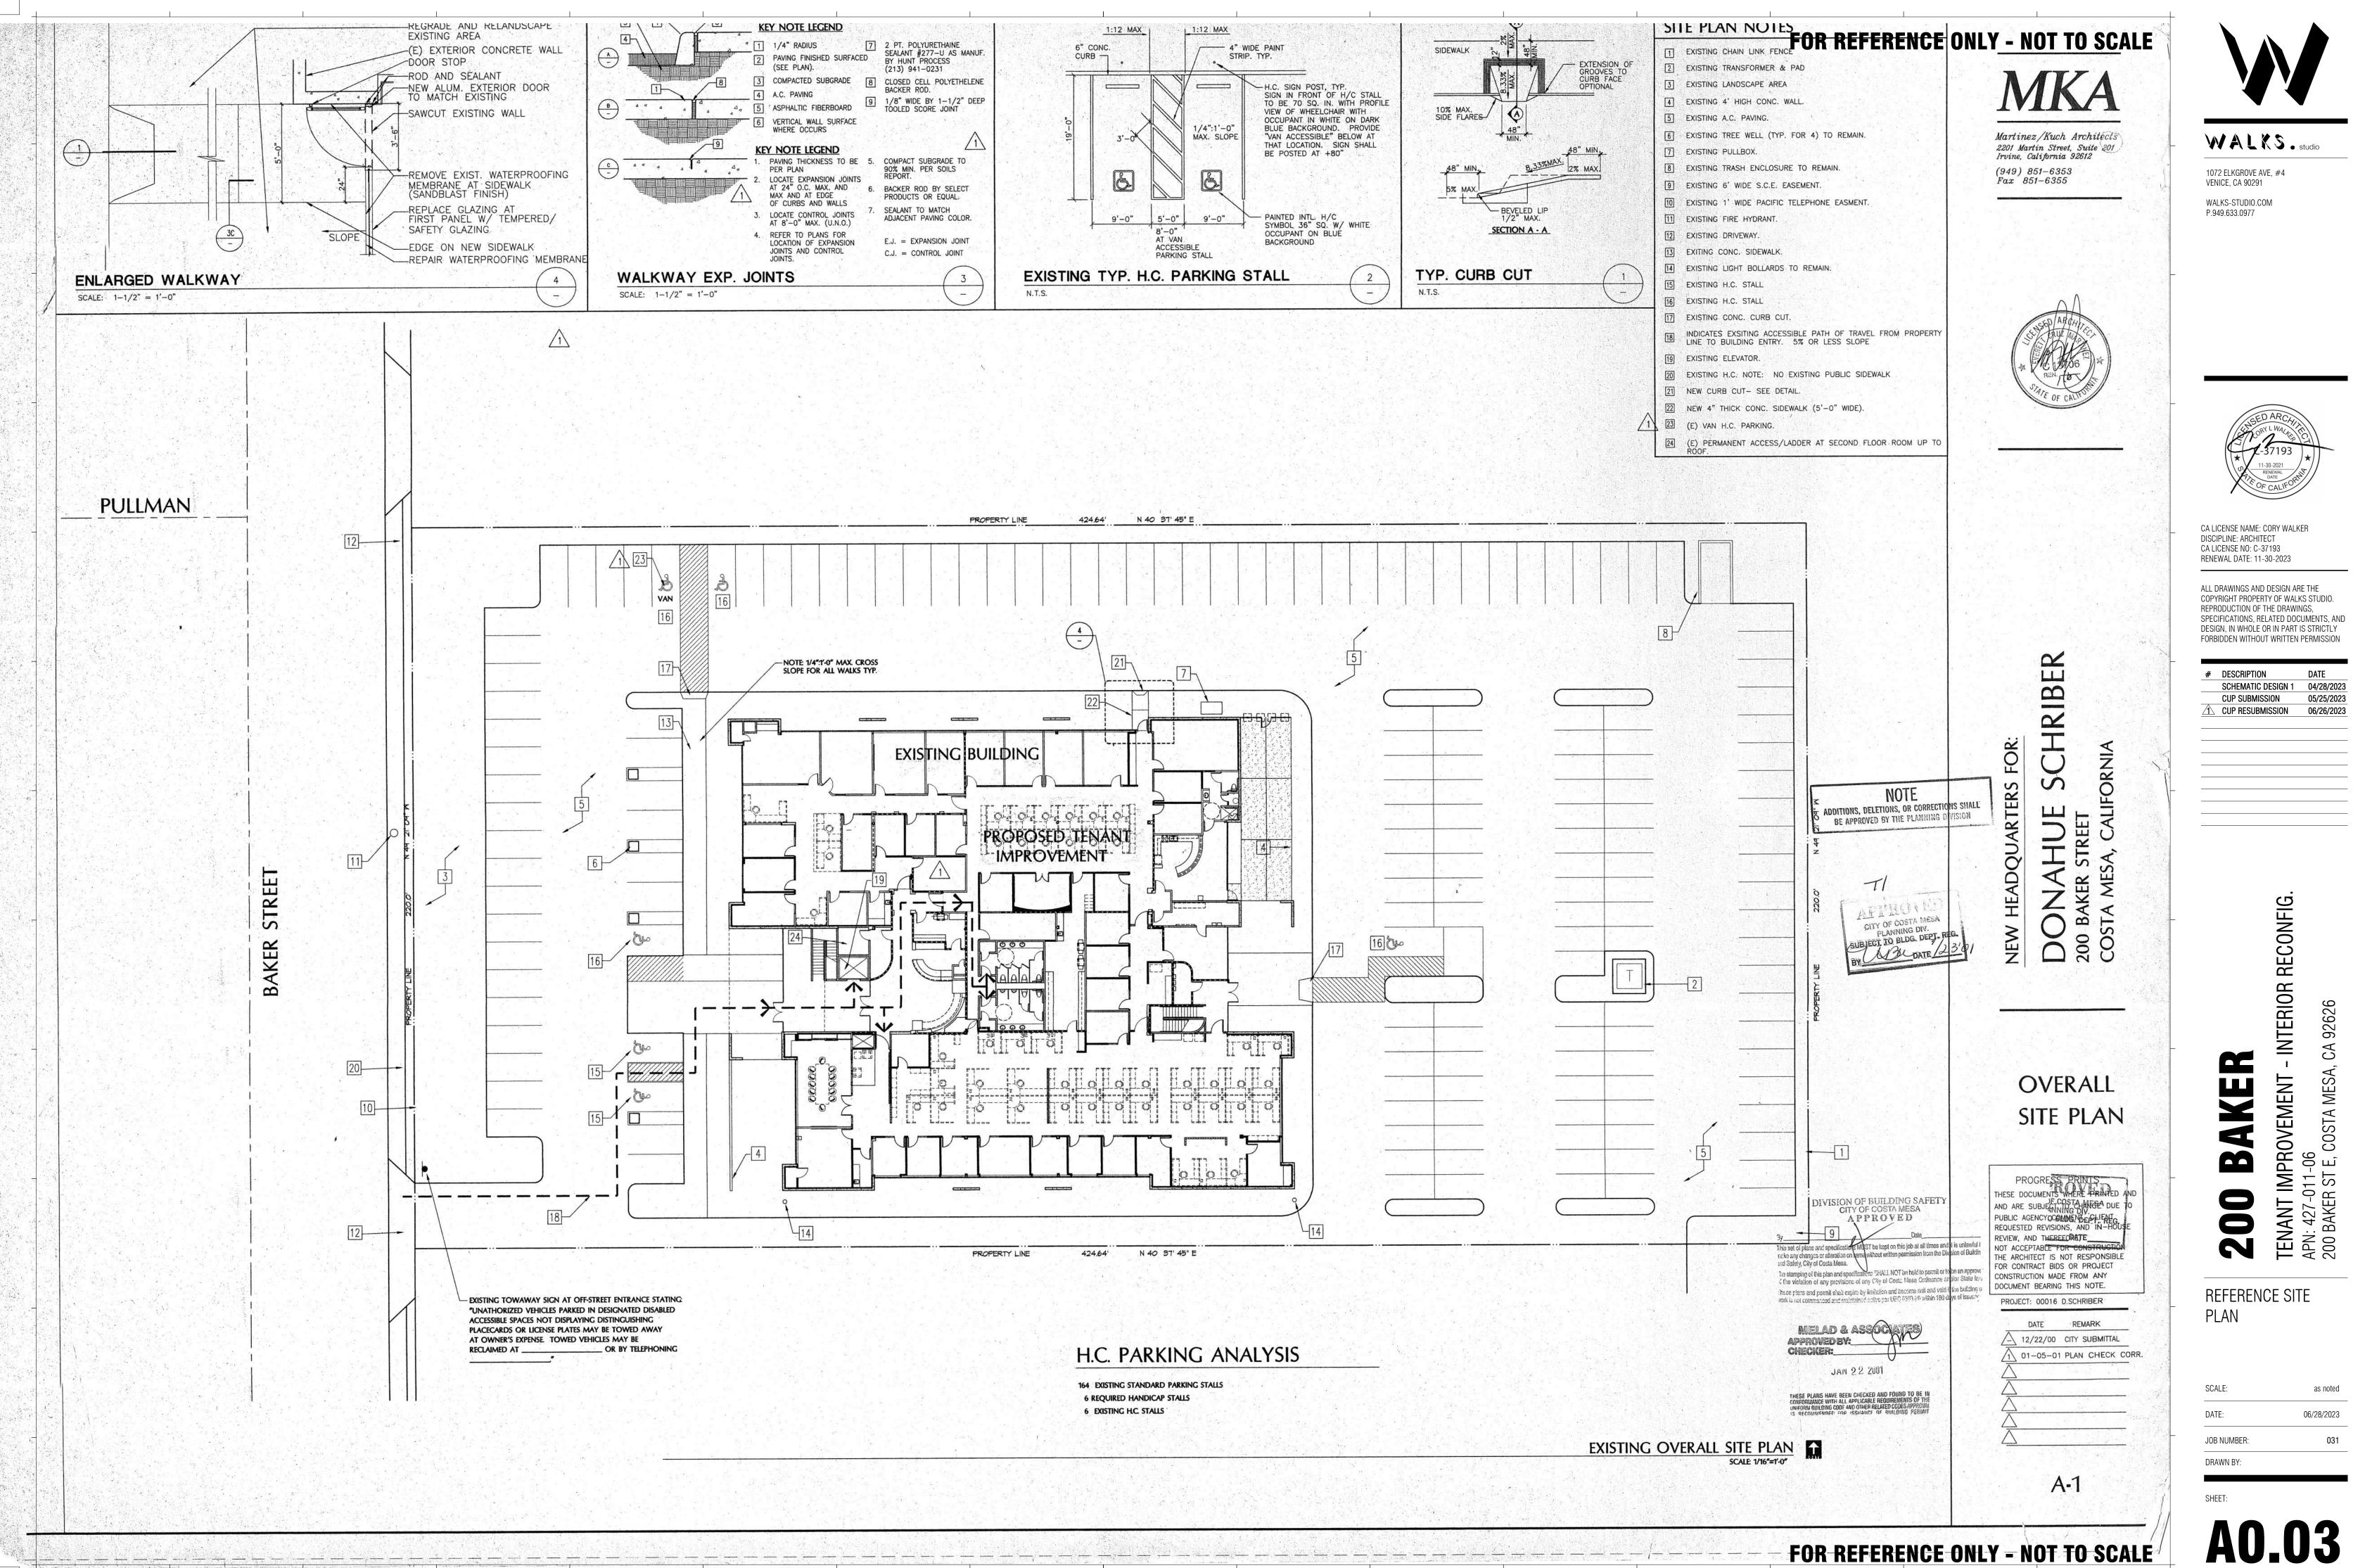

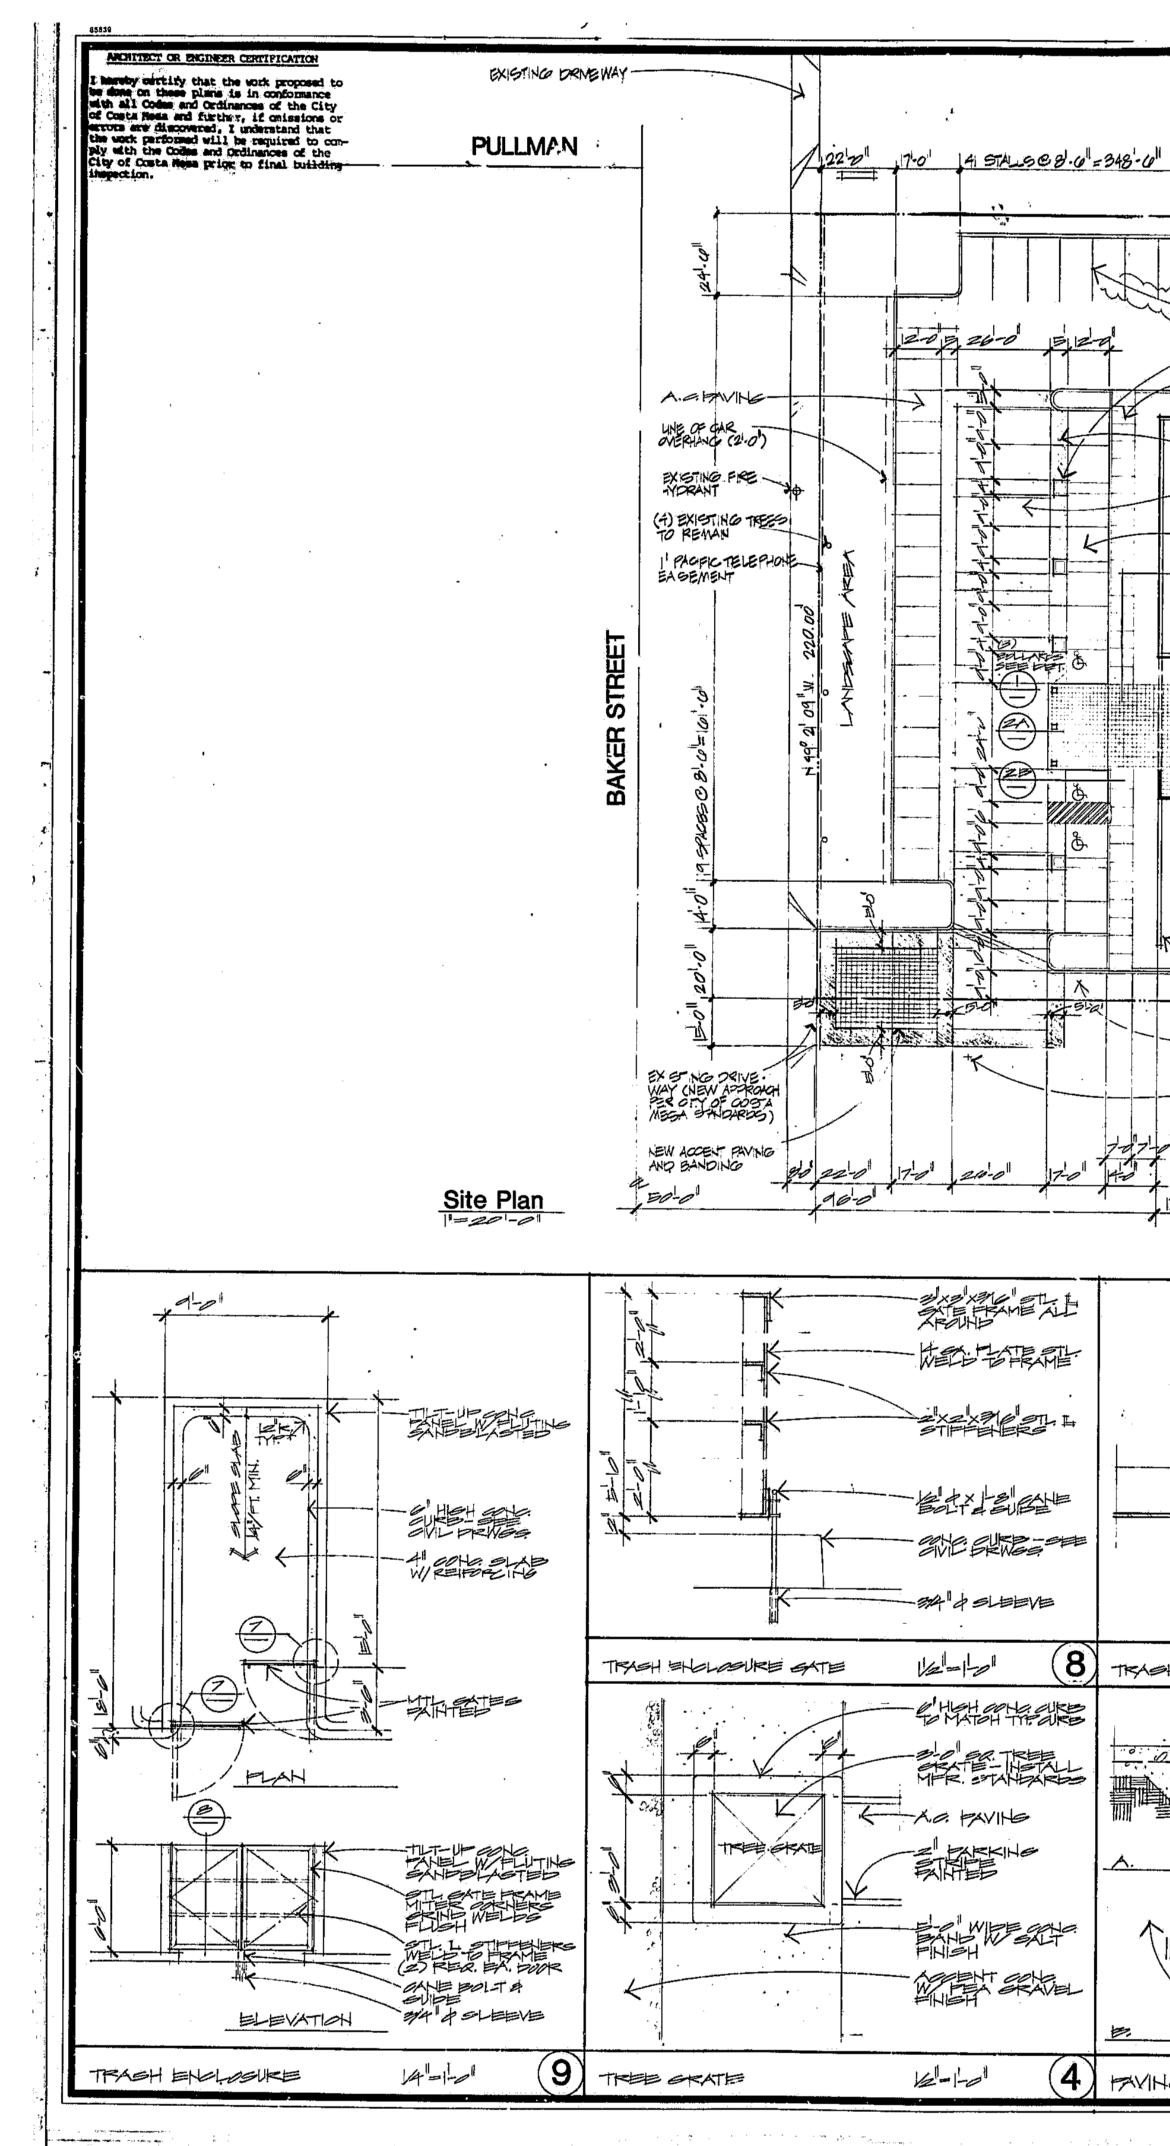


37-2 1-01 5-0 424,04 H 40° 37 45 E PLANTING AREA TV NOTE: ALL PARKING STALLS () AC TO BE DOUBLE STRIPED-PER () CITY OF COSTANDED STANDARDS () S 98, TREE WELL (TP. FORA) SEE PET (-) BUMPER STOPS REPD. ON ALL STALLS NOT ABU. TO CUPP-PER OTTOPOM STOP AC PAMING (7)  $\blacksquare$ -7 WIDE CONC. SIDEWALK A HIGH CONC WALL-PLANTING AREA  $\overline{}$ L'Y INTEGRAL COLOR CONE BANDING WISALT FINISH PULL-BOX-SEE ELEOT. .... · . .. -INTEGRAL ALAR AND. W PEA GRAVEL FINISH ACTAMNE BA C  $\bigcirc$ -----TWO STORY BUILDING \_\_\_\_ B  $\bigcirc$ WERE HTEL æ B ---------\_\_\_\_\_ \_\_\_\_ - AUTTER SEE AVIL ENGS LIGHT BALLARDS PLANING AREA ->> i 4 HIGH CONC. WALL N 40° 37'45"E 624.04 PROPERTYLINE -4 (NEW AC BWINGN BRIVEWAY (NEW AC BWING) RESURFACE AND CARDONING RESURFACE AND CARDONING PROPERTY OF COMMON PRIVE  $\overline{a}$   $\underline{a}$ -existing trees on ADJOINING PROPERTY 72-0 5-01 22-0 -FUTINE WERE WALL BEAND  $\sim$ + ... † -AMMENDED SOL SEE LANDSATE DRAWINGS SKHERLASTED 0 .... -BACKER BAKD WON ATE WALL SEE EARTH-SLOPE TO BRAIN 12 FINAL - 244 CHAMPER. TYP: -WATERPROPING B HXH SWASED HLAIN HINSE WELDED TO STL: PLATE JAME (2) RER. EX. DOOR T O PEPER TO STRUCT'L. DWGS. FOR FOUNDATION NOTEST PETALS · · · · . . 7 #4"=1-0", A(6) TRACH ENCLOSURE GATE PLANTER WALL LANTER WALL 121592.1 EN SE FAVERS Co A # REFAR @24 0 Cot to KEBAK 024 17 EXPANSION JOINT <u>...</u> CONC. BANDING THE SETTING DEED DE SETTINO DES HA FOOTING Ha FOOTING # PREBAR @2 (4) HAVING (3) FAVING (2)1/2=---LIGHT BOLLARD

-7-

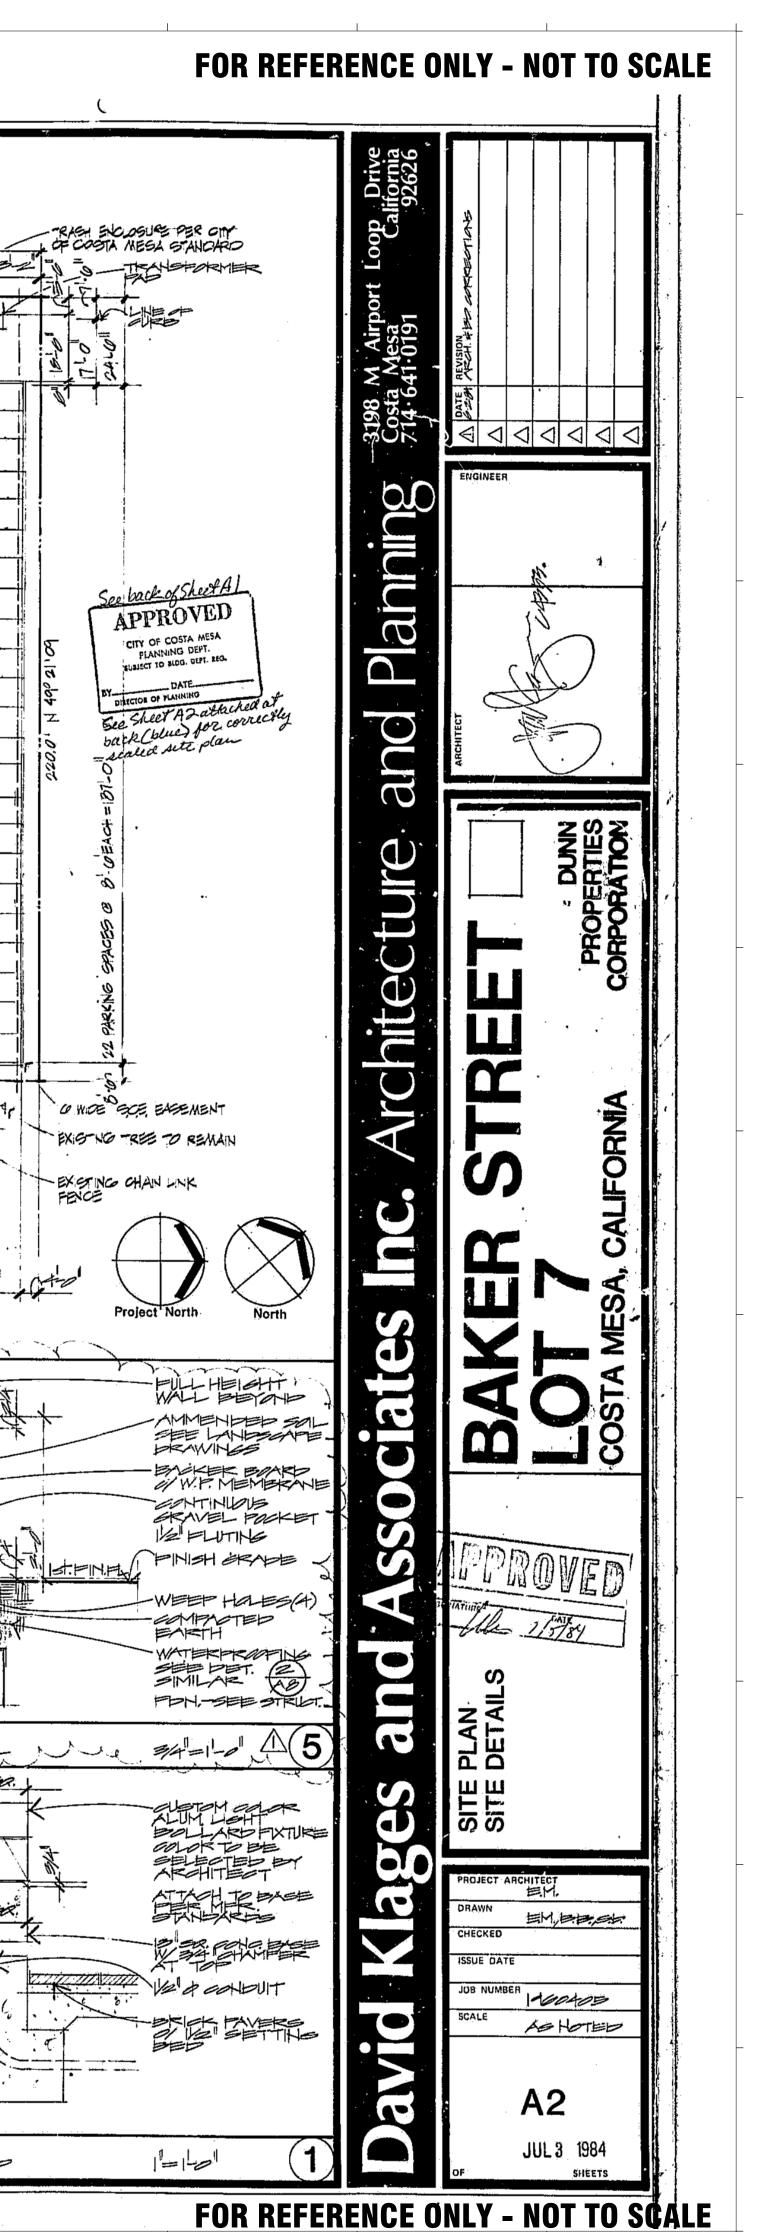

ARCHINCS 193 0-2021
ARCHINE LW42/E89 7193
2 <sup>1</sup> √ <sup>2</sup> / <sub>5</sub> 101 7193 ★
DRY WALKER CALIFOT T 193 0-2023 DESIGN ARE THE Y OF WALKS STUDIO. HE DRAWINGS, ATED DOCUMENTS, A B IN PART IS STRICT
R IN PART IS STRICTL WRITTEN PERMISSIO
DATE ESIGN 1 04/28/20 ION 05/25/20
SSION 06/26/2
TENANT IMPROVEMENT - INTERIOR RECONFIG. APN: 427-011-06 200 BAKER ST E. COSTA MESA. CA 92626
TENAN APN: 42 200 BAK
E PARKING
as note
06/28/202

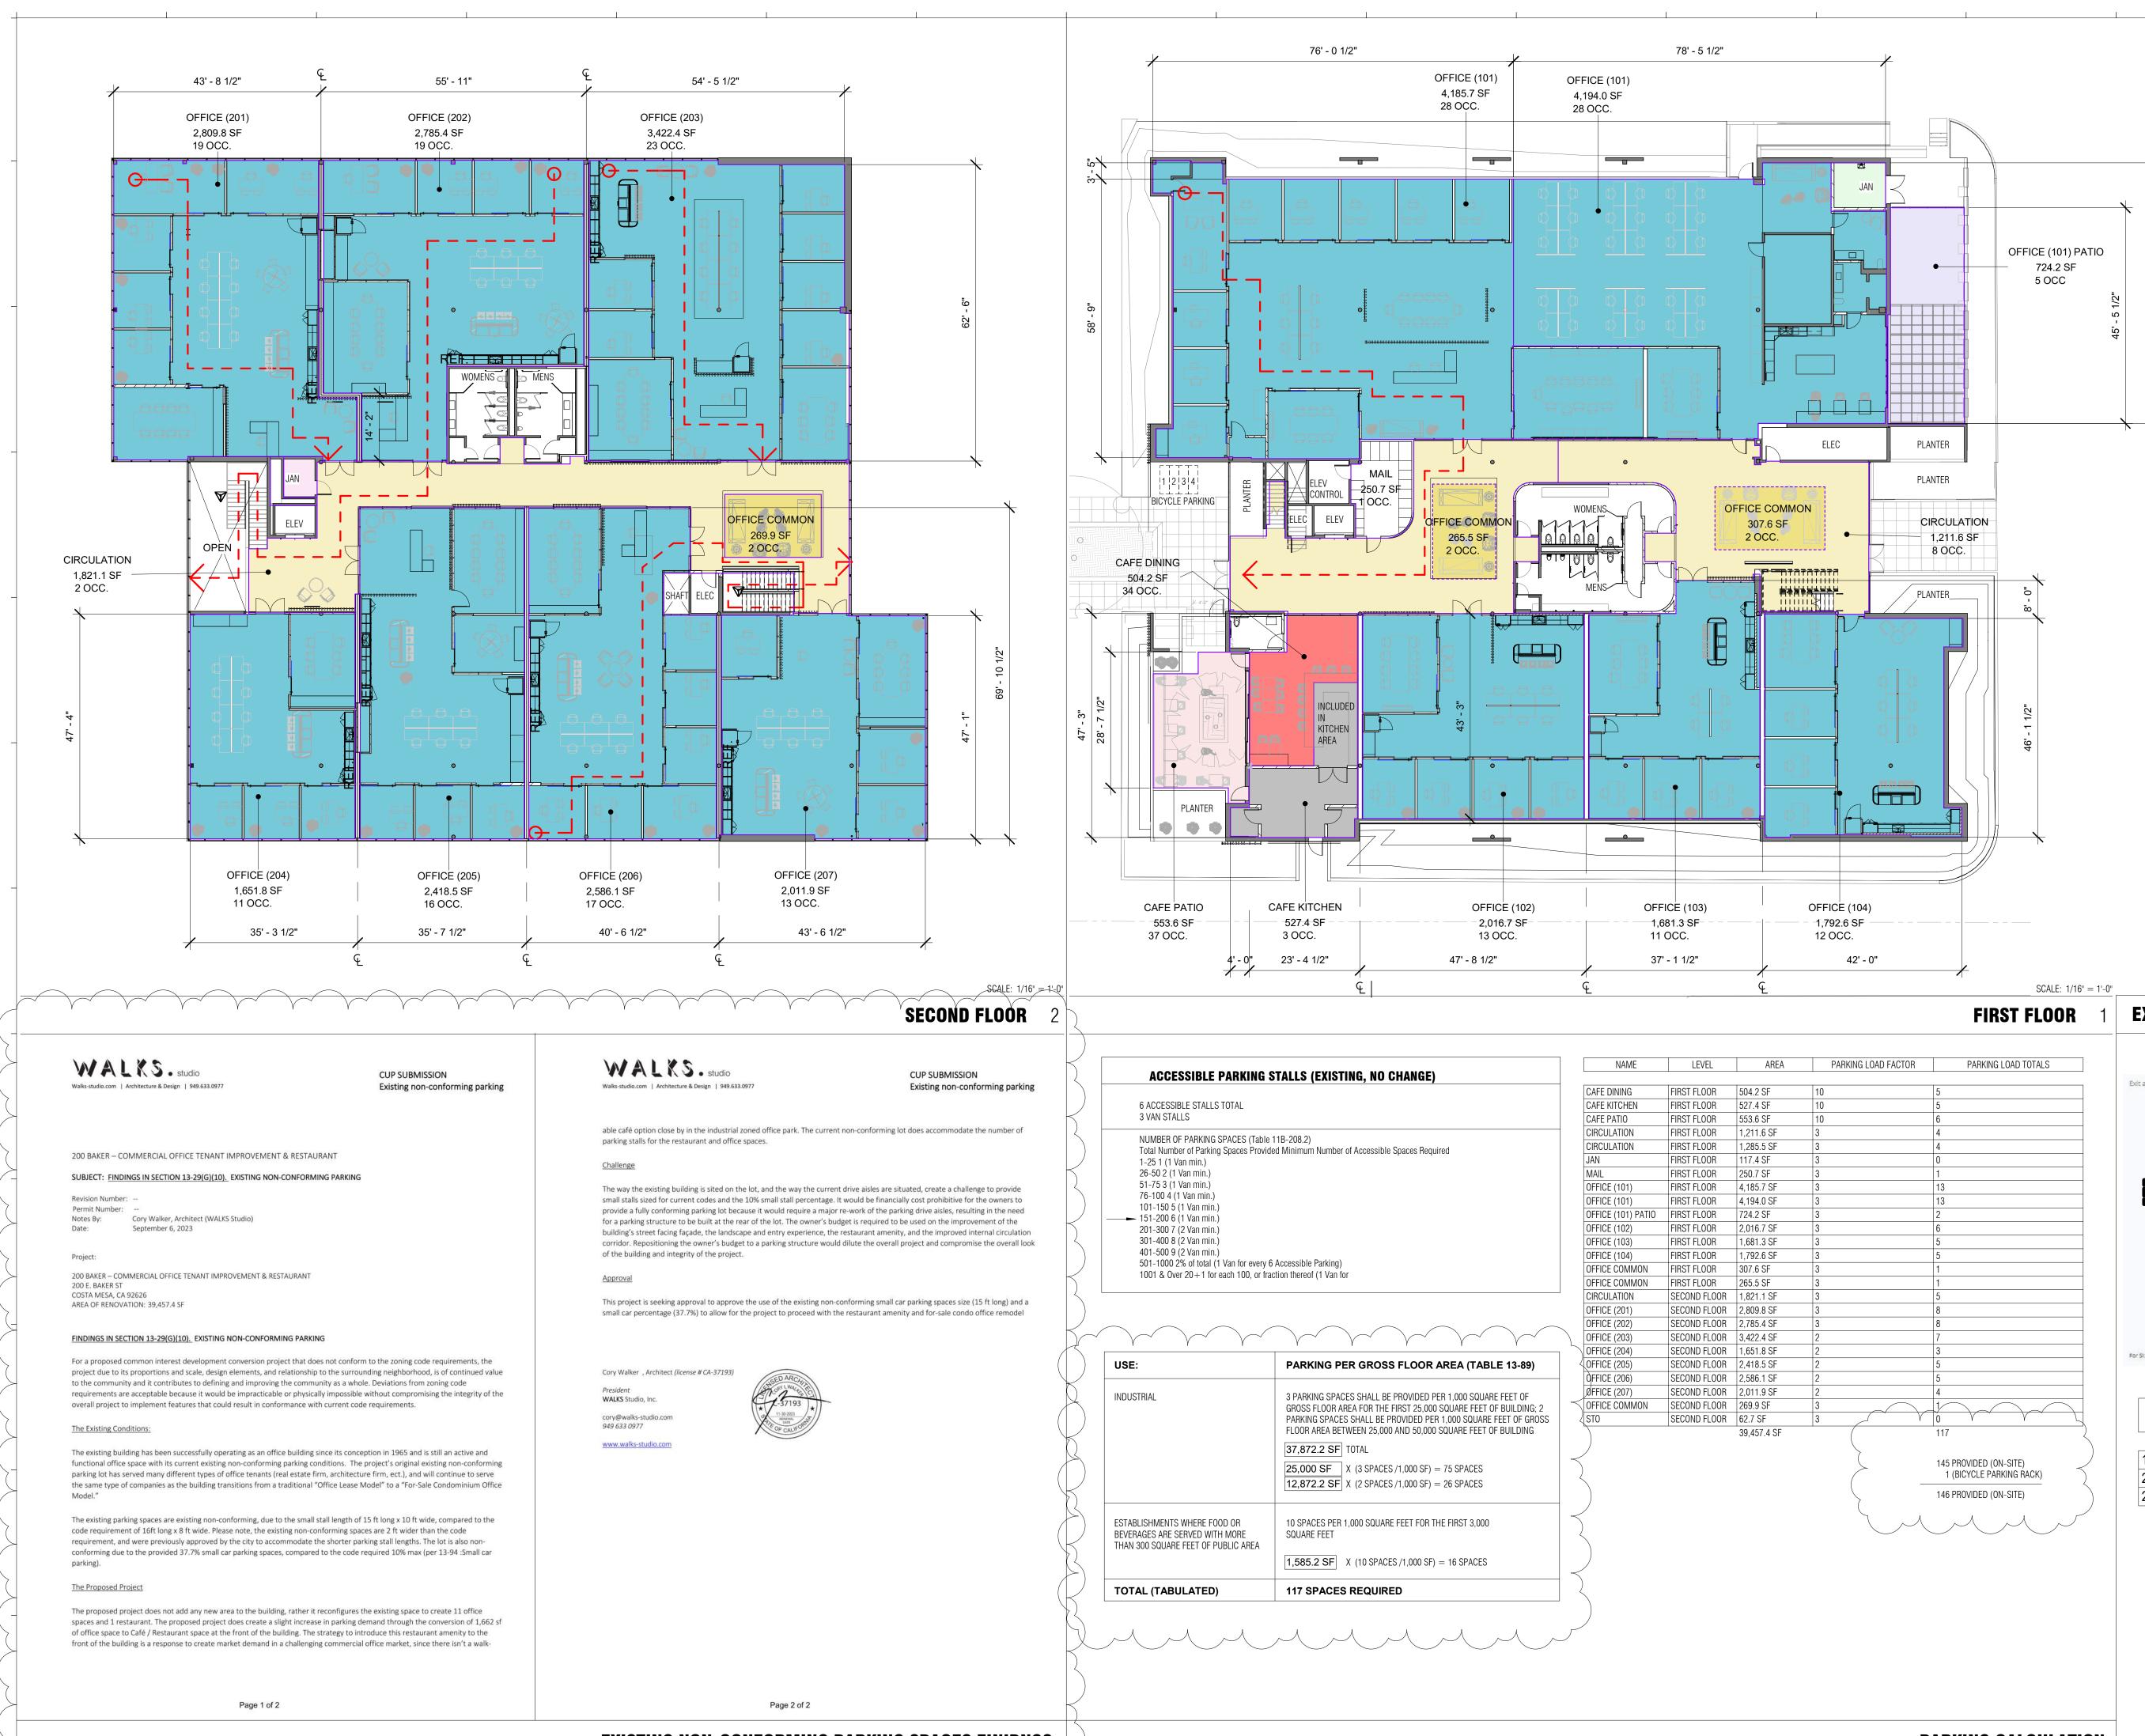

**EXISTING NON-CONFORMING PARKING SPACES FINIDNGS** 

-8-

# EXIT TRAVEL DISTANCE

	TABLE 1017.2	
EXJ	T ACCESS TRAVEL DISTAI	NCE <sup>a</sup>
OCCUPANCY	WITHOUT SPRINKLER SYSTEM (feet)	WITH SPRINKLER SYSTEM (feet)
A, E, F-1, M, R, S-1	200 <sup>e</sup>	250 <sup>b</sup>
R-2.1	Not Permitted	250 <sup>b</sup>
В	200	300 <sup>c</sup>
F-2, 5-2, U		400-
H-1	Not Permitted	75 <sup>d</sup>
H-2	Not Permitted	100 <sup>d</sup>
H-3	Not Permitted	150 <sup>d</sup>
H-4	Not Permitted	175 <sup>d</sup>
H-5	Not Permitted	200 <sup>c</sup>
1-2, 1-2.1, 1-3	Not Permitted	200 <sup>c</sup>
1-4	150	200 <sup>c</sup>
L	Not Permitted	200 <sup>1</sup>

ID	OCC	EXIT PATH	MAX ALLOWABLE DISTANCE
101	В	186'	300' - 0"
202	В	197'	300' - 0"
206	В	179'	300' - 0"

WALKS	studio
ANSED ARCAIL SED ARCAIL ORY L WALLES 1-37193 11-30-2021 RENEWAL DATE OF CALIFORM	ACCT * M
CA LICENSE NAME: CORY WALK DISCIPLINE: ARCHITECT CA LICENSE NO: C-37193 RENEWAL DATE: 11-30-2023 ALL DRAWINGS AND DESIGN AR COPYRIGHT PROPERTY OF WALK REPRODUCTION OF THE DRAWIN SPECIFICATIONS, RELATED DOC DESIGN, IN WHOLE OR IN PART I FORBIDDEN WITHOUT WRITTEN	E THE (S STUDIO. NGS, UMENTS, AND S STRICTLY
#       DESCRIPTION         SCHEMATIC DESIGN 1       CUP SUBMISSION         ①       CUP RESUBMISSION         ②       CUP. ADA ROUTE REV.         ③       PERMIT SET - 70% CD	DATE 04/28/2023 05/25/2023 06/26/2023 08/15/2023 08/30/2023




# CODE ANALYSIS -PARKING ANALYSIS

SCALE:	as noted
DATE:	08/30/2023
JOB NUMBER:	031
DRAWN BY:	



SHEET:

**PARKING CALCULATION** 

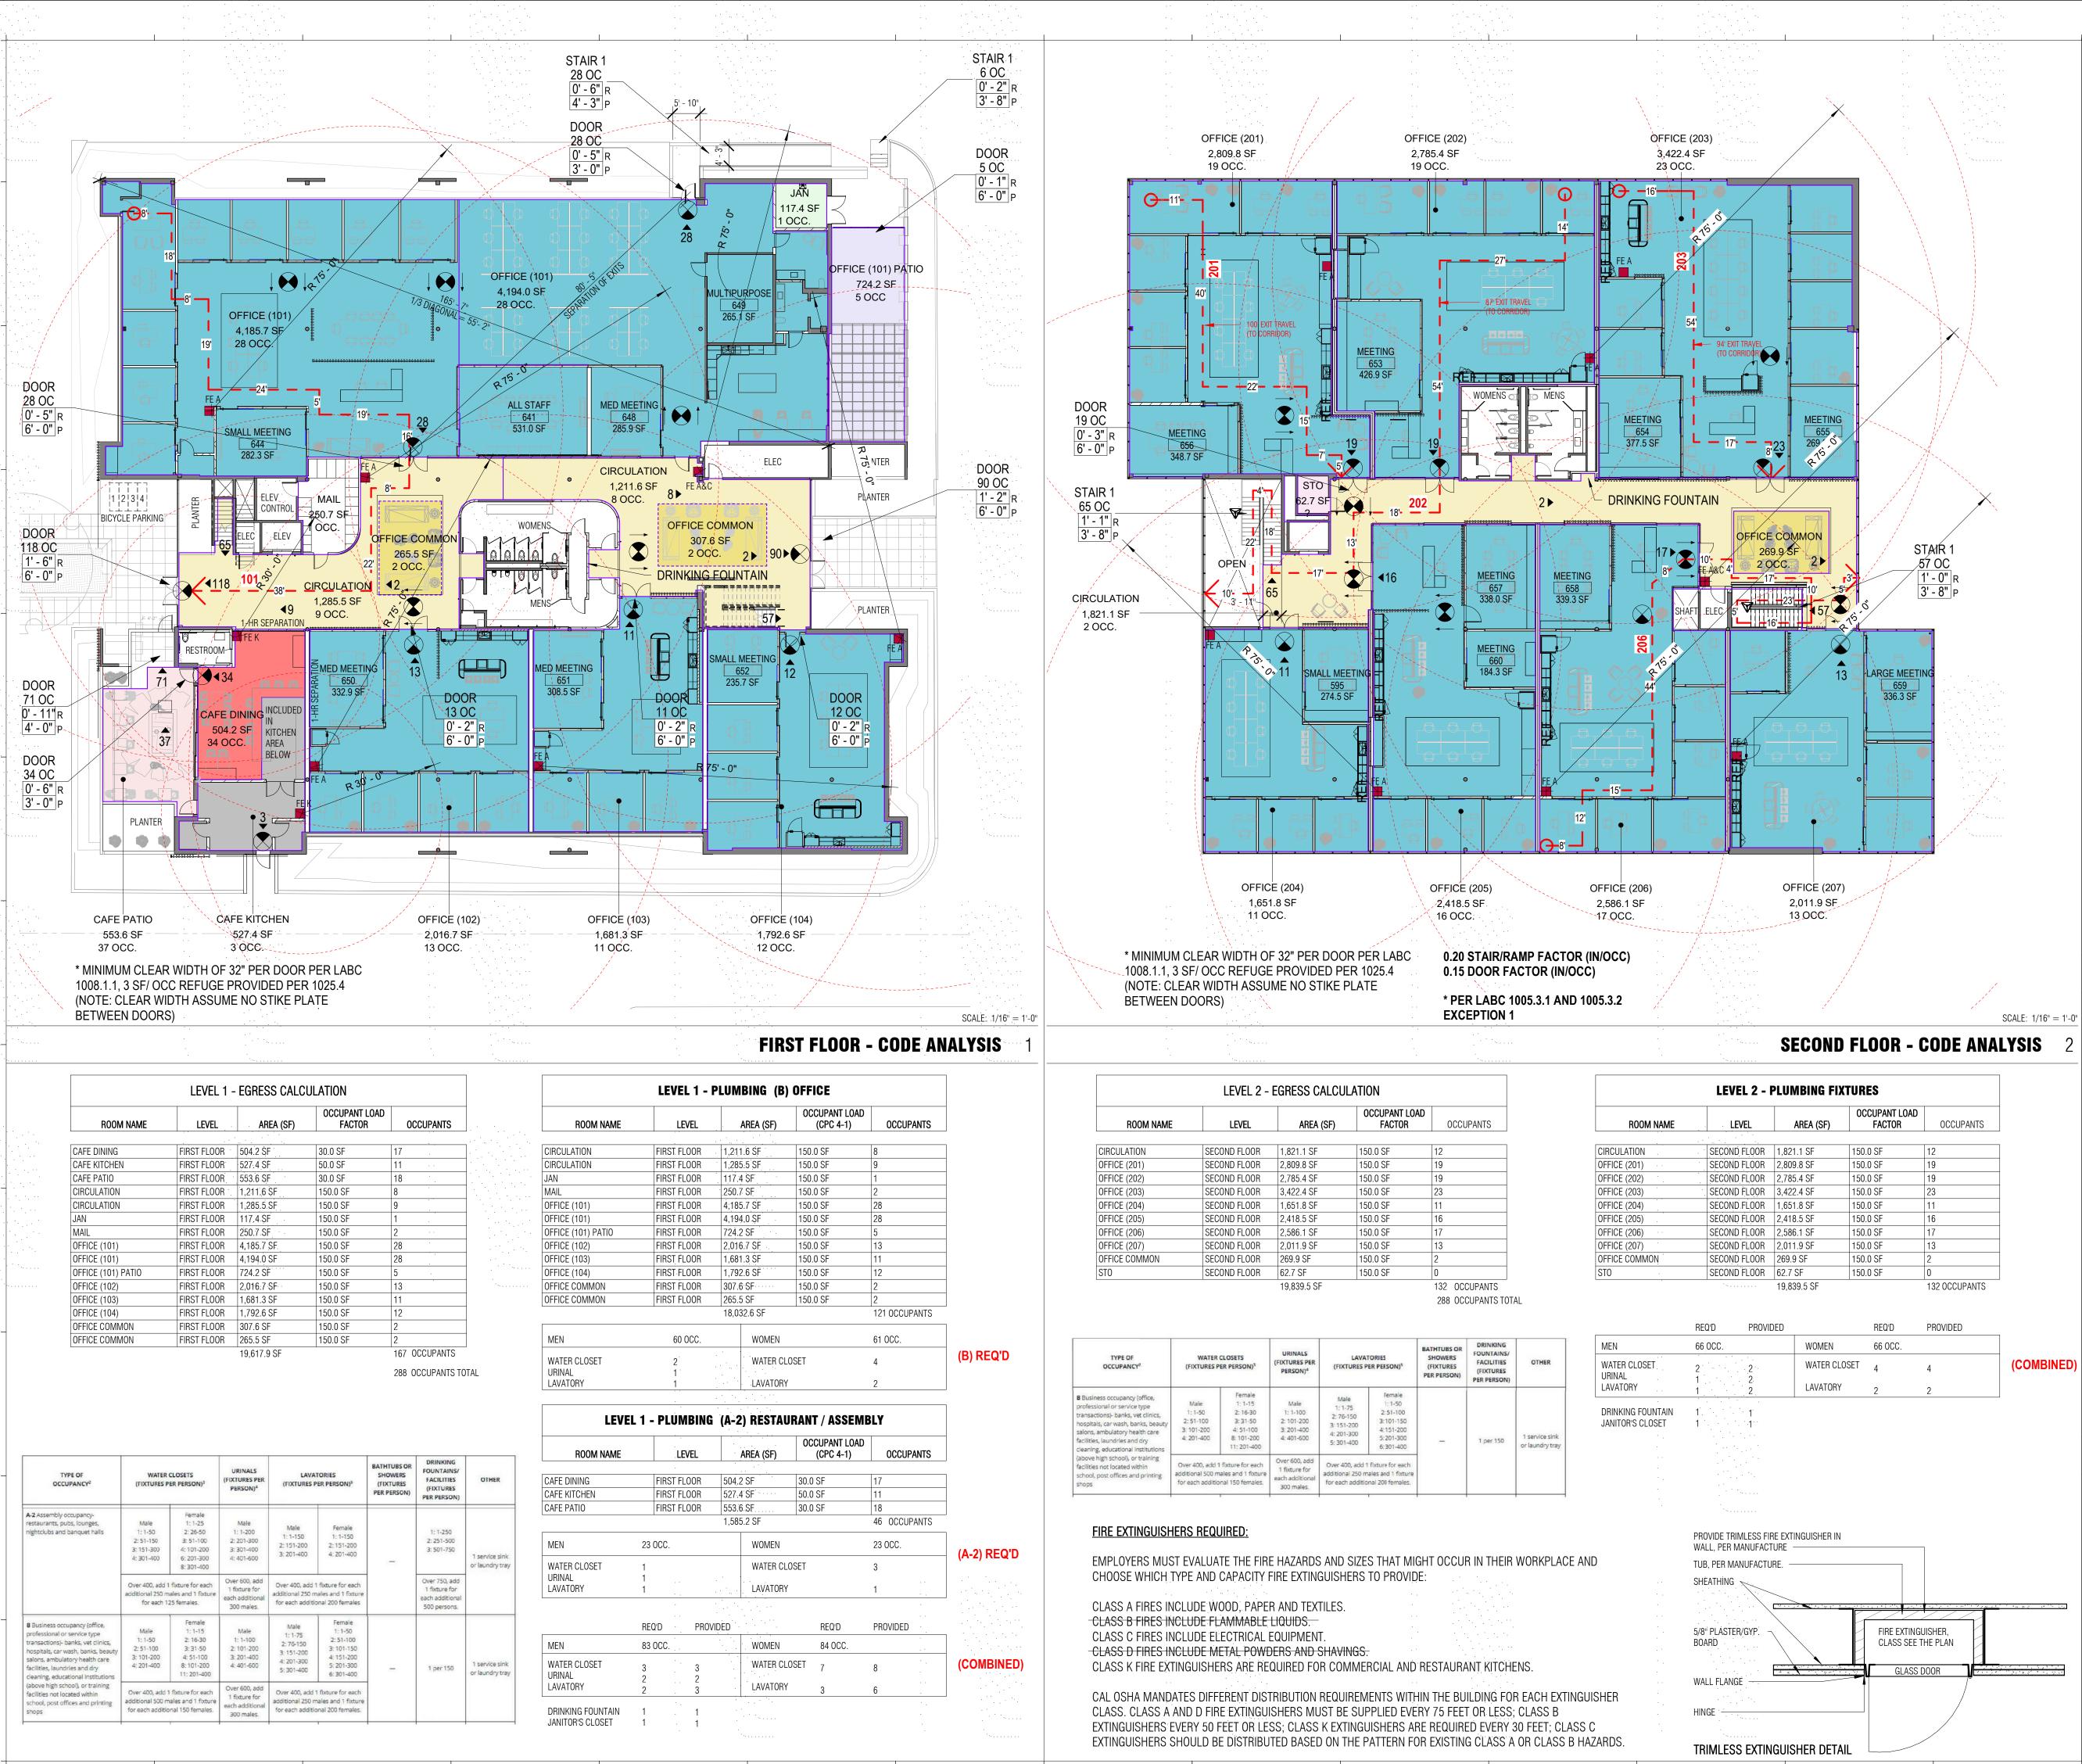

ROOM NAME	LEVEL	AREA (SF)	OCCUPANT LOAD FACTOR	OCCUPANTS
				· ·
CAFE DINING	FIRST FLOOR	504.2 SF	30.0 SF	17 .
CAFE KITCHEN	FIRST FLOOR	527.4 SF	50.0 SF	11 · ·
CAFE PATIO	FIRST FLOOR	553.6 SF	30.0 SF	18 .
CIRCULATION	FIRST FLOOR	1,211.6 SF	150.0 SF	8
CIRCULATION	FIRST FLOOR	1,285.5.SF	150.0 SF	9
AN	FIRST FLOOR	117.4 SF	150.0 SF	1 .
ЛАIL	FIRST FLOOR	250.7 SF	150.0 SF	2
OFFICE (101)	FIRST FLOOR	4,185.7 SF	150.0 SF	28
OFFICE (101)	FIRST FLOOR	4,194.0 SF	150.0 SF	28
OFFICE (101) PATIO	FIRST FLOOR	724.2 SF	150.0 SF	5.
OFFICE (102)	FIRST FLOOR	2,016:7 SF	150.0 SF	13
OFFICE (103)	FIRST FLOOR	1,681.3 SF	150.0 SF	11
OFFICE (104)	FIRST FLOOR	1,792.6 SF	150.0 SF	12
OFFICE COMMON	FIRST FLOOR	307.6 SF	150.0 SF	2
OFFICE COMMON	FIRST FLOOR	265.5 SF	150.0 SF	2
		19,617.9 SF		167 OCCUPANTS

288	OCCUPANTS TOTA

TYPE OF OCCUPANCY <sup>2</sup>		CLOSETS ER PERSON) <sup>3</sup>	URINALS (FIXTURES PER PERSON) <sup>4</sup>	the second statement of the second statements	IORIES ER PERSON) <sup>5</sup>	BATHTUBS OR SHOWERS (FIXTURES PER PERSON)	DRINKING FOUNTAINS/ FACILITIES (FIXTURES PER PERSON)	OTHER
A-2 Assembly occupancy- restaurants, pubs, lounges, nightclubs and banquet halls	Male 1:1-50 2:51-150 3:151-300 4:301-400	Female 1: 1-25 2: 26-50 3: 51-100 4: 101-200 6: 201-300 8: 301-400	Male 1: 1-200 2: 201-300 3: 301-400 4: 401-600	Male 1: 1-150 2: 151-200 3: 201-400	Female 1: 1-150 2: 151-200 4: 201-400	-	1: 1-250 2: 251-500 3: 501-750	1 service sink or laundry tray
	Over 400, add 1 fixture for each additional 250 males and 1 fixture for each 125 females.		Over 600, add 1 fixture for each additional 300 males.	Over 400, add 1 fixture for each additional 250 males and 1 fixture for each additional 200 females			Over 750, add 1 fixture for each additional 500 persons.	r nal
B Business occupancy (office, professional or service type transactions)- banks, vet clinics, hospitals, car wash, banks, beauty salons, ambulatory health care facilities, laundries and dry cleaning, educational institutions	Male 1:1-50 2:51-100 3:101-200 4:201-400	Female 1: 1-15 2: 16-30 3: 31-50 4: 51-100 8: 101-200 11: 201-400	Male 1: 1-100 2: 101-200 3: 201-400 4: 401-600	Male 1: 1-75 2: 76-150 3: 151-200 4: 201-300 5: 301-400	Female 1: 1-50 2: 51-100 3: 101-150 4: 151-200 5: 201-300 6: 301-400	_	1 per 150	1 service sink or laundry tray
(above high school), or training facilities not located within school, post offices and printing shops	Over 400, add 1 fixture for each additional 500 males and 1 fixture for each additional 150 females.		Over 600, add 1 fixture for each additional 300 males.	additional 250 m	fixture for each ales and 1 fixture nal 200 females.			

		•			•	•					R	S	T		F			C			
1																					
_	-	-	-	-	-	-	-	-	-	-			_	_	_	_	_	_	_	_	

	LEVEL 1 -	PLUM	BING (B)	OFFICE
ROOM NAME	LEVEL		Area (SF)	OCCUPANT LC (CPC 4-1)
		1.1.1.1		
CIRCULATION	FIRST FLOOR	1,211	.6 SF	150.0 SF
CIRCULATION	FIRST FLOOR	1,285	5.5 SF	150.0 SF
JAN	FIRST FLOOR	117.4	I SF	150.0 SF
MAIL	FIRST FLOOR	250.7	' SF	150.0 SF
OFFICE (101)	FIRST FLOOR	4,185	5.7 SF	150.0 SF
OFFICE (101)	FIRST FLOOR	4,194	I.O SF	150.0 SF
OFFICE (101) PATIO	FIRST FLOOR	724.2	2 SF	150.0 SF
OFFICE (102)	FIRST FLOOR	2,016	6.7 SF	150.0 SF
OFFICE (103)	FIRST FLOOR	1,681	.3 SF	150.0 SF
OFFICE (104)	FIRST-FLOOR	1,792	2.6 SF	150.0 SF
OFFICE COMMON	FIRST FLOOR	307.6	S-SF	150.0 SF
OFFICE COMMON	FIRST FLOOR	265.5	i SF	150.0 SF
		18,03	32.6 SF	i.
MEN	60.000		WOMEN	


MEN	60 OCC.		WOMEN
WATER CLOSET URINAL LAVATORY	2 1 1		WATER CLOSET LAVATORY
		· · · .	a the second

LEVE	L1-	PLI	JM	BIN	G	(A-2	) RESTAU	RANT	ſ / ASSEI
ROOM NAME			LEV	/EL			Area (SF)		CUPANT LOA (CPC 4-1)
CAFE DINING CAFE KITCHEN		FIRST FIRST				504.2 527.4		30.0 50.0	
CAFE PATIO		FIRST	r fl(	DOR			.SF .2 SF	30.0	SF
MEN	23	0CC.					WOMEN		
WATER CLOSET URINAL LAVATORY	1 1 1					 	WATER CLO	SET	
	REC	)'D		PRC	) VID	ED			REQ'D
MEN	83	OCC.					WOMEN		84 OCC.
WATER CLOSET URINAL	3 2		• . •	3 2			WATER CLO	SET	7
	2		• .	3		•	LAVATORY		3
DRINKING FOUNTAIN JANITOR'S CLOSET	1 1			1 1			· * •		

-9-

PANTS

	REQ'D	PROVIDED	
WOMEN	66 OCC.		
WATER CLOSET	4	4	(COMBINE
LAVATORY	2	2	

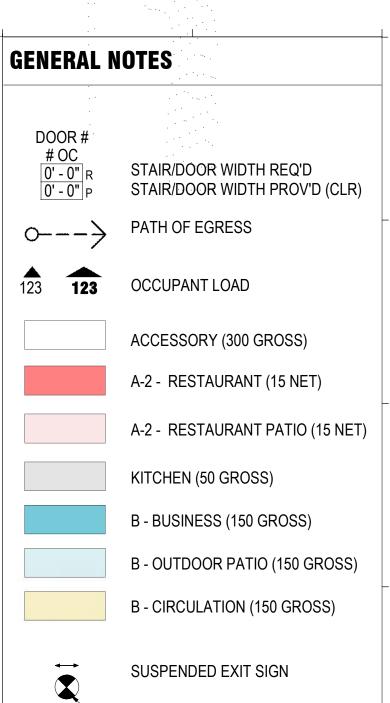

SIGN VISIBLE FROM THIS DIRECTION DIRECTION OF TRAVEL

# 303.1.2 SMALL ASSEMBLY SPACES

THE FOLLOWING ROOMS AND SPACES SHALL NOT BE CLASSIFIED AS ASSEMBLY OCCUPANCIES:

A ROOM OR SPACE USED FOR ASSEMBLY PURPOSES WITH AN OCCUPANT LOAD OF LESS THAN 50 PERSONS AND ACCESSORY TO ANOTHER OCCUPANCY SHALL BE CLASSIFIED AS A GROUP B OCCUPANCY OR AS PART OF THAT OCCUPANCY.

A ROOM OR SPACE USED FOR ASSEMBLY PURPOSES THAT IS LESS THAN 750 SQUARE FEET (70 M2) IN AREA AND ACCESSORY TO ANOTHER OCCUPANCY SHALL BE CLASSIFIED AS A GROUP B OCCUPANCY OR AS PART OF THAT OCCUPANCY

# TRAVEL DISTANCE (TABLE 1017.2)


## Exit access travel distance shall not exceed the values given in Table 1017.2. **TABLE 1017.2** EXIT ACCESS TRAVEL DISTANCE<sup>a</sup> WITHOUT SPRINKLER WITH SPRINKLER OCCUPANCY SYSTEM (feet) SYSTEM (feet) A, E, F-1, M, R, S-200<sup>e</sup> 250<sup>b</sup> 300<sup>c</sup> 200 Not Permitted 75<sup>d</sup> Not Permitted 100<sup>d</sup> Not Permitted 150<sup>d</sup> 175<sup>d</sup> Not Permitted 200<sup>c</sup> Not Permitted 200<sup>c</sup> 1-2, 1-2.1, 1-3 Not Permitted 2004 150 Not Permitted 200<sup>c</sup> For SI: 1 foot = 304.8 mm. EXIT MAX ALLOWABLE 000 DATH

ID	OCC	PAIH	DISTANCE
101	В	186'	300' - 0"
202	В	197'	300' - 0"
206	В	179'	300' - 0"

# CORRIDOR FIRE-RESISTANCE (TABLE 1020.2)

**TABLE 1020.2** 

	OCCUPANT	REQUIRED FIRE- RESISTANCE RATING (hour			
OCCUPANCY	LOAD SERVED BY CORRIDOR	Without sprinkler system	With sprinkler system		
H-1, H-2, H-3	All	Not Permitted	1 <sup>c</sup>		
H-4, H-5, L	Greater than 30	Not Permitted	1¢		
A, B, E, F, M, S, U	Greater than 30	1	0		
R-1, R-2, R-3, R-3.1 <sup>d</sup> , R-4 <sup>d</sup>	Greater than 10	Not Permitted	1		
I-2ª, <i>I-</i> 2.1	Greater than 6	1	1		
1-3, <i>R-2.1</i>	Greater than 6	Not Permitted	1 <sup>b, c</sup>		
I-4	All	1	0		
E	Greater than 10	1	0		

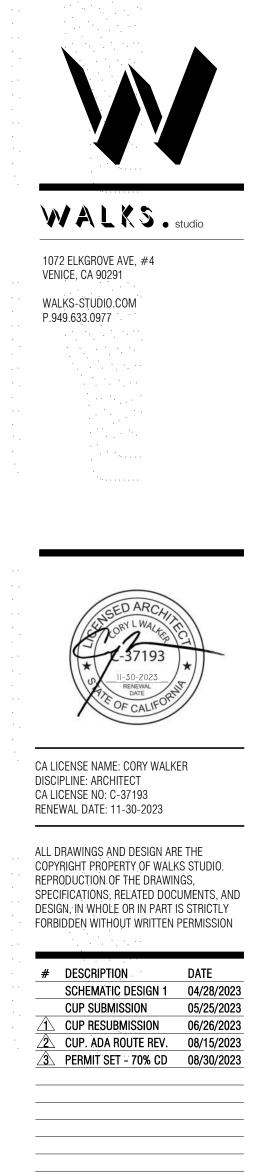



# EGRESS & PLUMBING FIXTURES

SCALE:	as noted
DATE:	08/30/2023
JOB NUMBER:	031
DRAWN BY:	
SHEET:	






PLANTER AT PROPOSED CAFE ENTRANCE (3)



FRONT ENTRANCE (4)

NORTH

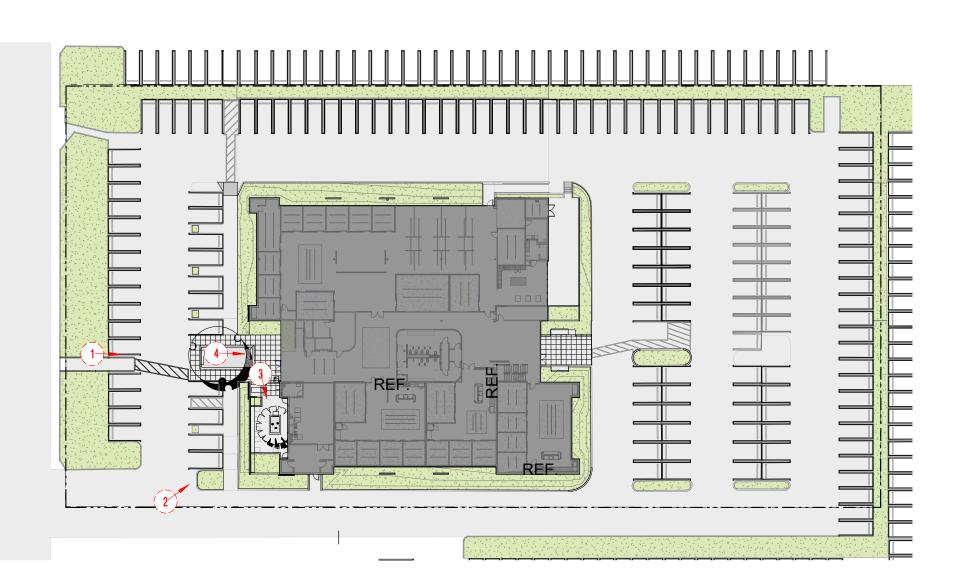





# FRONT CORNER PERSPECTIVE AT DRIVEWAY (2)

FRONT ENTRY / STREET VIEW (1)



WALKS-STUDIO.COM P.949.633.0977




CA LICENSE NAME: CORY WALKER DISCIPLINE: ARCHITECT CA LICENSE NO: C-37193 RENEWAL DATE: 11-30-2023

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#	DESCRIPTION	DATE
	SCHEMATIC DESIGN 1	04/28/2023
	CUP SUBMISSION	05/25/2023
$\overline{\mathbb{A}}$	CUP RESUBMISSION	06/26/2023
<u>2</u>	CUP. ADA ROUTE REV.	08/15/2023
3	PERMIT SET - 70% CD	08/30/2023




# EXISTING PHOTOS



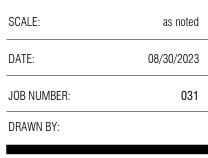


# EXISTING MONUMENT SIGNAGE (3)

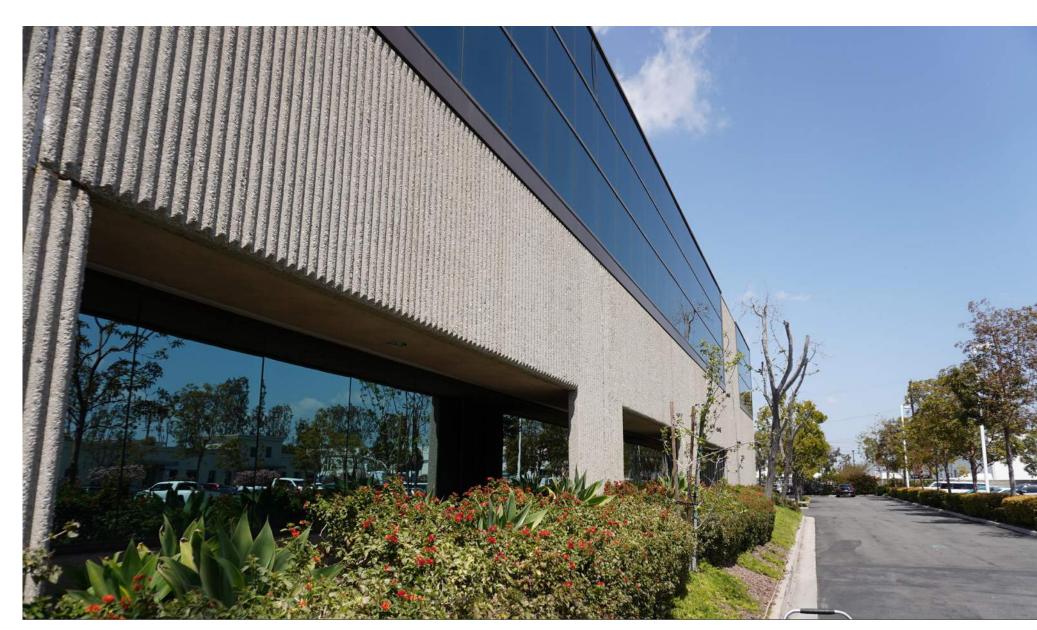

**EXISTING SOUTH ELEVATION (4)** 

NORTH

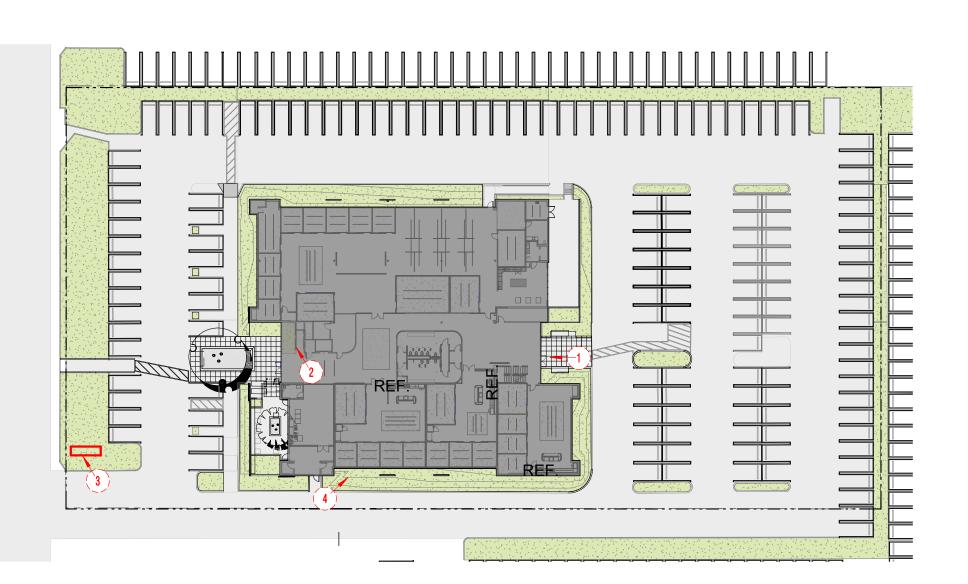





# NORTH / REAR ENTRY (1)




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<u>2</u>	CUP. ADA ROUTE REV.	08/15/2023
<u>3</u>	PERMIT SET - 70% CD	08/30/2023



# EXISTING PHOTOS





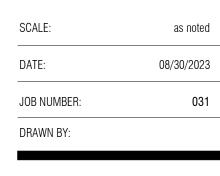

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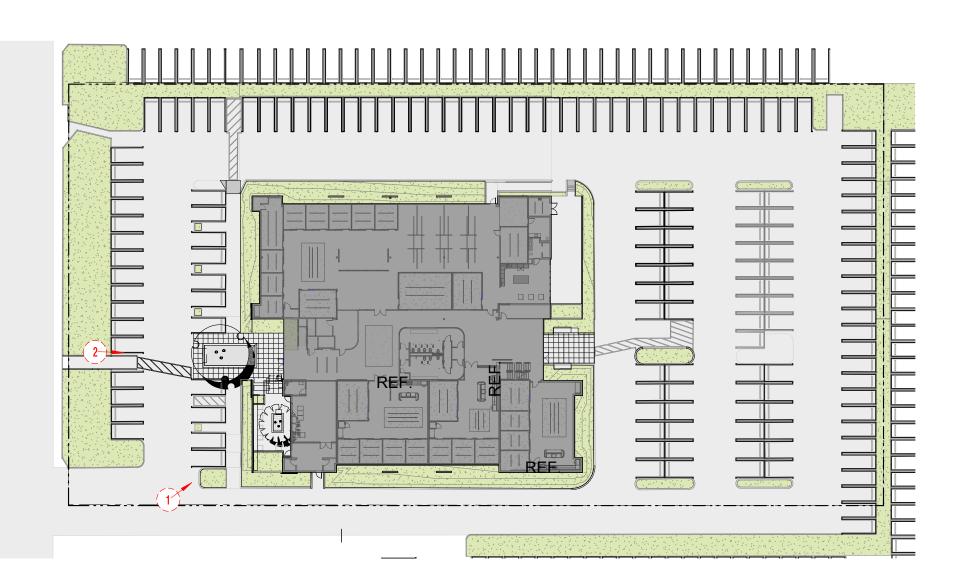


**EXISTING SOUTH ELEVATION (3)** 



**EXISTING SOUTH ELEVATION (4)** 

NORTH







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3	PERMIT SET - 70% CD	08/30/2023	




SCALE:	as noted
DATE:	08/30/2023
JOB NUMBER:	031
DRAWN BY:	

A1.16

SHEET:


EXTERIOR FACADE RENDERING (1)



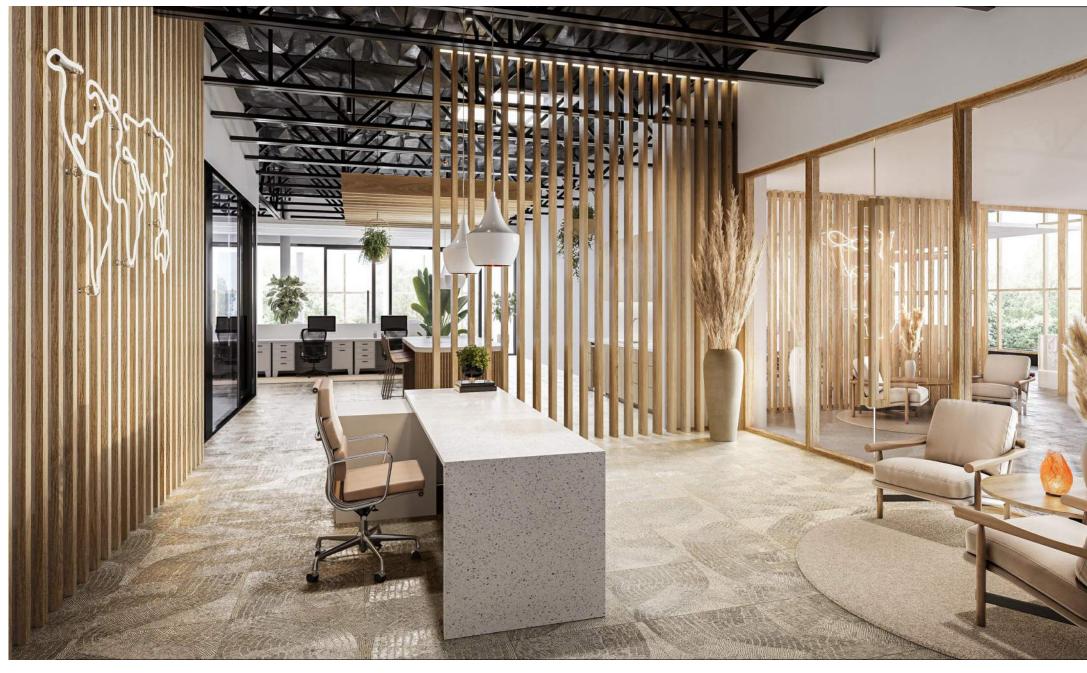

SUITE 204 (4)



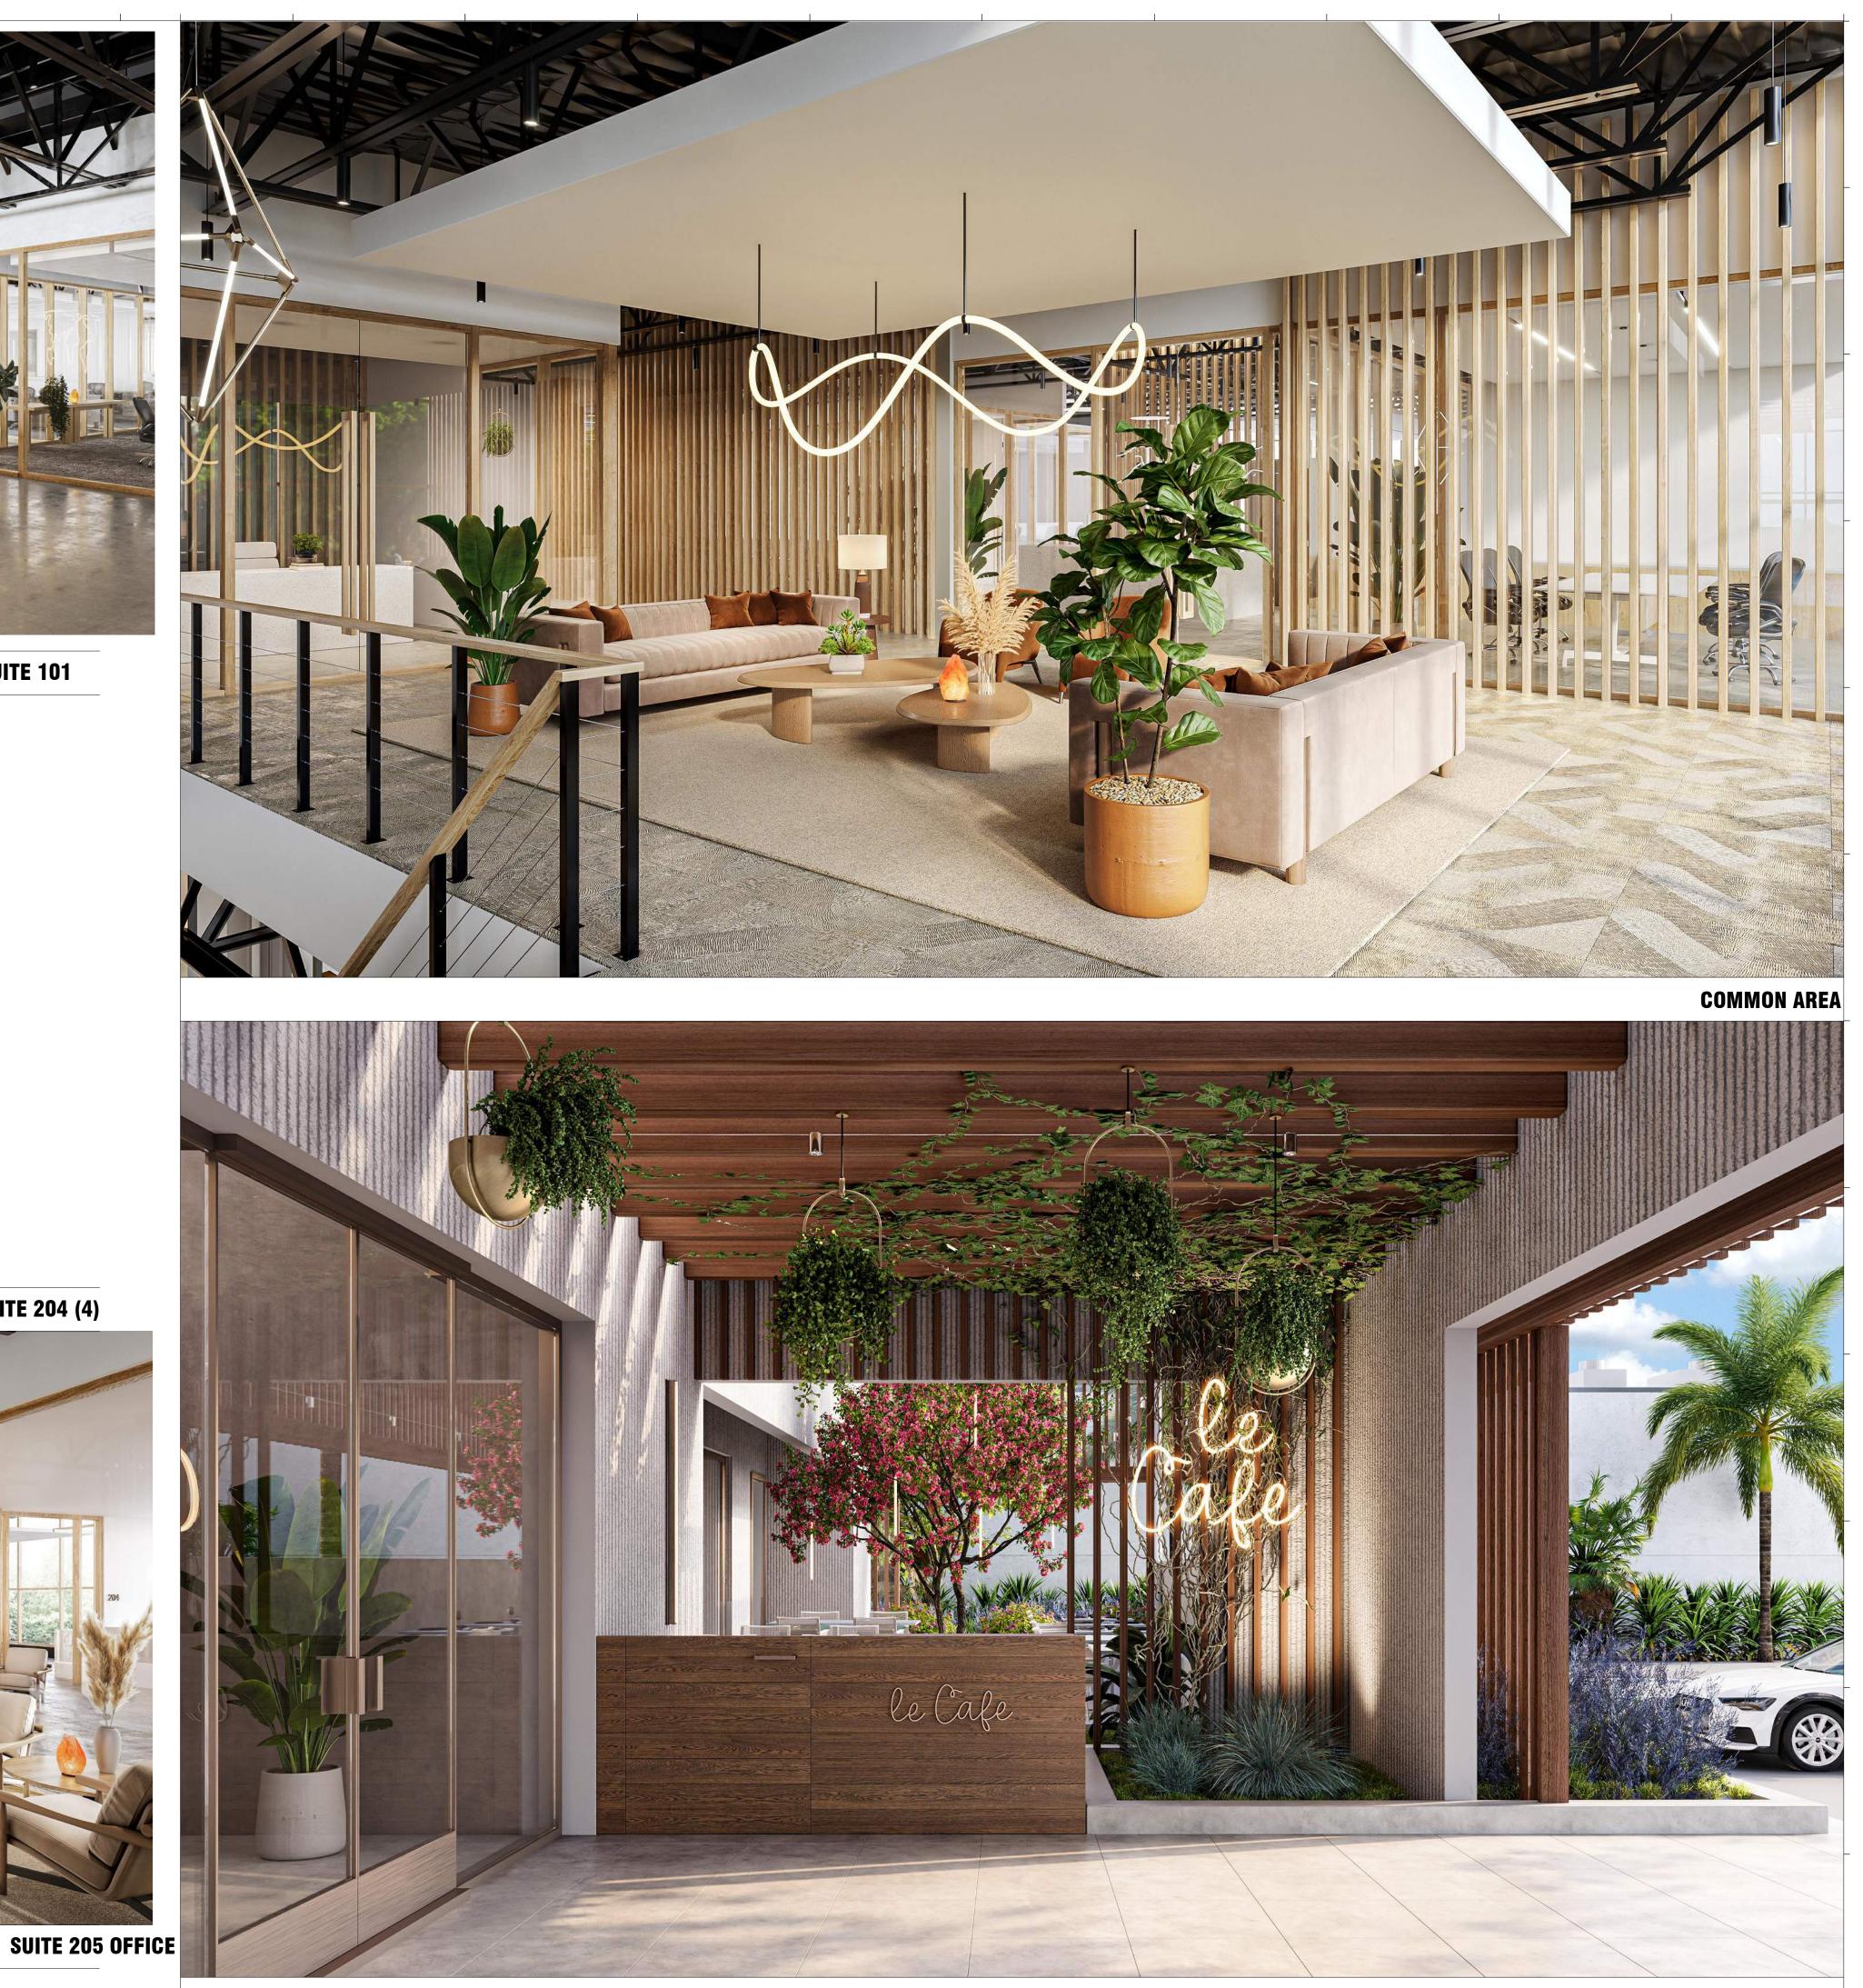

-13-

# WALKS. studio

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<u>^</u>	CUP. ADA ROUTE REV.	08/15/2023	
<u>3</u>	PERMIT SET - 70% CD	08/30/2023	



RENDERINGS

SCALE:	as noted
DATE:	08/30/2023
JOB NUMBER:	031
DRAWN BY:	



SHEET:

**EXTERIOR AMENITIES** 





1. NOTIFY ARCHITECT IMMEDIATELY OF ANY INCONSISTENCIES OR DISCREPANCIES WITH PLANS IN RELATION TO EXISTING FIELD CONDITIONS. 2. PROVIDE WATER RESISTANT GYP. BOARD AT ALL "WET AREA" LOCATIONS

3. ALL DOORS SHALL BE KEYLESS IN DIRECTION OF EGRESS 4. ALL OUTSIDE CORNERS AT DRYWALL PARTIIONS AND FURRING TO HAVE

METAL CORNER BEADS SPACKLE AND SMOOTH 5. ALL GYPSUM BOARD TO BE TYPE "X" FIRE RESISTANT THROUGHOUT.

6. ALL PLYWOOD TO BE FIRE RATED THROUGHOUT

7. DO NOT SCALE DRAWINGS. IF DISCREPANCIES ARISE, BRING TO THE ATTENTION OF THE ARCHITECT


8. ALL FINISH MATERIALS SHALL BE SUBMITTED TO OWNER / ARCHITECT FOR REVIEW PRIOR TO INSTALLATION

9. ALL EXISTING EXTERIOR WALLS SHALL RECIEVE R-16 BATT INSULATION IN STUD CAVITY.

10. AN APPROVED SEISMIC GAS SHUT OFF VALVE OR EXCESS FLOW SHUT OFF VALVE WILL BE INSTALLED ON THE FUEL GAS LINE ON THE DOWN-STREAM SIDE OF THE UTILITY METER AND BE RIGIDLY CONNECTED TO THE EXTERIOR OF THE BUILDING OR STRUCTURE CONTAINING THE FUEL GAS PIPING. (PER ORDINANCE 170,158 AND 180,670)

# **SHEET NOTES**

02 EXISTING PIPE COLUMNS TO REMAIN, TYP.

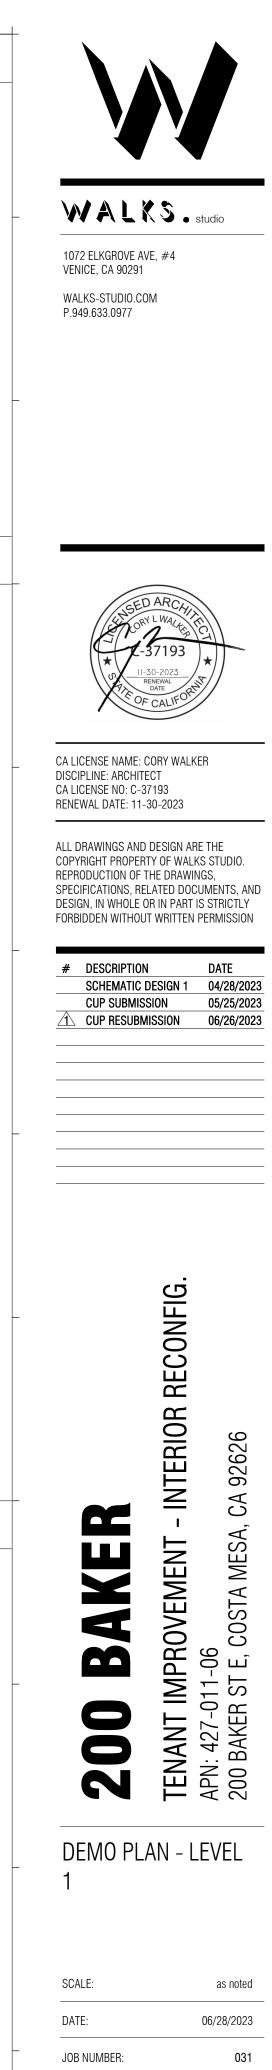

# LEGEND

	AREA NOT IN CONTRACT
	(E) WALL TO REMAIN, VIF
	(N) WOOD STUD WALL PER WALL SCHEDULE
D1	DOOR TAG
A1	WALL TYPE - SEE 8/A104 FOR FURTHER INFORMATION
####	SHEET NOTE
A-1 B-1	WALL FINISH & BASE TAG
W01	WINDOW TAG - SEE WINDOW SCHEDULE
	AREA TO BE DEMOLISHED
	1-HOUR RATED WALL ASSEMBLY



DRAWN BY:

# $(\mathsf{D}\mathsf{D})$ A0.41 C B Α $\mathbf{X}$ **DEMOLITION PLAN - LEVEL 1**


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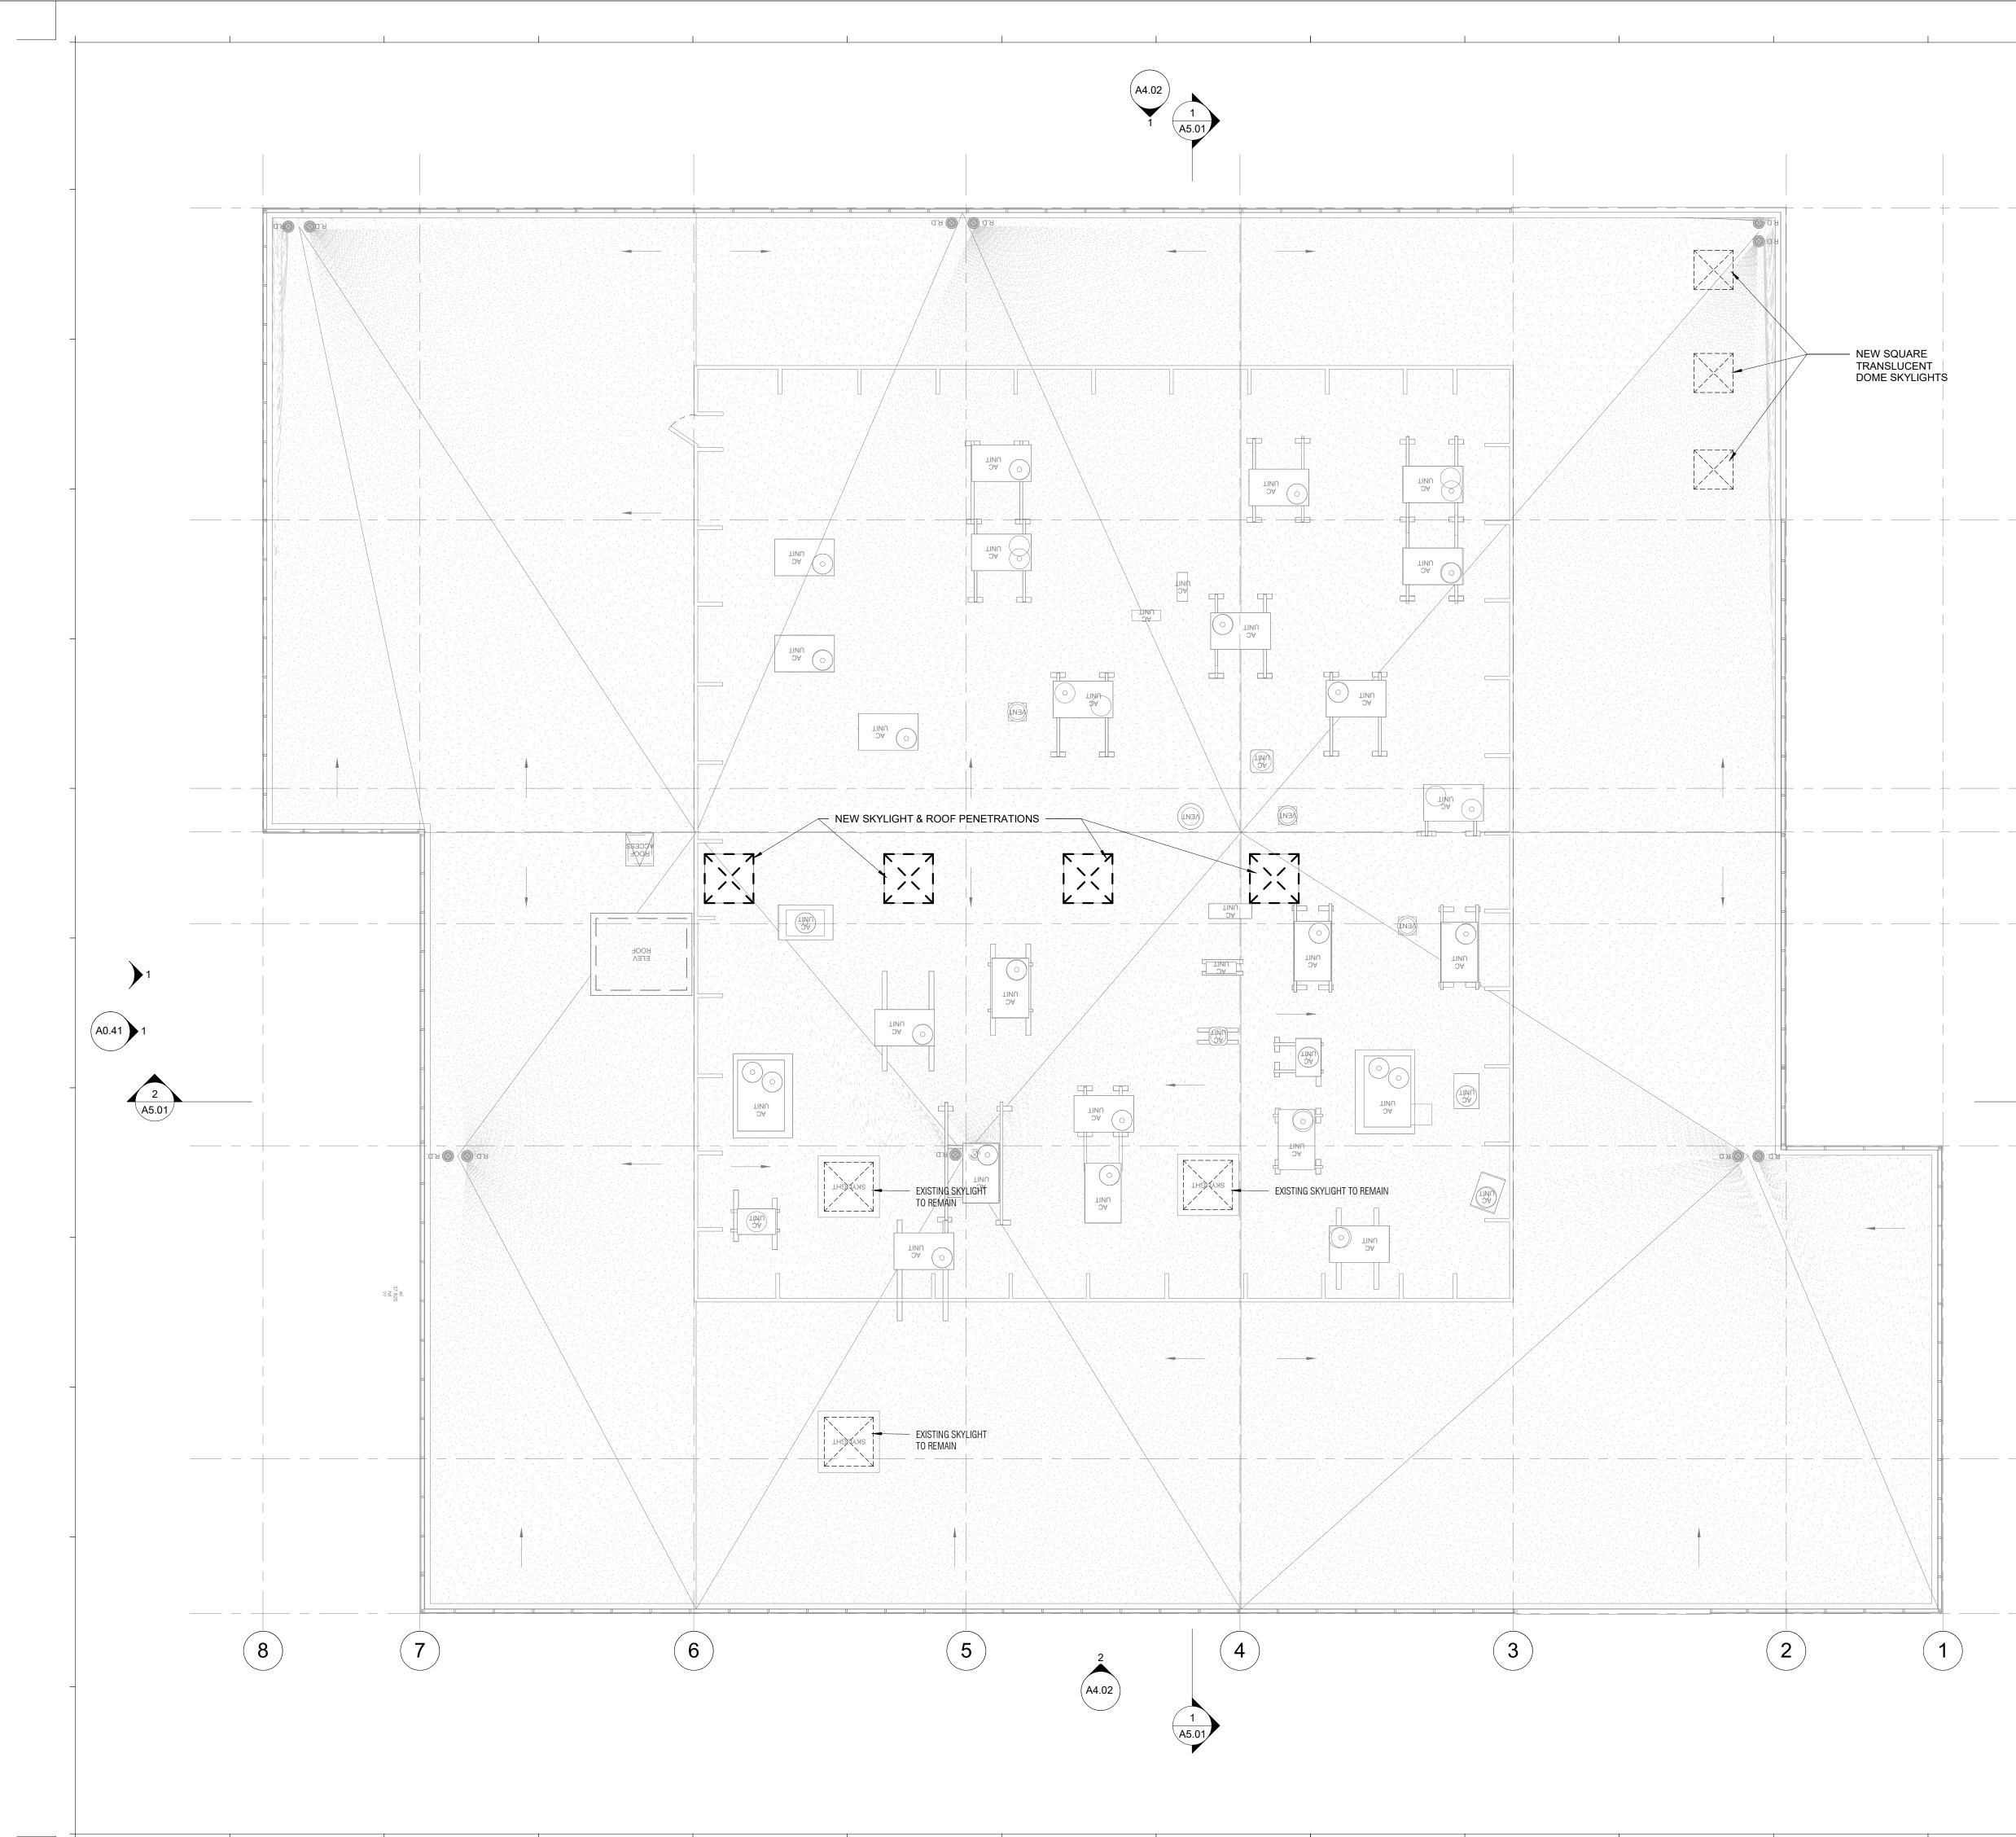
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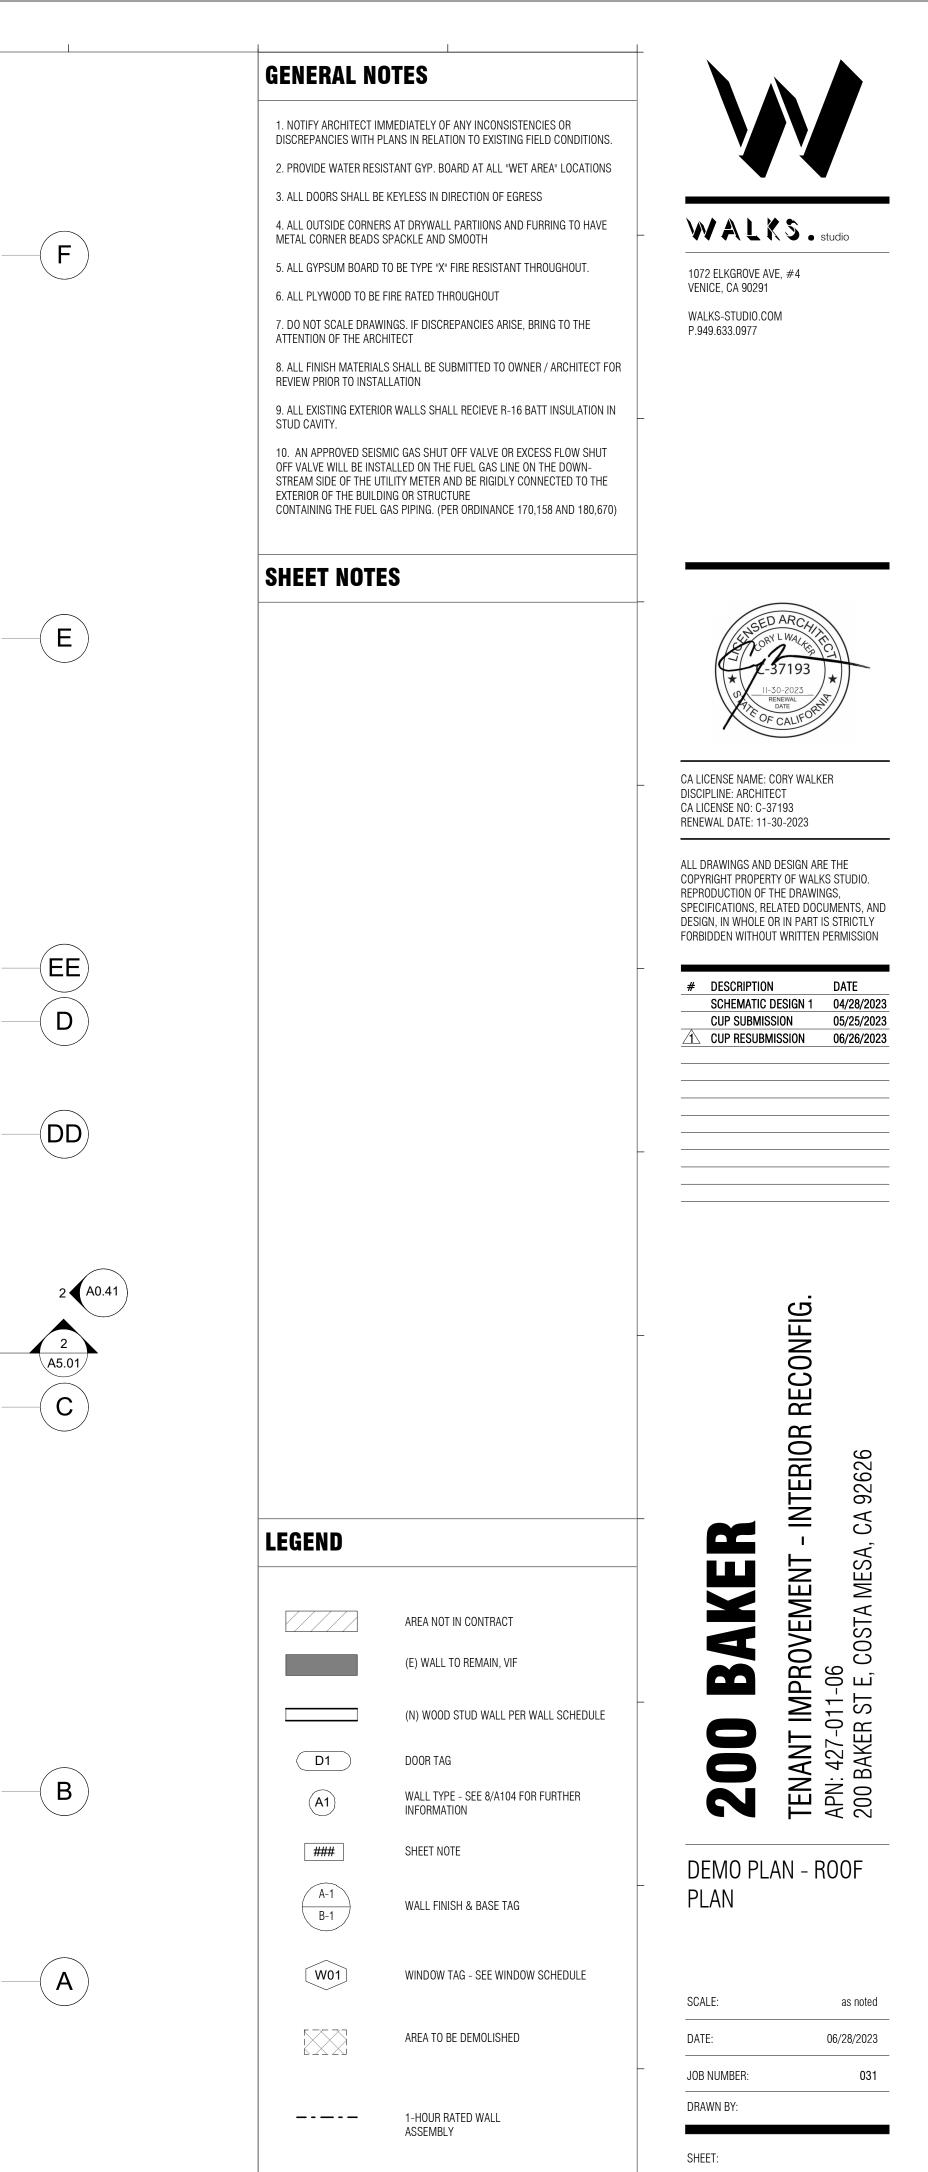
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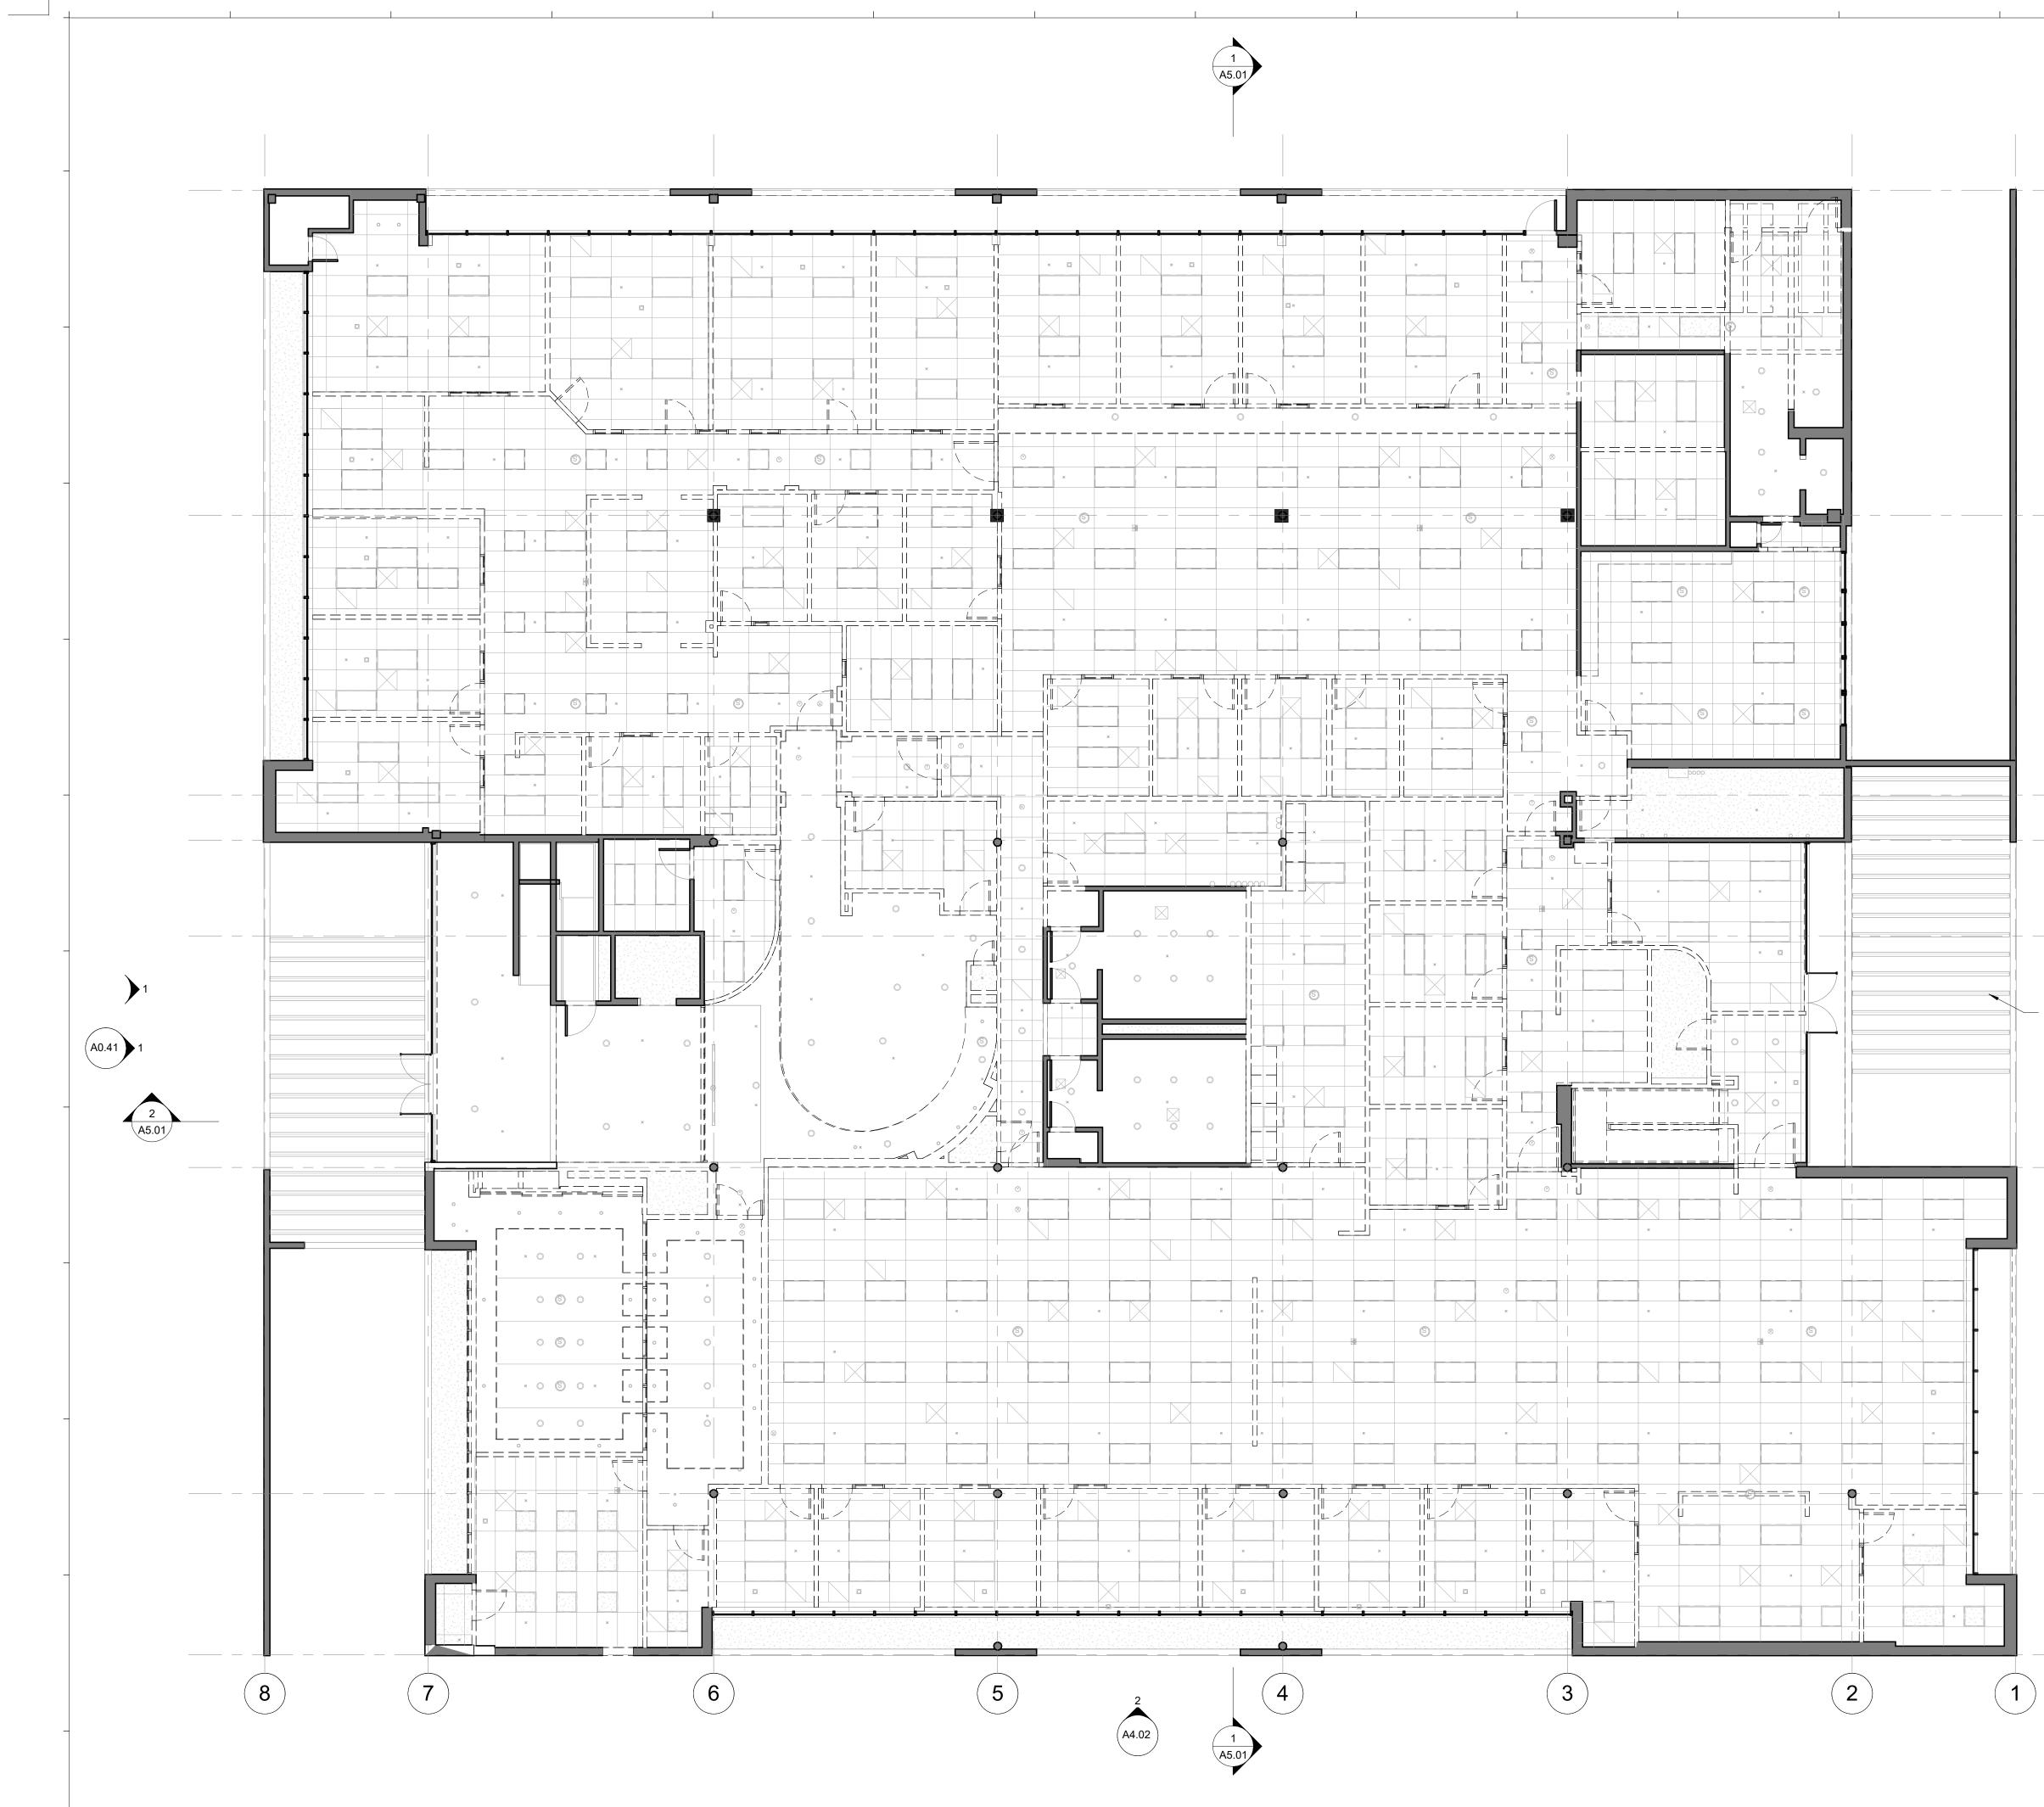
SCALE: 1/8" = 1'-0"









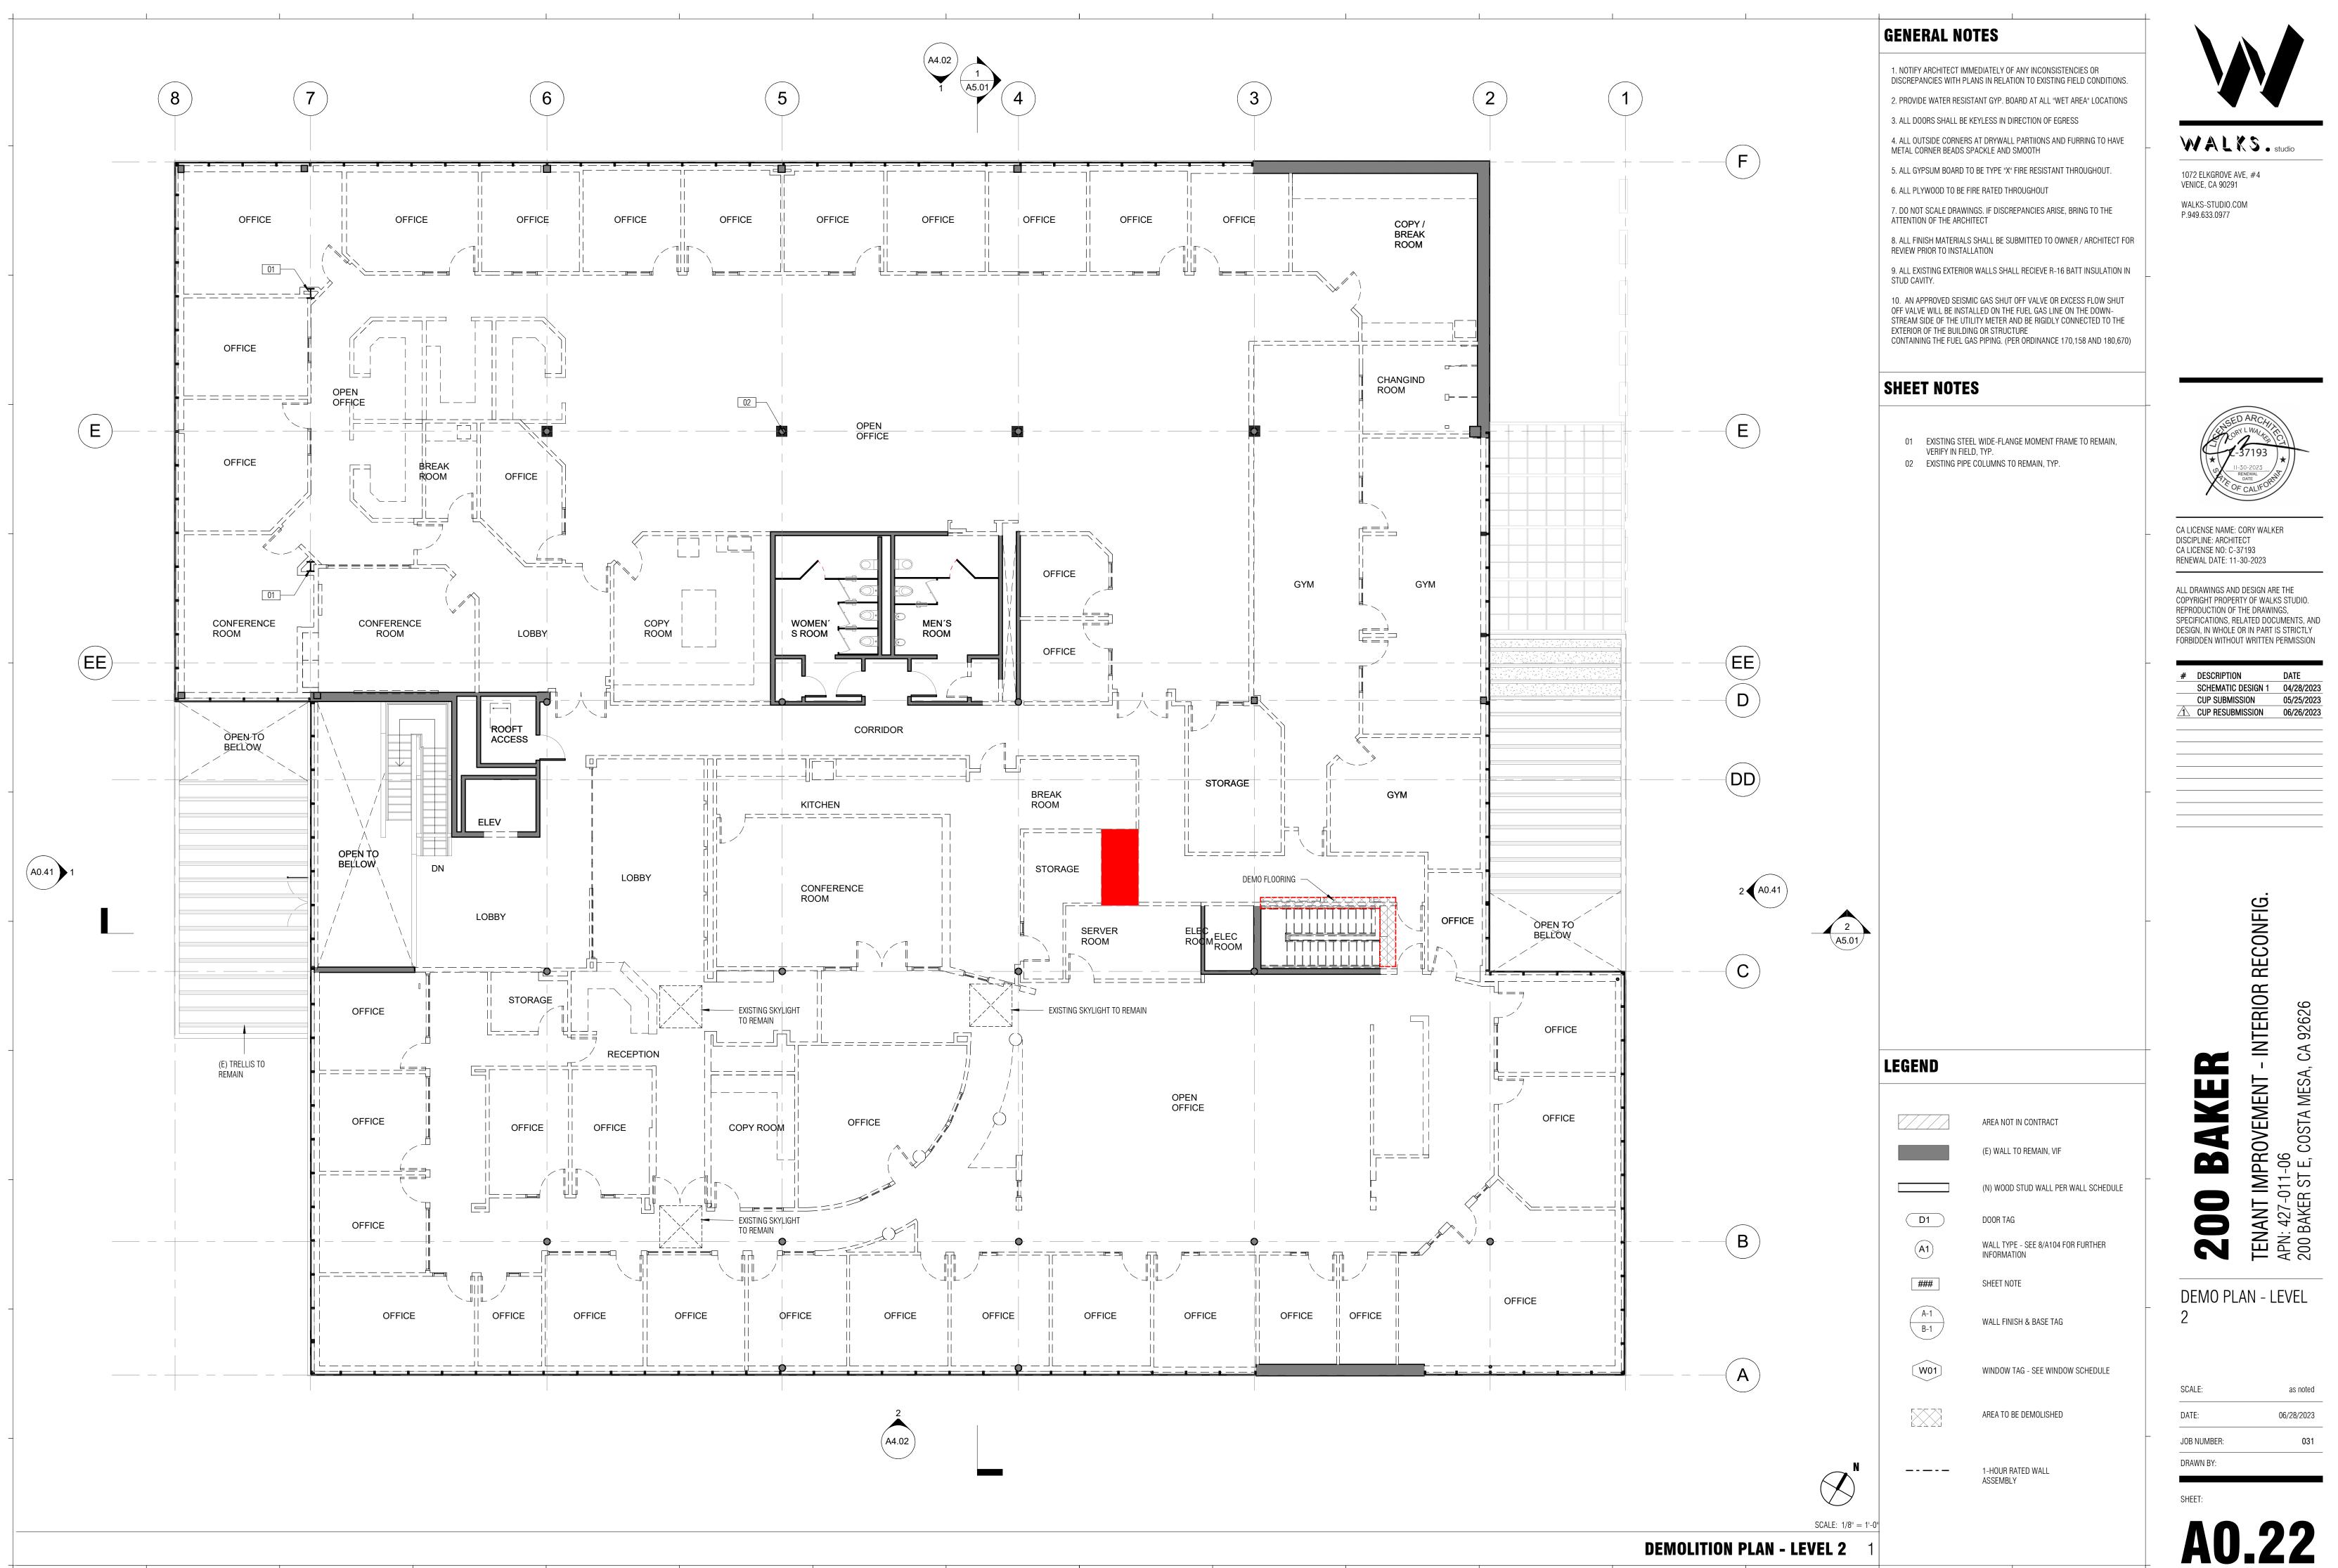

1. NOTIFY ARCHITECT IMMEDIATELY OF ANY INCONSISTENCIES OR DISCREPANCIES WITH PLANS IN RELATION TO EXISTING FIELD CONDITIONS. 2. PROVIDE WATER RESISTANT GYP. BOARD AT ALL "WET AREA" LOCATIONS

3. ALL DOORS SHALL BE KEYLESS IN DIRECTION OF EGRESS

4. ALL OUTSIDE CORNERS AT DRYWALL PARTIIONS AND FURRING TO HAVE METAL CORNER BEADS SPACKLE AND SMOOTH 5. ALL GYPSUM BOARD TO BE TYPE "X" FIRE RESISTANT THROUGHOUT.

6. ALL PLYWOOD TO BE FIRE RATED THROUGHOUT


7. DO NOT SCALE DRAWINGS. IF DISCREPANCIES ARISE, BRING TO THE ATTENTION OF THE ARCHITECT

8. ALL FINISH MATERIALS SHALL BE SUBMITTED TO OWNER / ARCHITECT FOR REVIEW PRIOR TO INSTALLATION

9. ALL EXISTING EXTERIOR WALLS SHALL RECIEVE R-16 BATT INSULATION IN STUD CAVITY.

10. AN APPROVED SEISMIC GAS SHUT OFF VALVE OR EXCESS FLOW SHUT OFF VALVE WILL BE INSTALLED ON THE FUEL GAS LINE ON THE DOWN-STREAM SIDE OF THE UTILITY METER AND BE RIGIDLY CONNECTED TO THE EXTERIOR OF THE BUILDING OR STRUCTURE CONTAINING THE FUEL GAS PIPING. (PER ORDINANCE 170,158 AND 180,670)

# SHEET NOTES

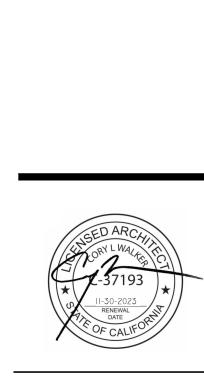

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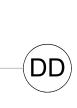
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$\triangle$	CUP RESUBMISSION	06/26/2023




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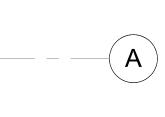
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(E)

# DEMO TRELLIS MEMBERS, TYP. PREP FOR NEW OCCUPIABLE DECK





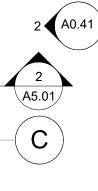


	AREA NOT IN CONTRACT
	(E) WALL TO REMAIN, VIF
	(N) WOOD STUD WALL PER WALL SCHEDULE
D1	DOOR TAG
(A1)	WALL TYPE - SEE 8/A104 FOR FURTHER INFORMATION
####	SHEET NOTE
A-1 B-1	WALL FINISH & BASE TAG
W01	WINDOW TAG - SEE WINDOW SCHEDULE
	AREA TO BE DEMOLISHED
	1-HOUR RATED WALL ASSEMBLY


LEGEND




# DEMO REFLECTED CEILING PLAN -LEVEL 1

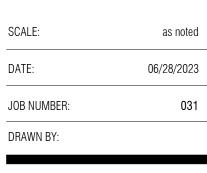



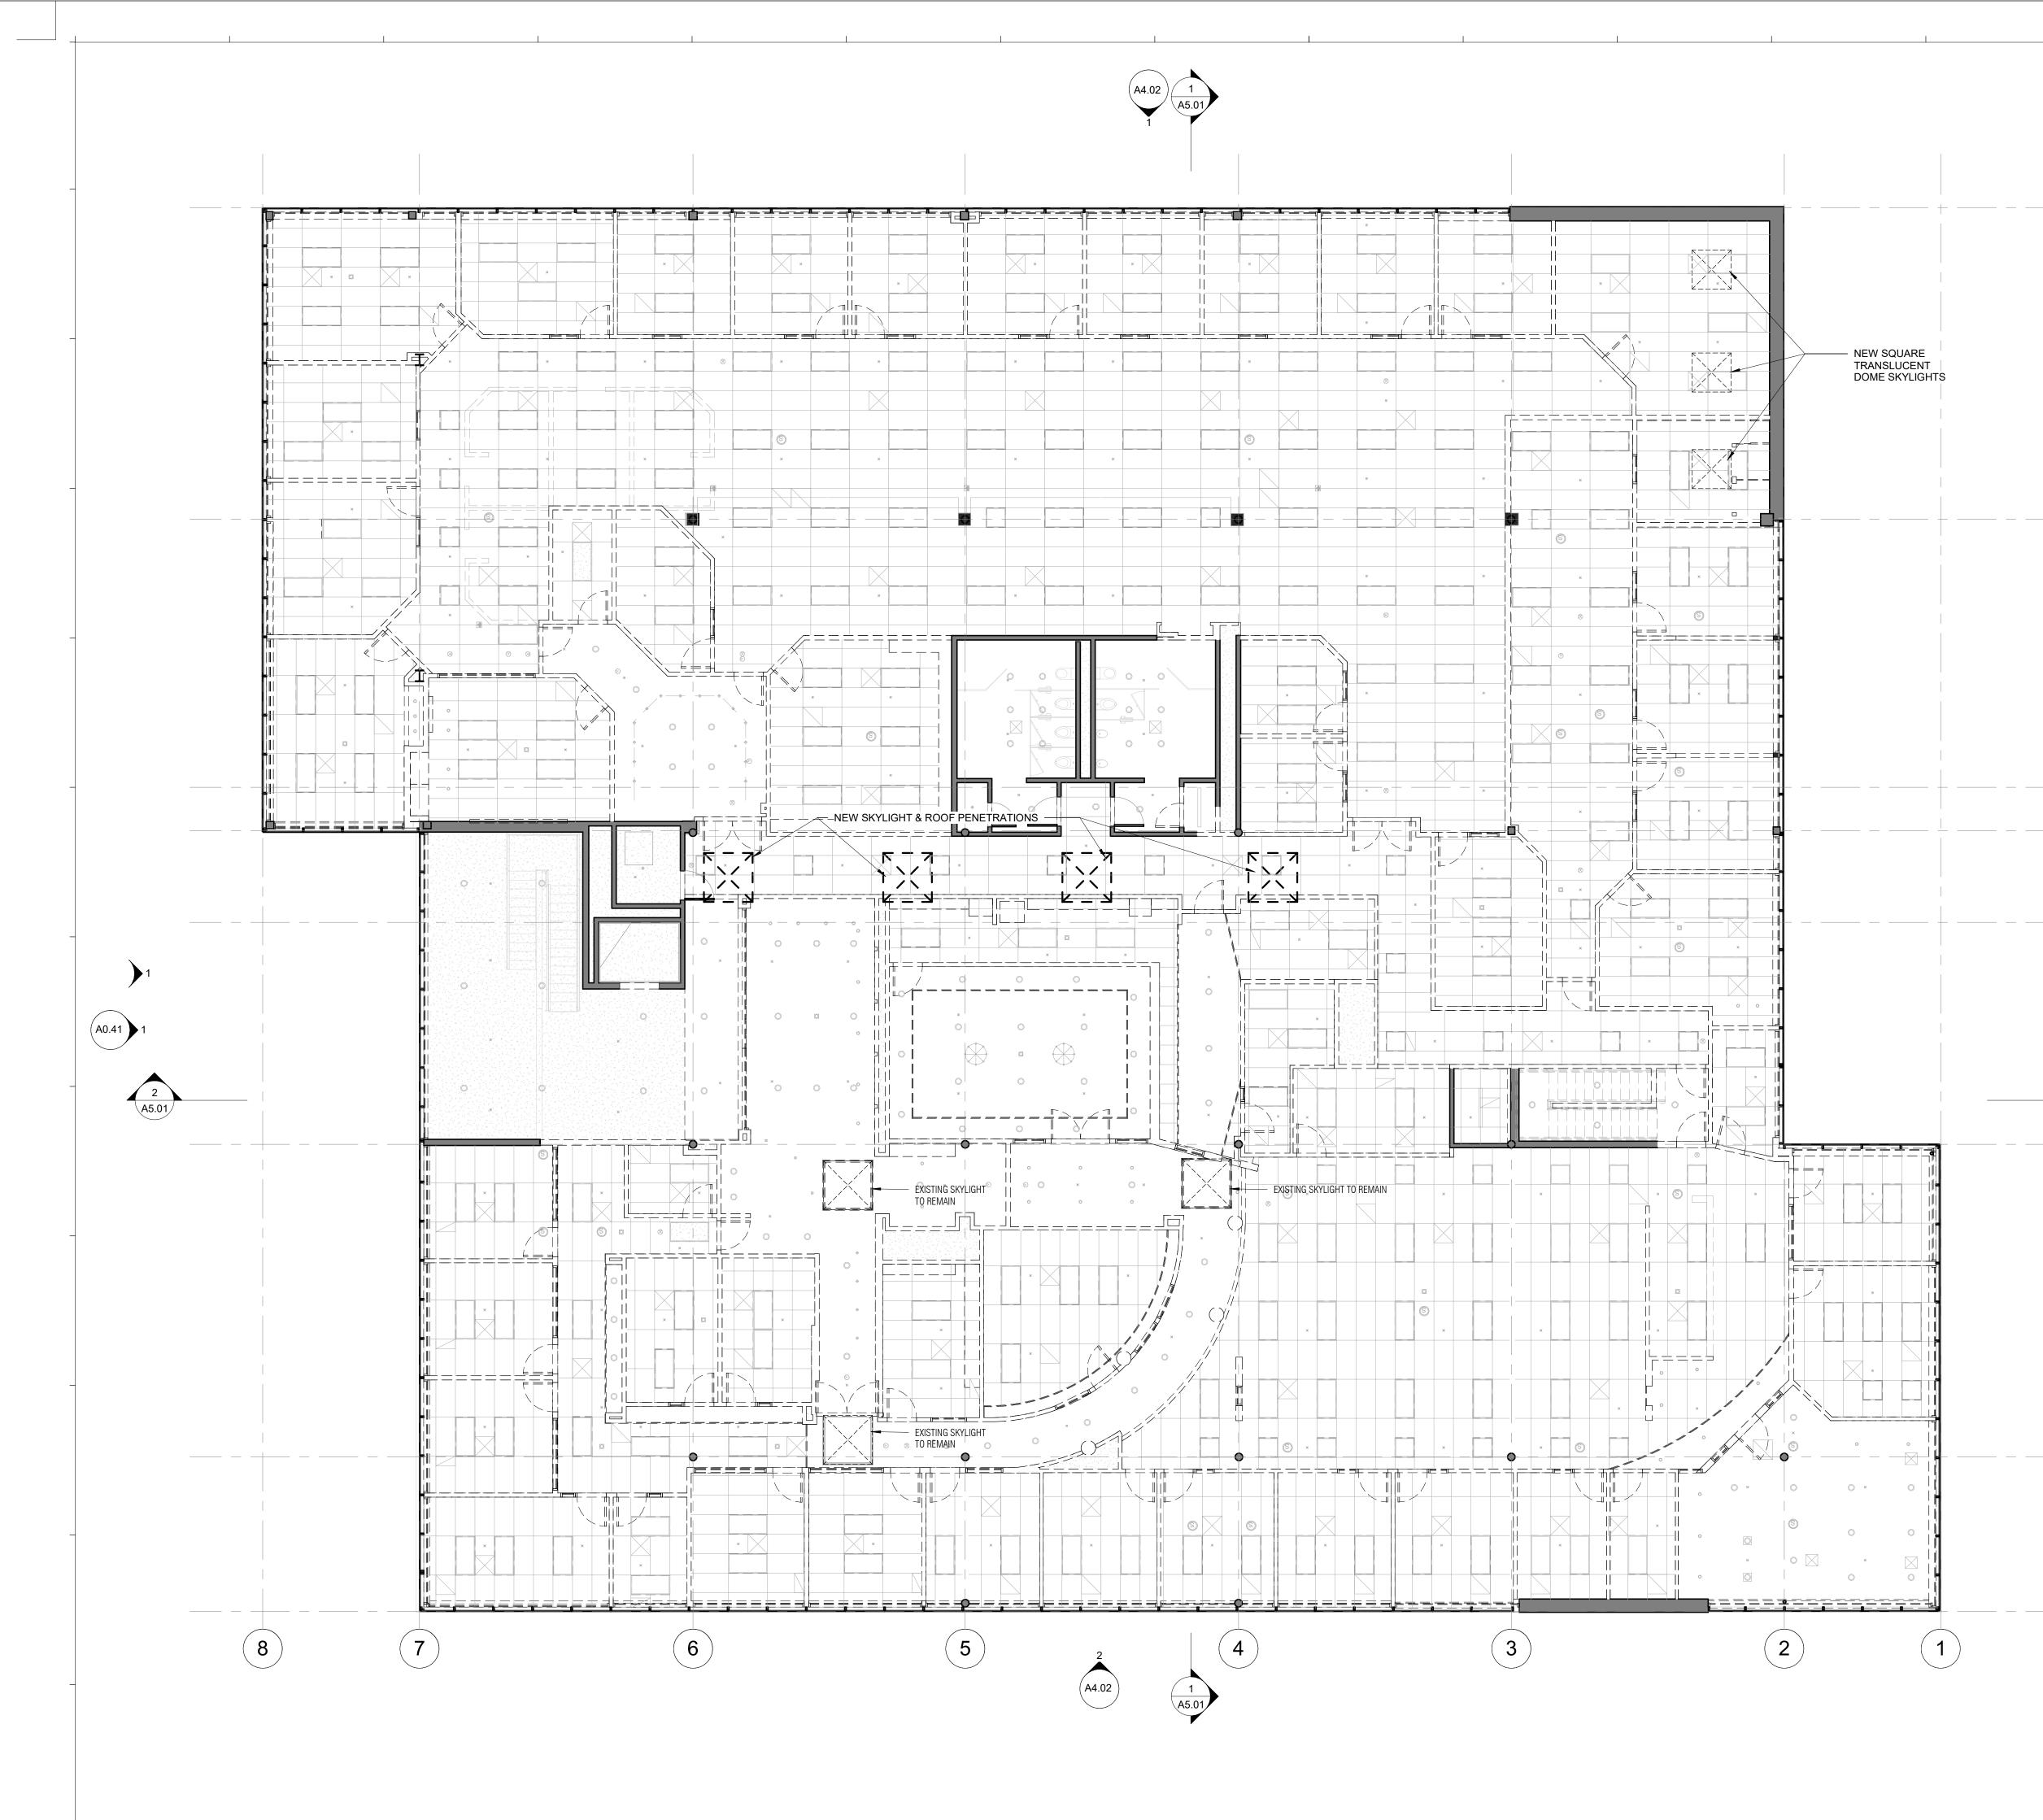

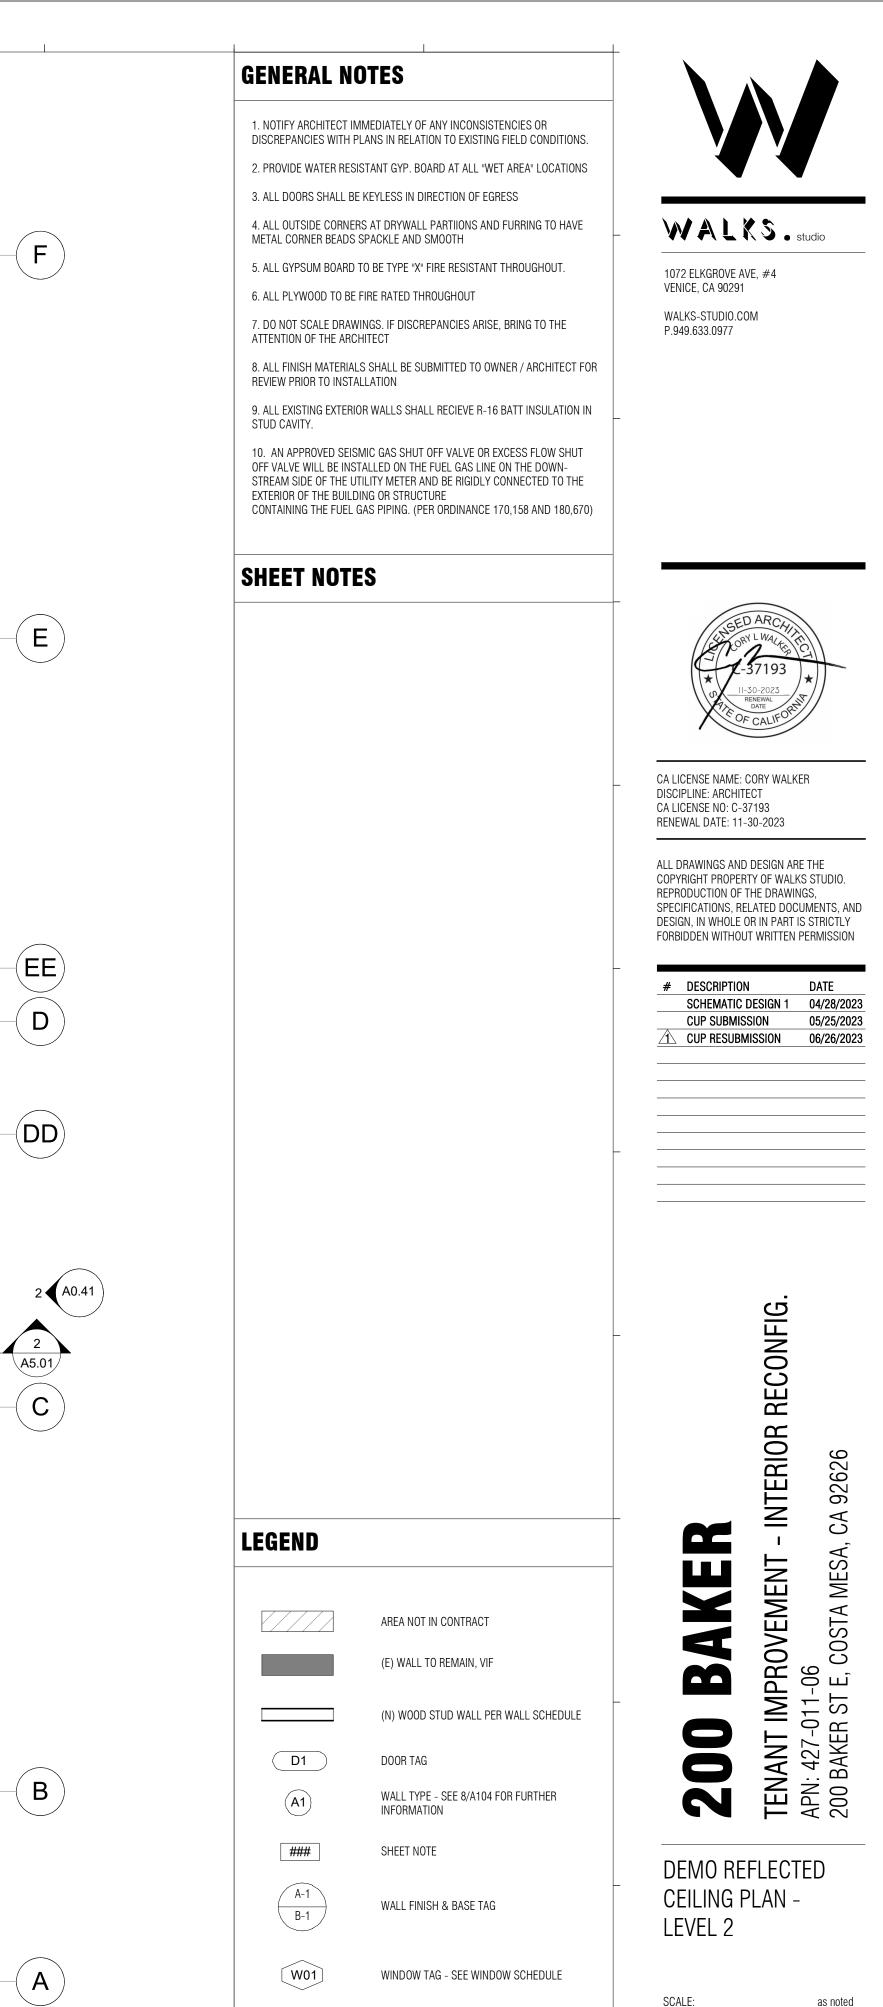

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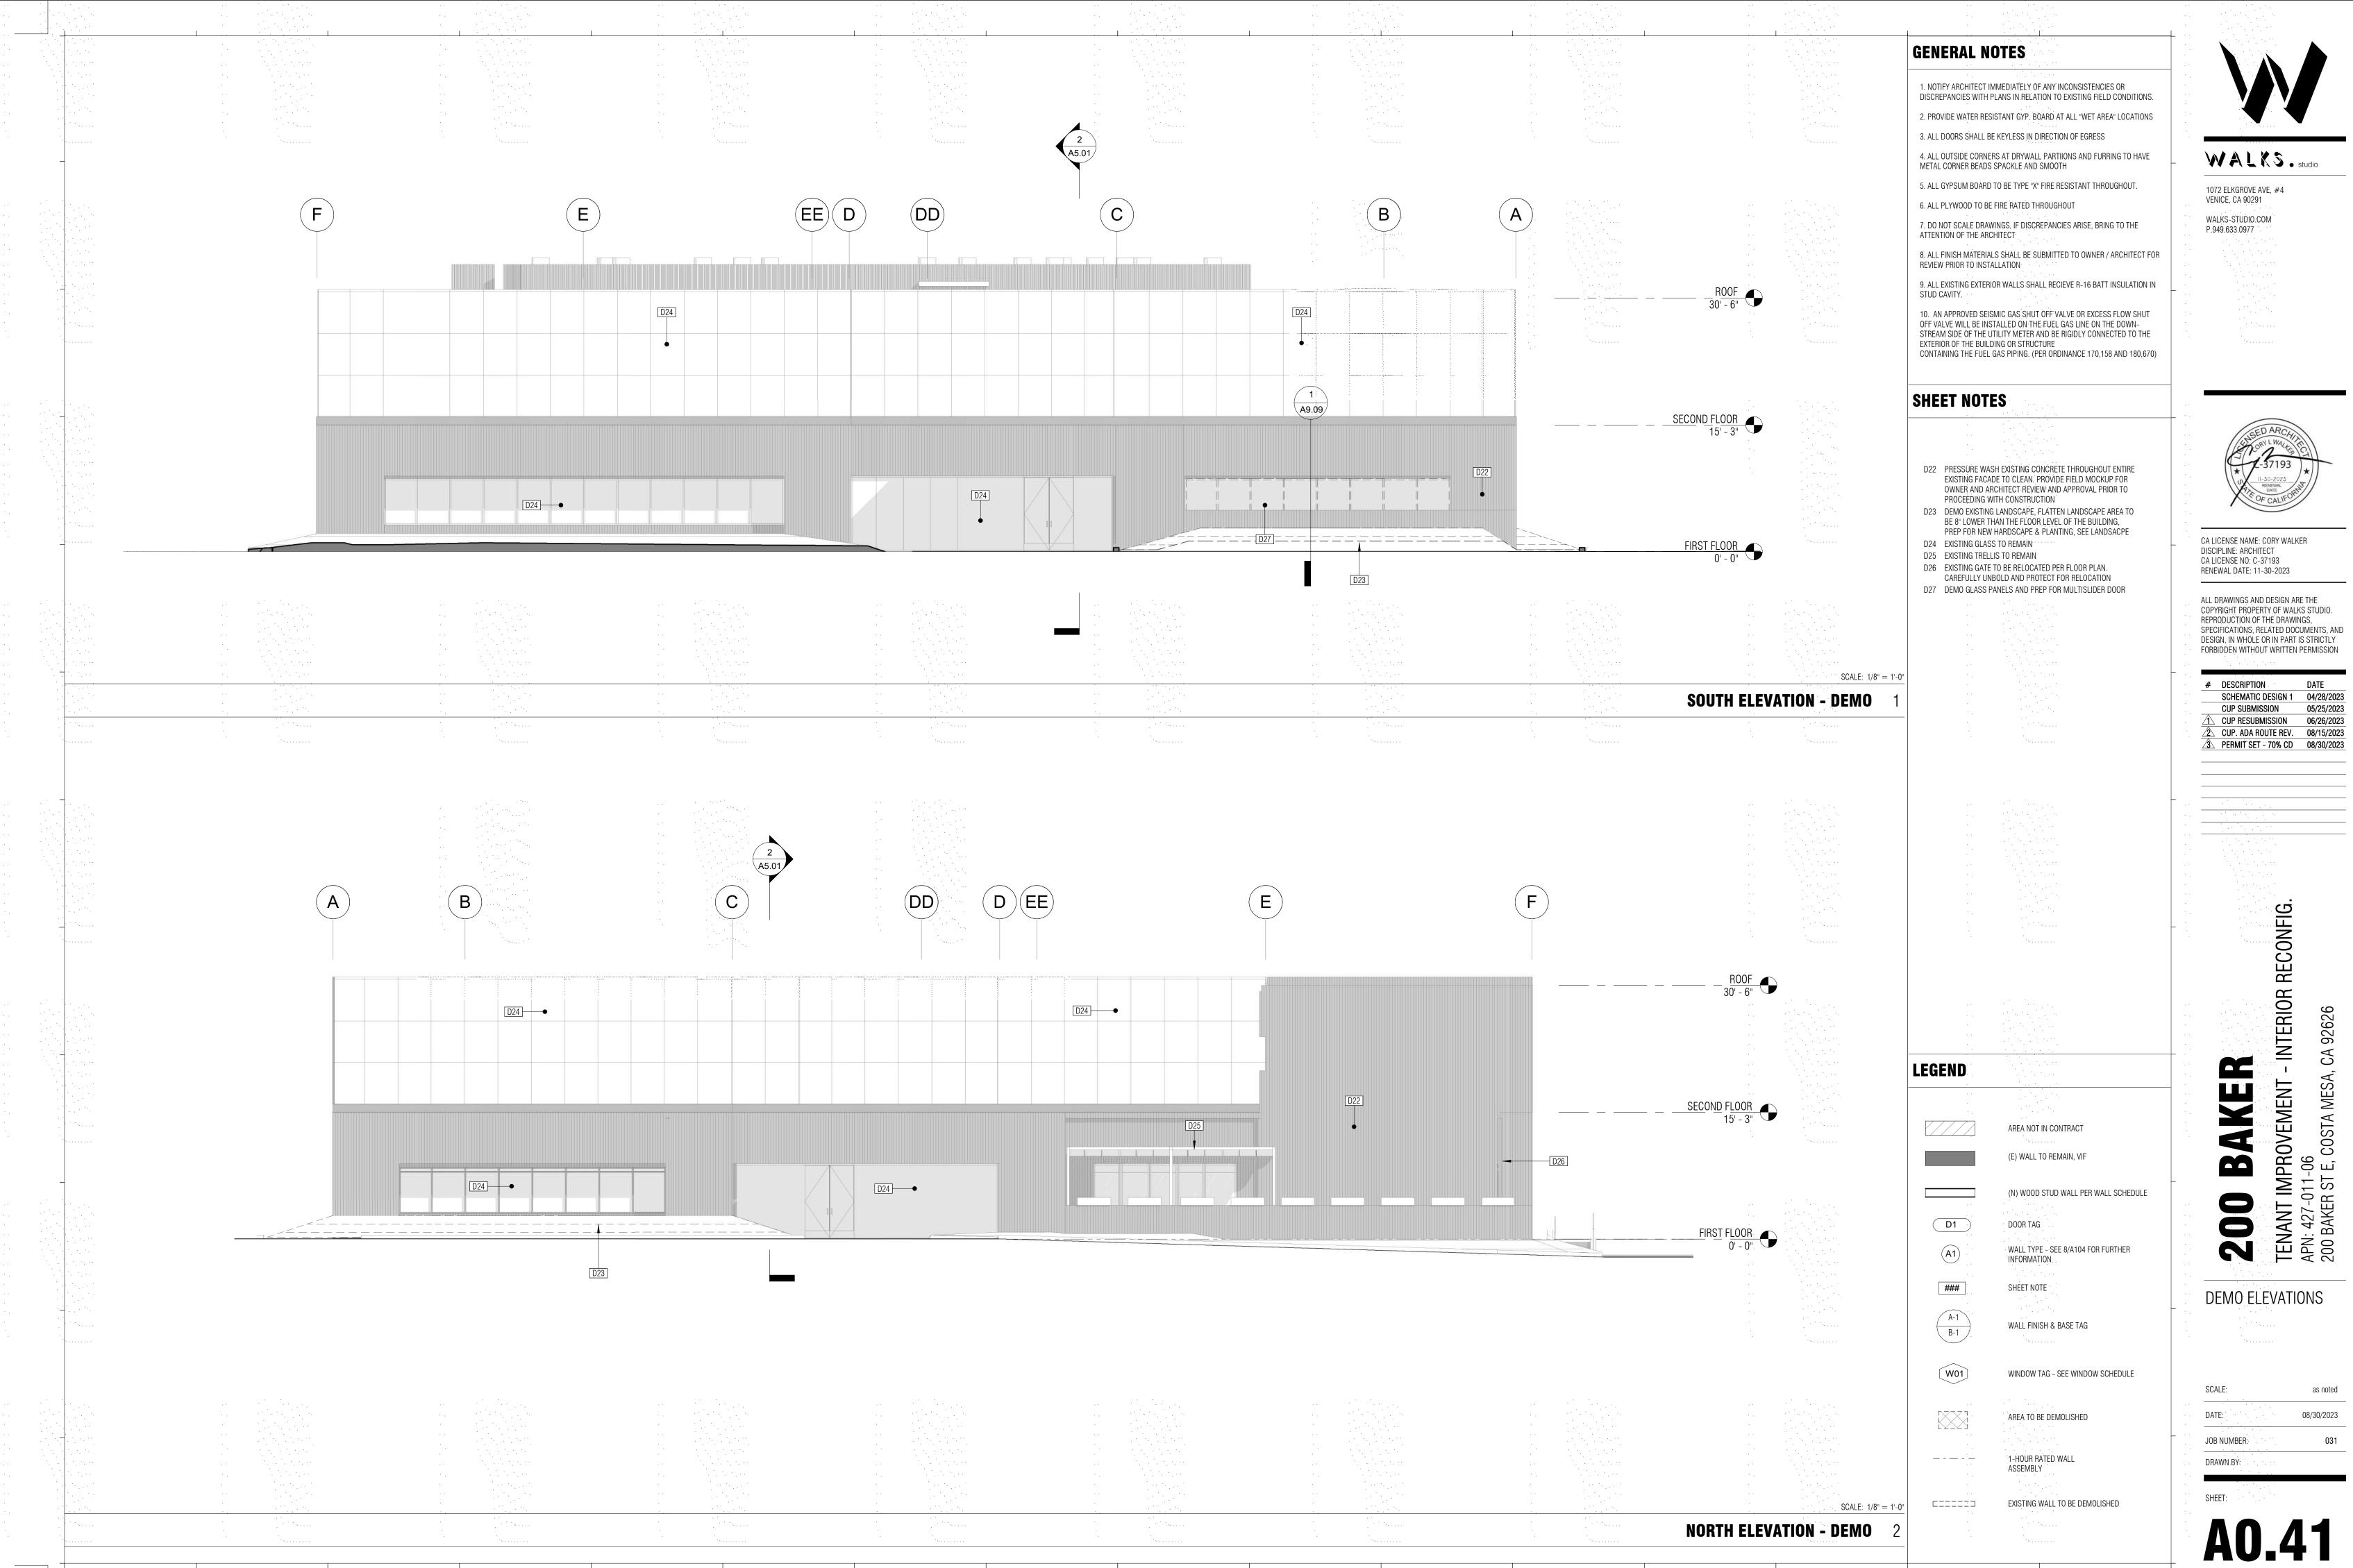
AREA TO BE DEMOLISHED


1-HOUR RATED WALL

ASSEMBLY

SCALE: as noted
DATE: 06/28/2023
JOB NUMBER: 031
DRAWN BY:





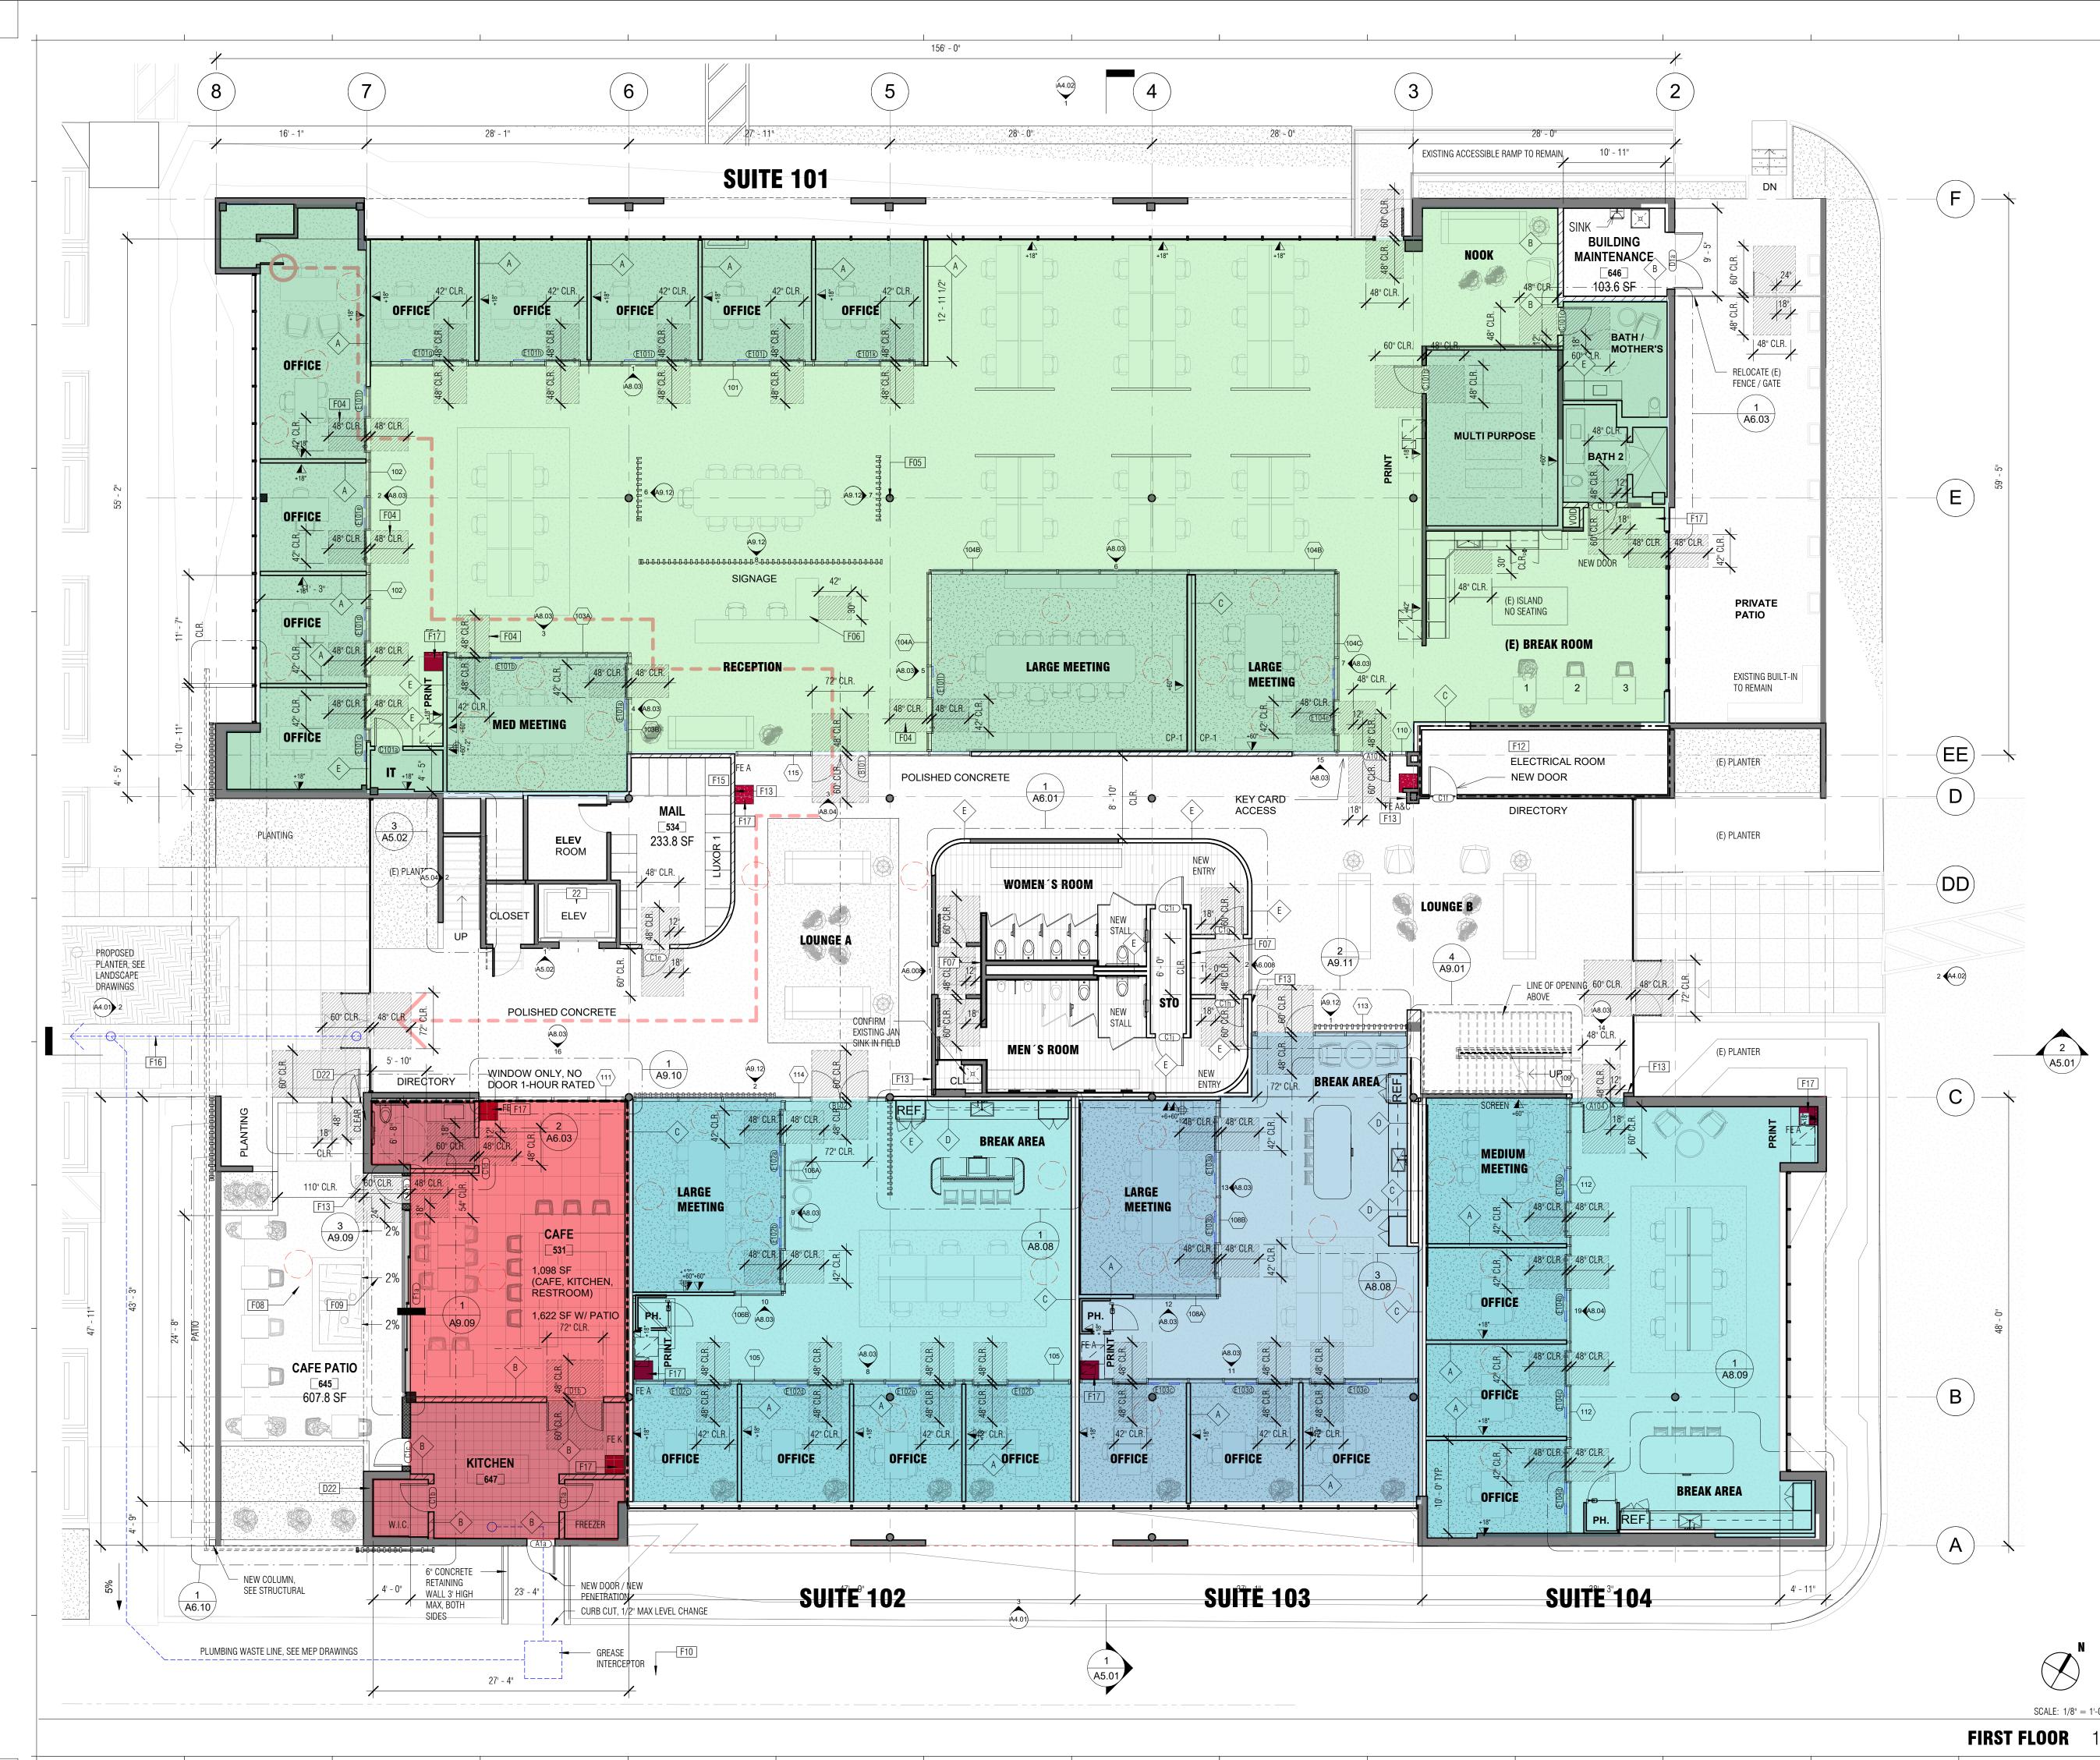

- 1. NOTIFY ARCHITECT IMMEDIATELY OF ANY INCONSISTENCIES OR DISCREPANCIES WITH PLANS IN RELATION TO EXISTING FIELD CONDITIONS.
- 2. PROVIDE WATER RESISTANT GYP. BOARD AT ALL "WET AREA" LOCATIONS
- 3. ALL DOORS SHALL BE KEYLESS IN DIRECTION OF EGRESS
- 4. ALL OUTSIDE CORNERS AT DRYWALL PARTIIONS AND FURRING TO HAVE METAL CORNER BEADS SPACKLE AND SMOOTH
- 5. ALL GYPSUM BOARD TO BE TYPE "X" FIRE RESISTANT THROUGHOUT.6. ALL PLYWOOD TO BE FIRE RATED THROUGHOUT
- 7. DO NOT SCALE DRAWINGS. IF DISCREPANCIES ARISE, BRING TO THE
- ATTENTION OF THE ARCHITECT 8. ALL FINISH MATERIALS SHALL BE SUBMITTED TO OWNER / ARCHITECT FOR REVIEW PRIOR TO INSTALLATION
- 9. ALL EXISTING EXTERIOR WALLS SHALL RECIEVE R-16 BATT INSULATION IN STUD CAVITY.
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- 11. DEMO EXISTING DUCTWORK & PREP FOR ALL NEW DUCTWORK PER MECHANICAL DRAWINGS

# **SHEET NOTES**

- 22 ELEVATOR CAB FLOOR TO BE 1/2" MAX ABOVE FINISH FLOORING. CONTRACTROR TO ADJUST LEVEL 1 AND LEVEL 2 STOP HEIGHTS TO MEET ADA FLOOR TRANSITION REQUIREMENTS. PROVIDE NEW FINISHES IN ELEVATOR CAB. FLOORING TO MATCH 2ND FLOOR COORIDOR FLOORING SPECIFICATION
- D22 PRESSURE WASH EXISTING CONCRETE THROUGHOUT ENTIRE EXISTING FACADE TO CLEAN. PROVIDE FIELD MOCKUP FOR OWNER AND ARCHITECT REVIEW AND APPROVAL PRIOR TO PROCEEDING WITH CONSTRUCTION
- F04 PROVIDE MIN. ADA DOOR CLEARANCES AT OPENING. DO NOT BLOCK THESE CLEARANCES, PERMANENTLY. ANY FLOOR TRANSITIONS SHALL BE 1/2" MAX VERTICAL HEIGHT DIFFERENCE IN FLOOR ELEVATIONS, WITH A 1/4" BEVELED EDGE. TYPICAL AT ALL DOORS.
- F05 SAND, PRIME & PAINT (E) COLUMNS. PROVIDE IN-FIELD MOCKUP FOR ARCHITECT'S APPROVAL TO PROCEED PRIOR TO FINISHING ALL COLUMNS
- F06 34" HIGH ADA COUNTER. 5'-0" MIN. LENGTH
- F07 CLAD WALL WITH TONGUE AND GROOVE WHITE OAK WALL PANELINGF08 SEE LANDSCAPE FOR PATIO DETAILING
- F09SLOPE PATIO FLOORING MINIMUM 2% AWAY FROM BUILDINGF10UNDER EXISTING ROAD, PROVIDE NEW ASPHALT FINISH TO MATCH
- F12 EXISTING ELECTRICAL ROOM REQUIRES A 1-HOUR RATING. PATCH ALL HOLES AND OPENINGS TO RETURN THE ELECTRICAL ROOM TO A 1-HOUR RATING
- F13 PROVIDE KNOX BOX AT EACH AND EVERY TENANT ENTRANCE WITH A KEY FOR THE FIRE DEPARTMENT TO GAIN ACCESS TO THE SUITE IN AN EMERGENCY
- F15 BUILT-IN PACKAGE STORAGE SYSTEM: BASIS OF DESIGN: LUXER ONE. PROVIDE FRAMED AND GYP BOARD HEADER TO BE FLUSH WITH FACE OF PACKAGE STORAGE SYSTEM
   F16 APPROXIMATE LINE OF PLUMBING MAIN LINE. CONNECT RESTAURANT
- PLUMBING WASTE LINES TO JOIN AT APPROX. -6 FT DEEP MAIN LINE. SEE PLUMBING DRAWINGS
- F17 FE-"X", FIRE EXTINGUISHER, CLASSES "A/D/K" ACCORDING TO THE NOTE ON THE PLAN





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2	CUP. ADA ROUTE REV.	08/15/2023
3	PERMIT SET - 70% CD	08/30/2023
4	CUP - PARKING REV.	09/21/2023

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D1

(A1)

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A-1 B-1

(W01)

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DEMO AREA, REFER TO KEYNOTES AREA NOT IN CONTRACT

(E) WALL TO REMAIN, VIF

(N) WOOD STUD WALL PER WALL SCHEDULE

DOOR TAG

WALL TYPE - SEE 8/A104 FOR FURTHER INFORMATION

SHEET NOTE

WALL FINISH & BASE TAG

WINDOW TAG - SEE WINDOW SCHEDULE

AREA TO BE DEMOLISHED

1-HOUR RATED WALL ASSEMBLY


EXISTING WALL TO BE DEMOLISHED



CONSTRUCTION
PLAN - LEVEL 1

SCALE:	as noted
DATE:	09/21/2023
JOB NUMBER:	031
DRAWN BY:	



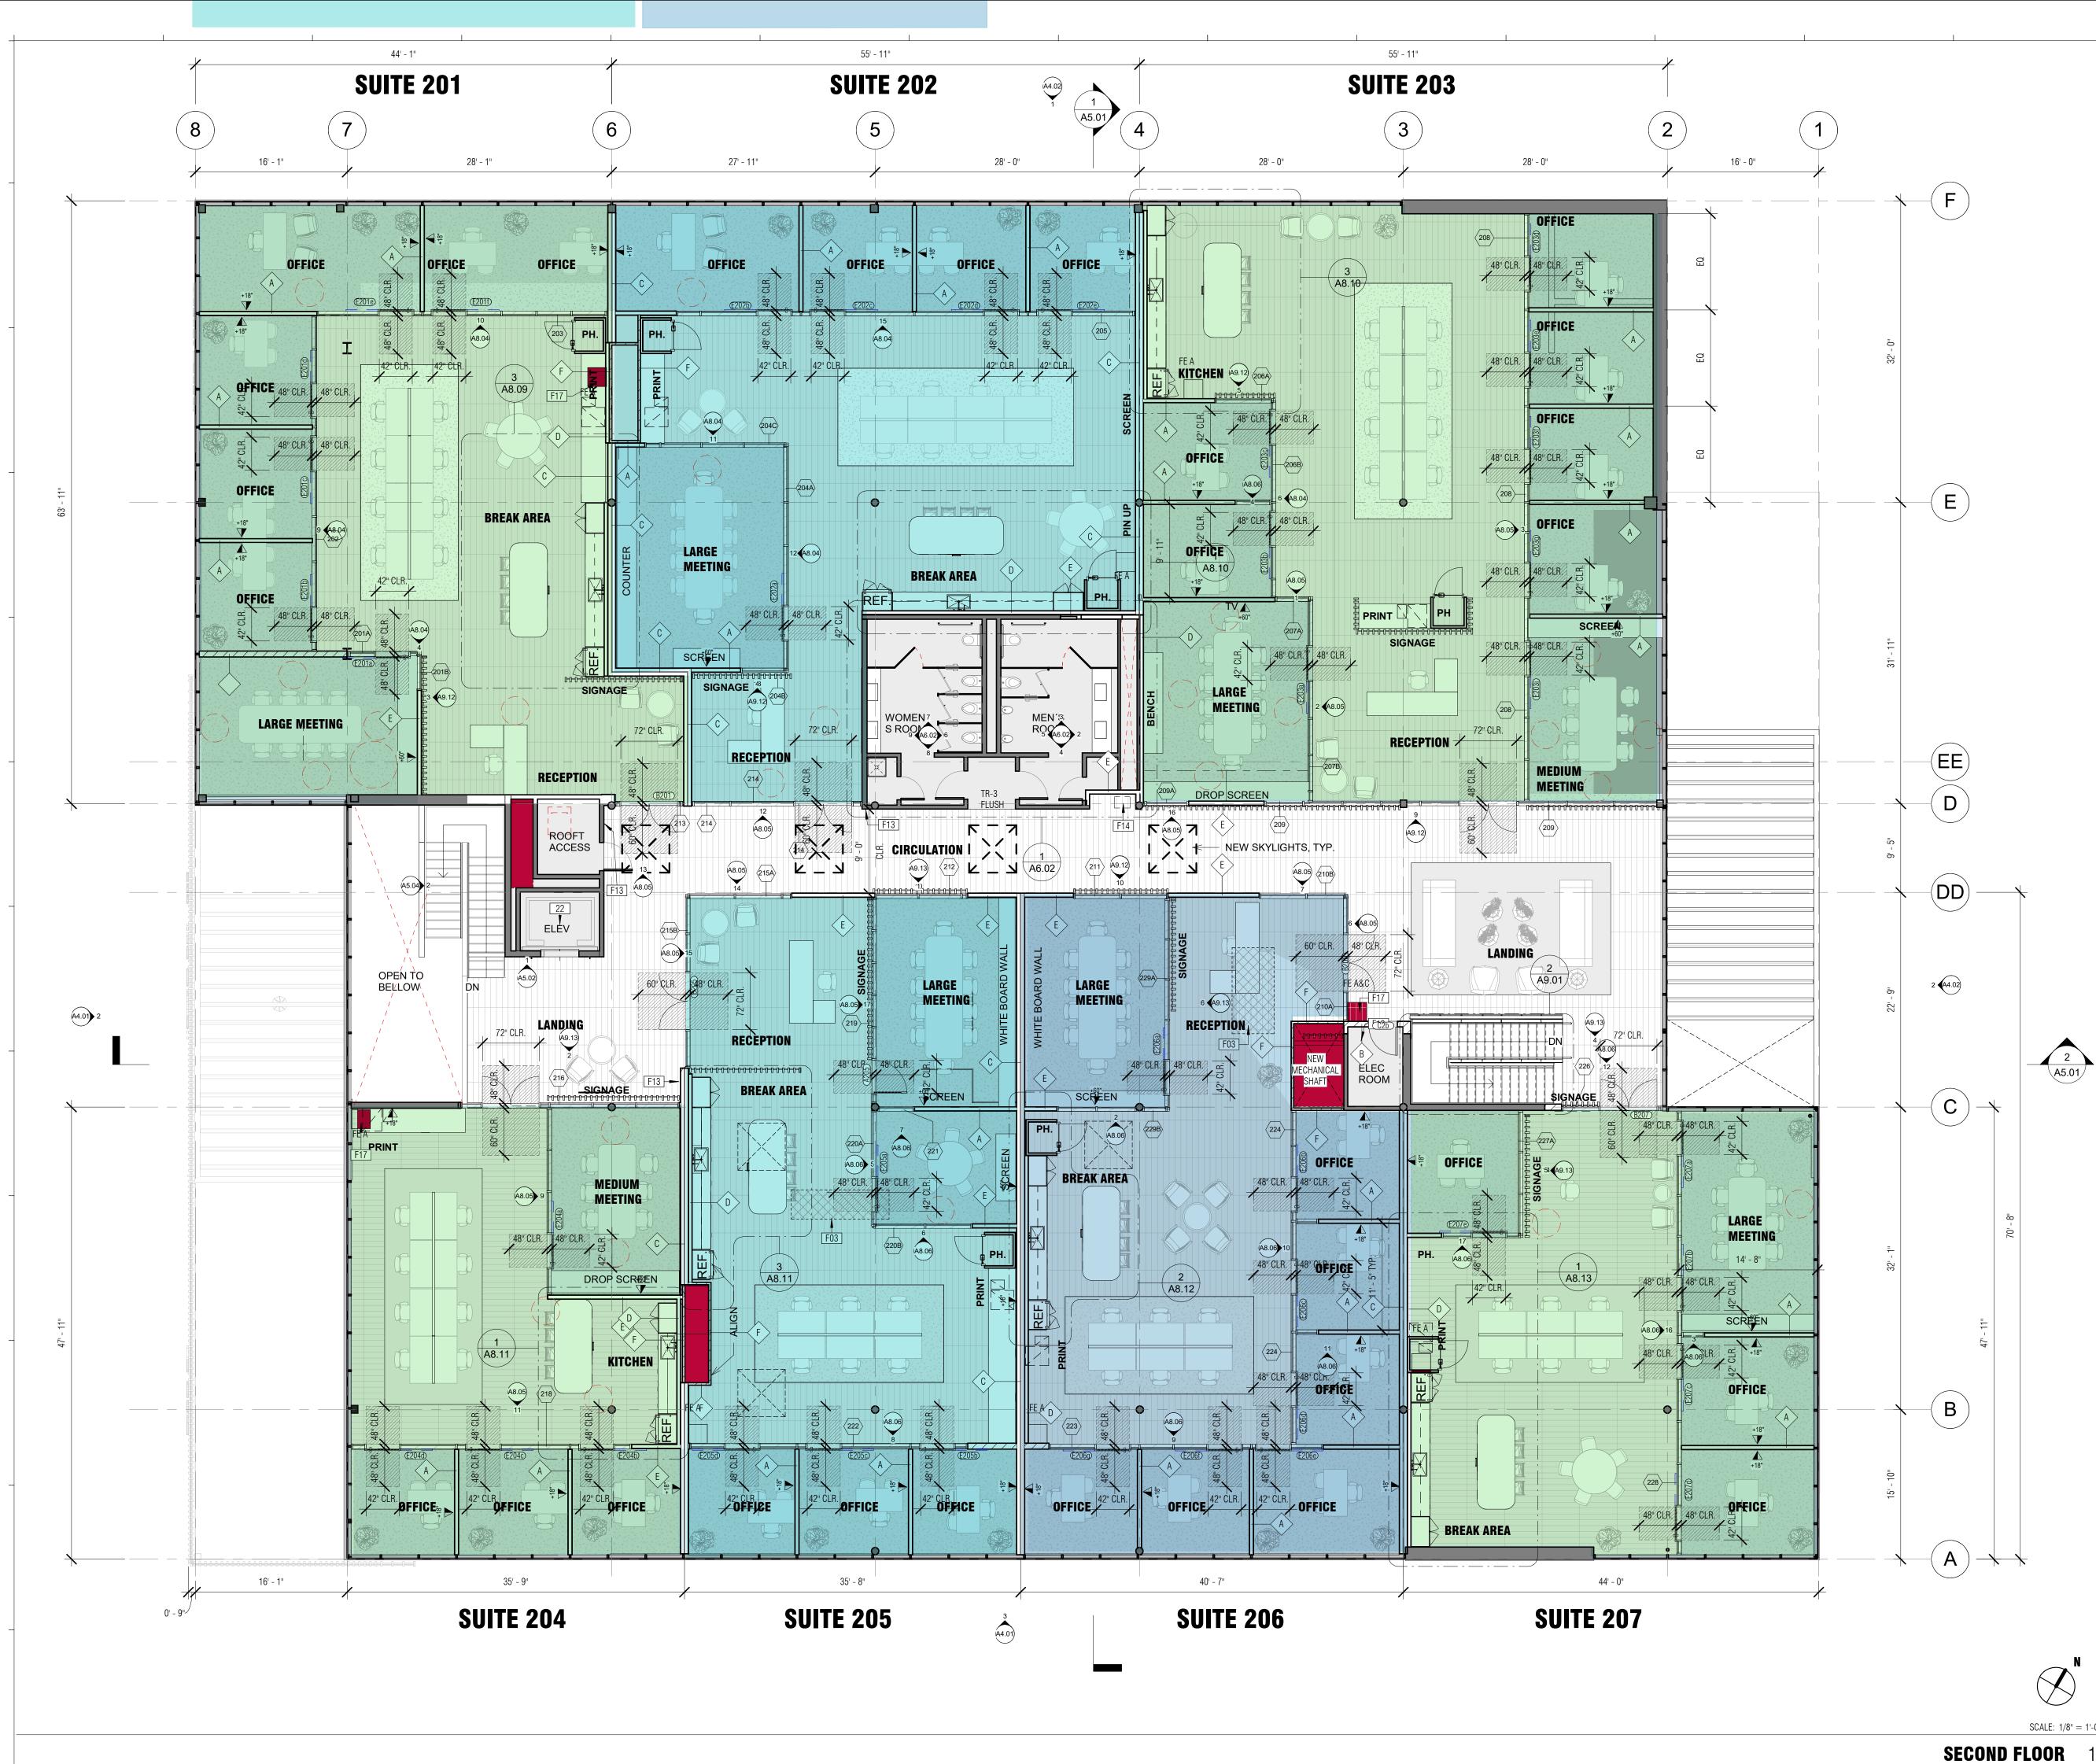

-21-

# **GENERAL NOTES**

- 1. NOTIFY ARCHITECT IMMEDIATELY OF ANY INCONSISTENCIES OR DISCREPANCIES WITH PLANS IN RELATION TO EXISTING FIELD CONDITIONS.
- 2. PROVIDE WATER RESISTANT GYP. BOARD AT ALL "WET AREA" LOCATIONS
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- 5. ALL GYPSUM BOARD TO BE TYPE "X" FIRE RESISTANT THROUGHOUT. 6. ALL PLYWOOD TO BE FIRE RATED THROUGHOUT
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- F03 PATCH (E) SHAFT OPENING. SEE STRUCTURAL FOR FLOORING INFILL. SHAFT TO BE RELOCATED TO SOUTH-EAST, LABELED (NEW SHAFT OPENING)
- F13 PROVIDE KNOX BOX AT EACH AND EVERY TENANT ENTRANCE WITH A KEY FOR THE FIRE DEPARTMENT TO GAIN ACCESS TO THE SUITE IN AN EMERGENCY
- F14 HIGH-LOW REFRIGERATED DRINKING FOUNTAIN, SEE APPLIANCE SCHEDULE FOR SPECIFICATION
- F17 FE-"X", FIRE EXTINGUISHER, CLASSES "A/D/K" ACCORDING TO THE NOTE ON THE PLAN





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3	PERMIT SET - 70% CD	08/30/2023
4	CUP - PARKING REV.	09/21/2023

LEGEND 

> ( D1 (A1)

### A-1 B-1

(W01)

\_ - \_ - \_ \_

DEMO AREA, REFER TO KEYNOTES AREA NOT IN CONTRACT (E) WALL TO REMAIN, VIF (N) WOOD STUD WALL PER WALL SCHEDULE DOOR TAG WALL TYPE - SEE 8/A104 FOR FURTHER INFORMATION SHEET NOTE WALL FINISH & BASE TAG

WINDOW TAG - SEE WINDOW SCHEDULE


AREA TO BE DEMOLISHED

1-HOUR RATED WALL ASSEMBLY


EXISTING WALL TO BE DEMOLISHED

INTERIOR RECONFIG. 92626 CA KER TENANT IMPROVEMENT -APN: 427-011-06 200 BAKER ST E, COSTA MESA, COSTA MESA 0 lacksquareÑ

# CONSTRUCTION PLAN - LEVEL 2

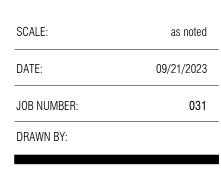



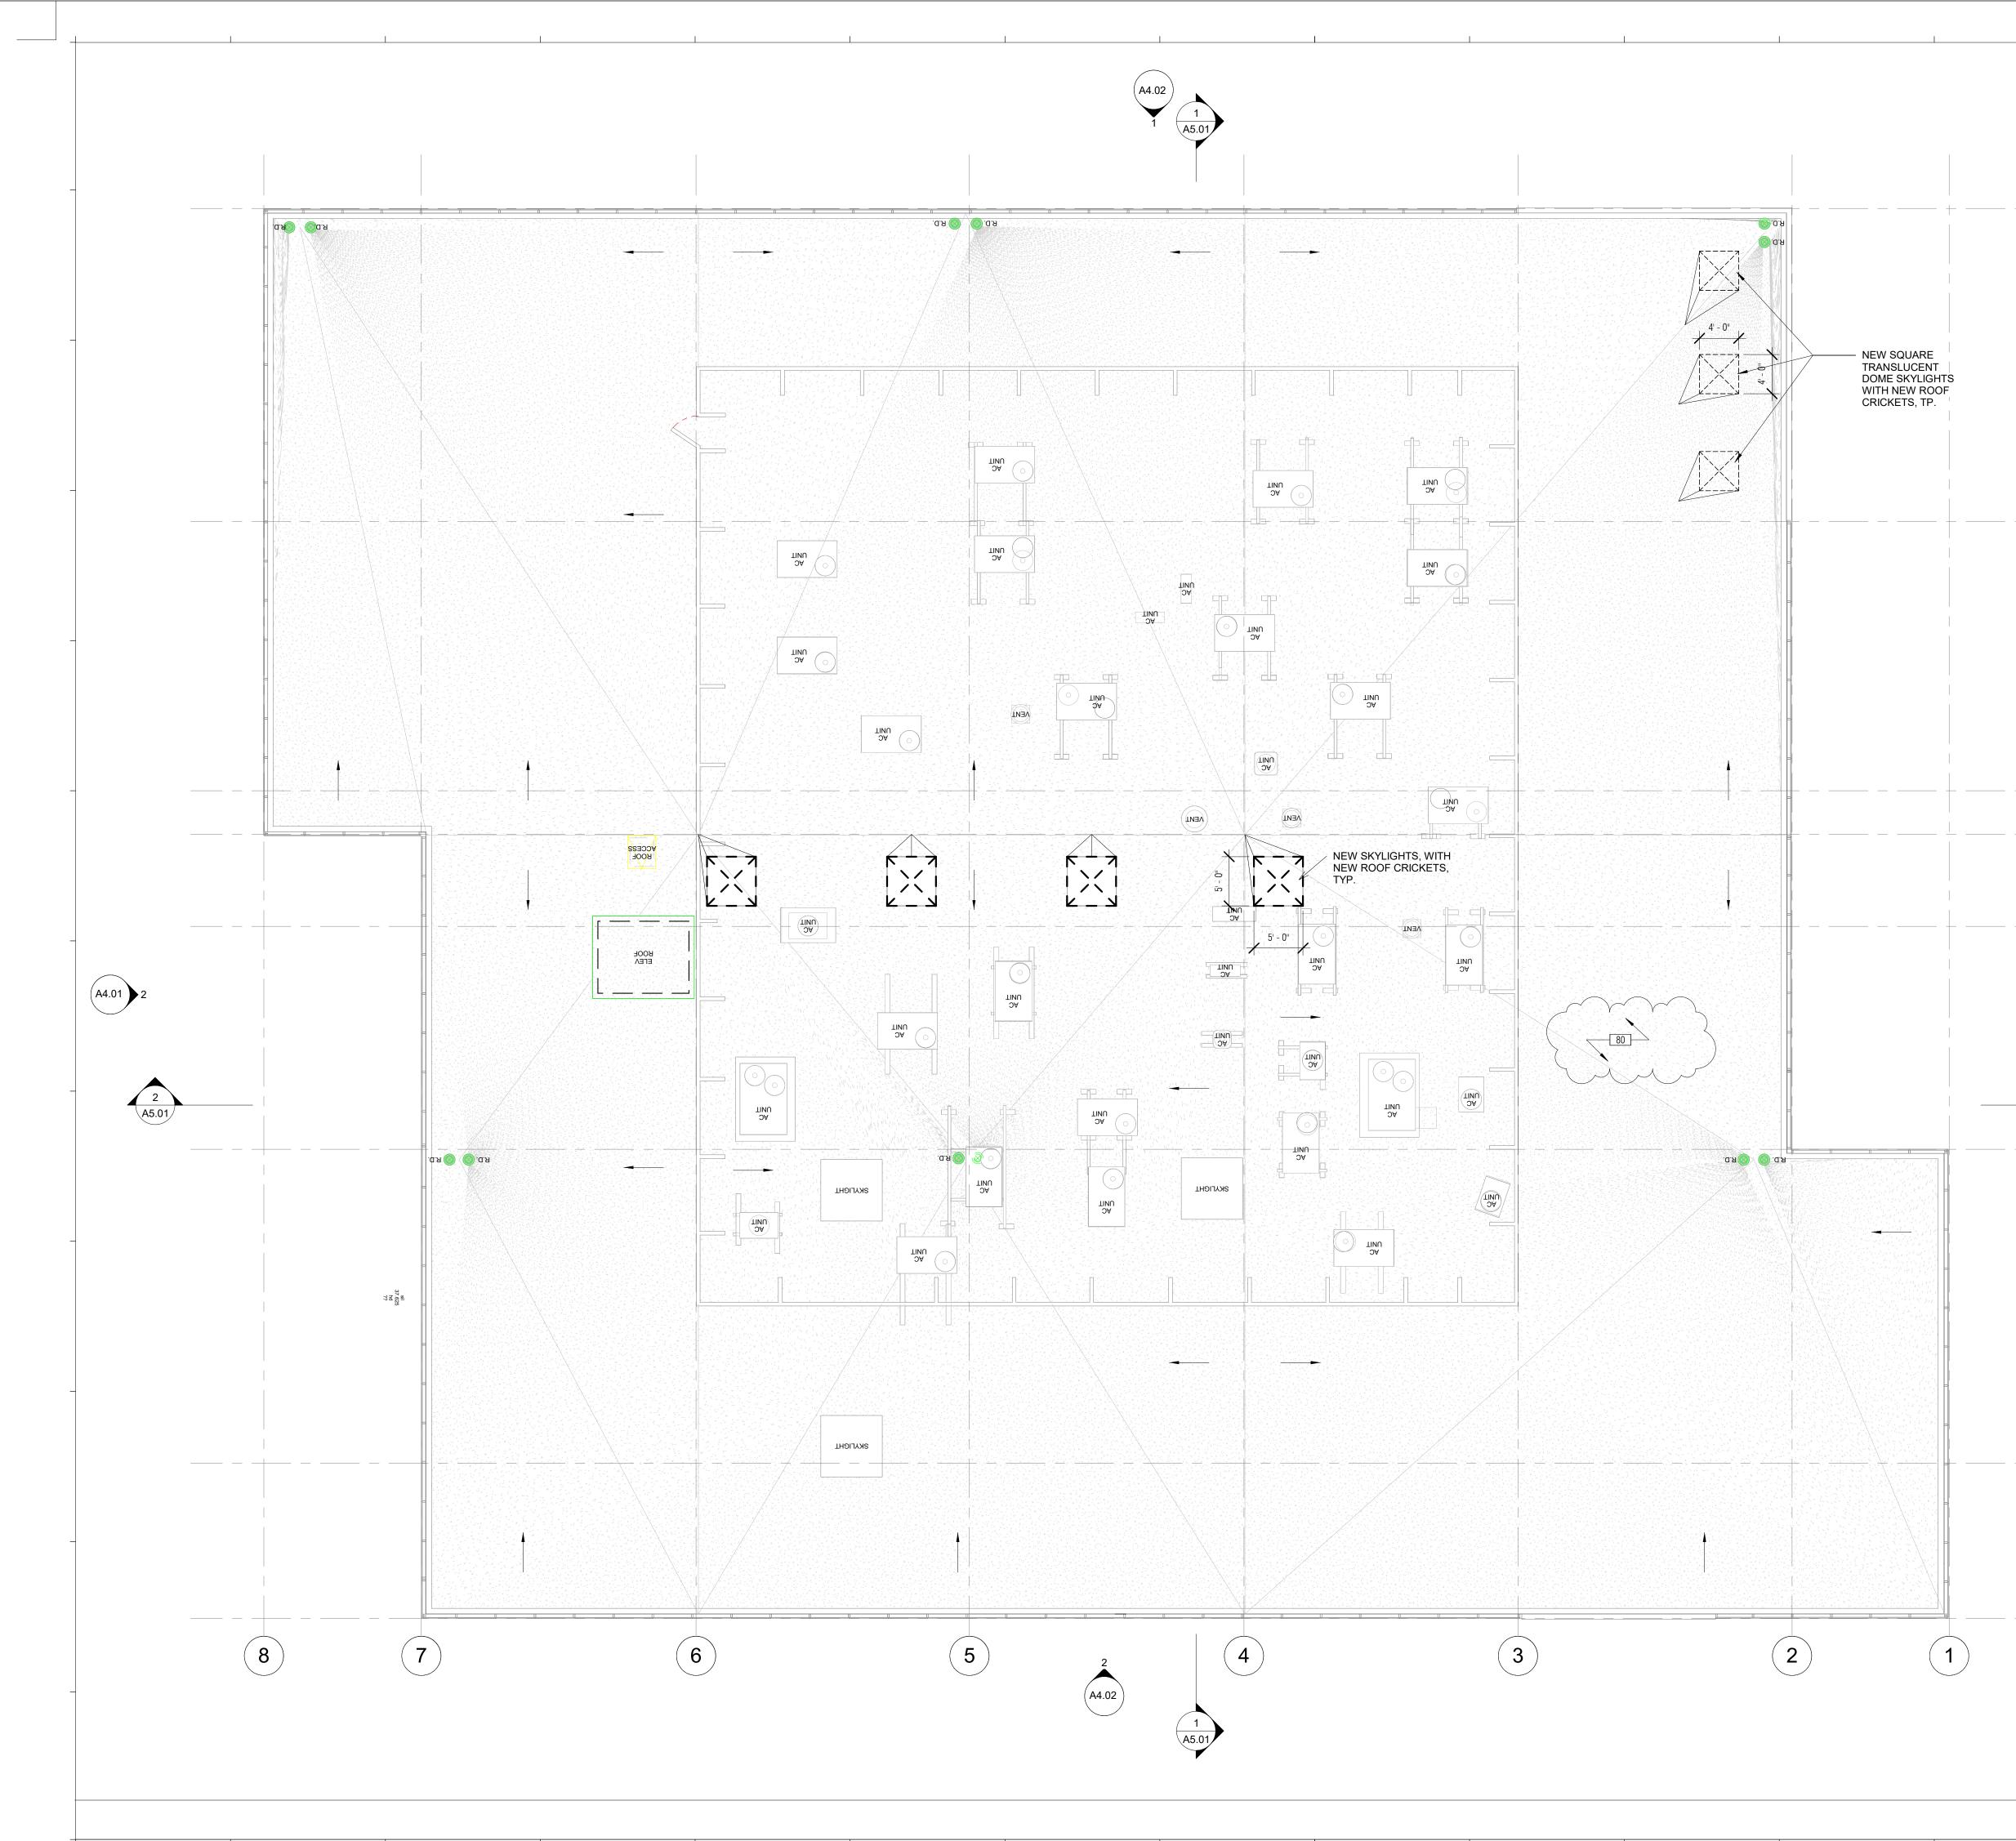

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D

3 (A4.02)

2 A5.01

 $\widetilde{\mathbf{C}}$ 

B

(A)

1. NOTIFY ARCHITECT IMMEDIATELY OF ANY INCONSISTENCIES OR DISCREPANCIES WITH PLANS IN RELATION TO EXISTING FIELD CONDITIONS. 2. PROVIDE WATER RESISTANT GYP. BOARD AT ALL "WET AREA" LOCATIONS

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# SHEET NOTES

# 80 PER ROOF INSPECTION REPORT, THERE ARE MULTIPLE AREAS EXPERIENCING DEFLECTION, DUE TO DAMAGED PLYWOOD DECKING DUE TO WATER INTRUSION. THE EXISING ROOF MEMBRANE IS PRONE TO LEAKS AND IS IN NEED OF DEFLECTION. AMS RECOMMENDS EITHER REPLACING THE ROOF MEMBRANE OR APPLYING A RESTORATION COATING TO WATERTIGHT THE EXISTING ROOF.

LEGEND

	AREA NOT IN CONTRACT
	(E) WALL TO REMAIN, VIF
	(N) WOOD STUD WALL PER WALL SCHEDULE
D1	DOOR TAG
A1	WALL TYPE - SEE 8/A104 FOR FURTHER INFORMATION
####	SHEET NOTE
A-1 B-1	WALL FINISH & BASE TAG
W01	WINDOW TAG - SEE WINDOW SCHEDULE
	AREA TO BE DEMOLISHED
	1-HOUR RATED WALL ASSEMBLY

# 1072 ELKGROVE AVE, #4 VENICE, CA 90291 WALKS-STUDIO.COM P.949.633.0977 CA LICENSE NAME: CORY WALKER DISCIPLINE: ARCHITECT CA LICENSE NO: C-37193 RENEWAL DATE: 11-30-2023 ALL DRAWINGS AND DESIGN ARE THE COPYRIGHT PROPERTY OF WALKS STUDIO. REPRODUCTION OF THE DRAWINGS, SPECIFICATIONS, RELATED DOCUMENTS, AND DESIGN, IN WHOLE OR IN PART IS STRICTLY FORBIDDEN WITHOUT WRITTEN PERMISSION # DESCRIPTION DATE SCHEMATIC DESIGN 1 04/28/2023 CUP SUBMISSION 05/25/2023 CUP RESUBMISSION 06/26/2023



# CONSTRUCTION -ROOF PLAN

SCALE:	as notec
DATE:	06/28/2023
JOB NUMBER:	031
DRAWN BY:	




SHEET:

ROOF

 $\bigcirc$ 

SCALE: 1/8" = 1'-0"

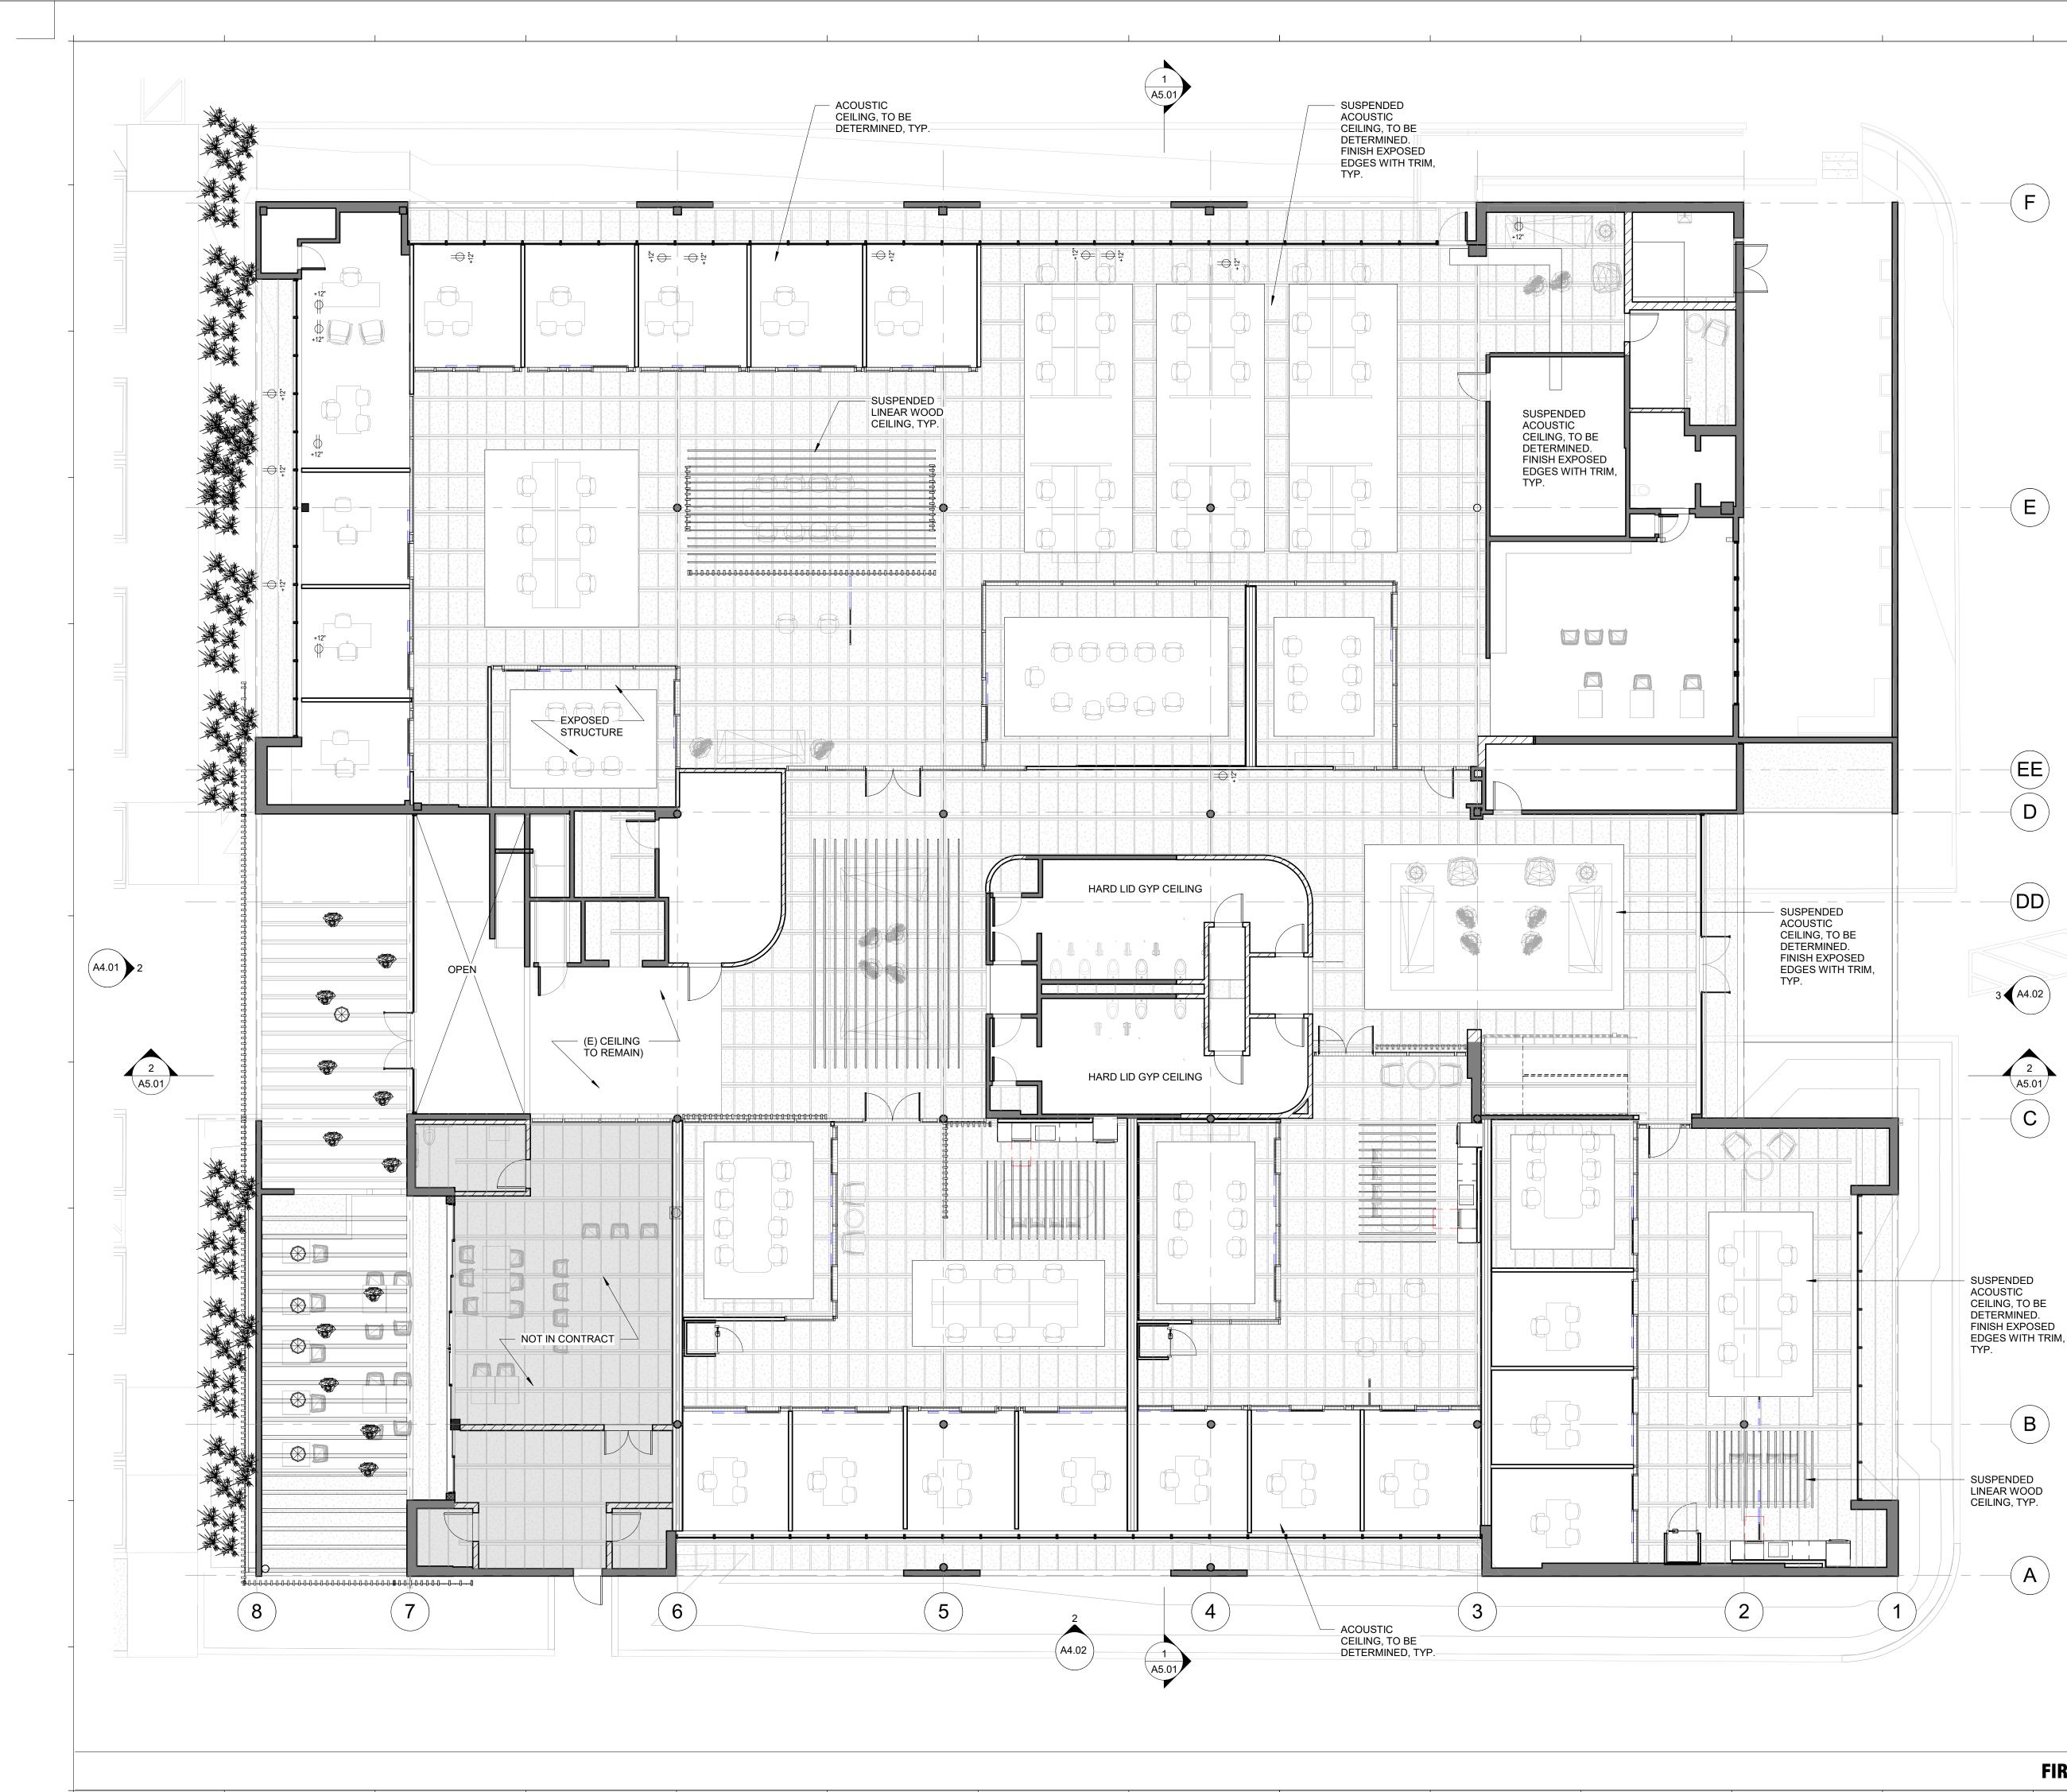

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D

 $(\mathsf{D}\mathsf{D})$ 

3 A4.02

2 A5.01 - C

B

 $(\mathsf{A})$ 

1. NOTIFY ARCHITECT IMMEDIATELY OF ANY INCONSISTENCIES OR DISCREPANCIES WITH PLANS IN RELATION TO EXISTING FIELD CONDITIONS. 2. PROVIDE WATER RESISTANT GYP. BOARD AT ALL "WET AREA" LOCATIONS

3. ALL DOORS SHALL BE KEYLESS IN DIRECTION OF EGRESS

4. ALL OUTSIDE CORNERS AT DRYWALL PARTIIONS AND FURRING TO HAVE METAL CORNER BEADS SPACKLE AND SMOOTH 5. ALL GYPSUM BOARD TO BE TYPE "X" FIRE RESISTANT THROUGHOUT.

6. ALL PLYWOOD TO BE FIRE RATED THROUGHOUT


7. DO NOT SCALE DRAWINGS. IF DISCREPANCIES ARISE, BRING TO THE ATTENTION OF THE ARCHITECT

8. ALL FINISH MATERIALS SHALL BE SUBMITTED TO OWNER / ARCHITECT FOR REVIEW PRIOR TO INSTALLATION

9. ALL EXISTING EXTERIOR WALLS SHALL RECIEVE R-16 BATT INSULATION IN STUD CAVITY.

10. AN APPROVED SEISMIC GAS SHUT OFF VALVE OR EXCESS FLOW SHUT OFF VALVE WILL BE INSTALLED ON THE FUEL GAS LINE ON THE DOWN-STREAM SIDE OF THE UTILITY METER AND BE RIGIDLY CONNECTED TO THE EXTERIOR OF THE BUILDING OR STRUCTURE CONTAINING THE FUEL GAS PIPING. (PER ORDINANCE 170,158 AND 180,670)

# SHEET NOTES

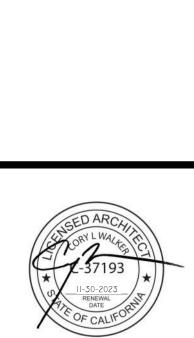

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CA LICENSE NAME: CORY WALKER DISCIPLINE: ARCHITECT CA LICENSE NO: C-37193 RENEWAL DATE: 11-30-2021

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# DESCRIPTION	DATE
SCHEMATIC DESIGN 1	04/28/20
CUP SUBMISSION	05/25/20



	AREA NOT IN CONTRACT
	(E) WALL TO REMAIN, VIF
	(N) WOOD STUD WALL PER WALL SCHEDULE
<b>D1</b>	DOOR TAG
(A1)	WALL TYPE - SEE 8/A104 FOR FURTHER INFORMATION
###	SHEET NOTE
A-1 B-1	WALL FINISH & BASE TAG
W01	WINDOW TAG - SEE WINDOW SCHEDULE
	AREA TO BE DEMOLISHED
	1-HOUR RATED WALL ASSEMBLY



# **REFLECTED CEILING** PLAN - LEVEL 1


SCALE:	as noted
DATE:	09/14/2021
JOB NUMBER:	031
DRAWN BY:	




SHEET:


# FIRST FLOOR


SCALE: 1/8" = 1'-0"

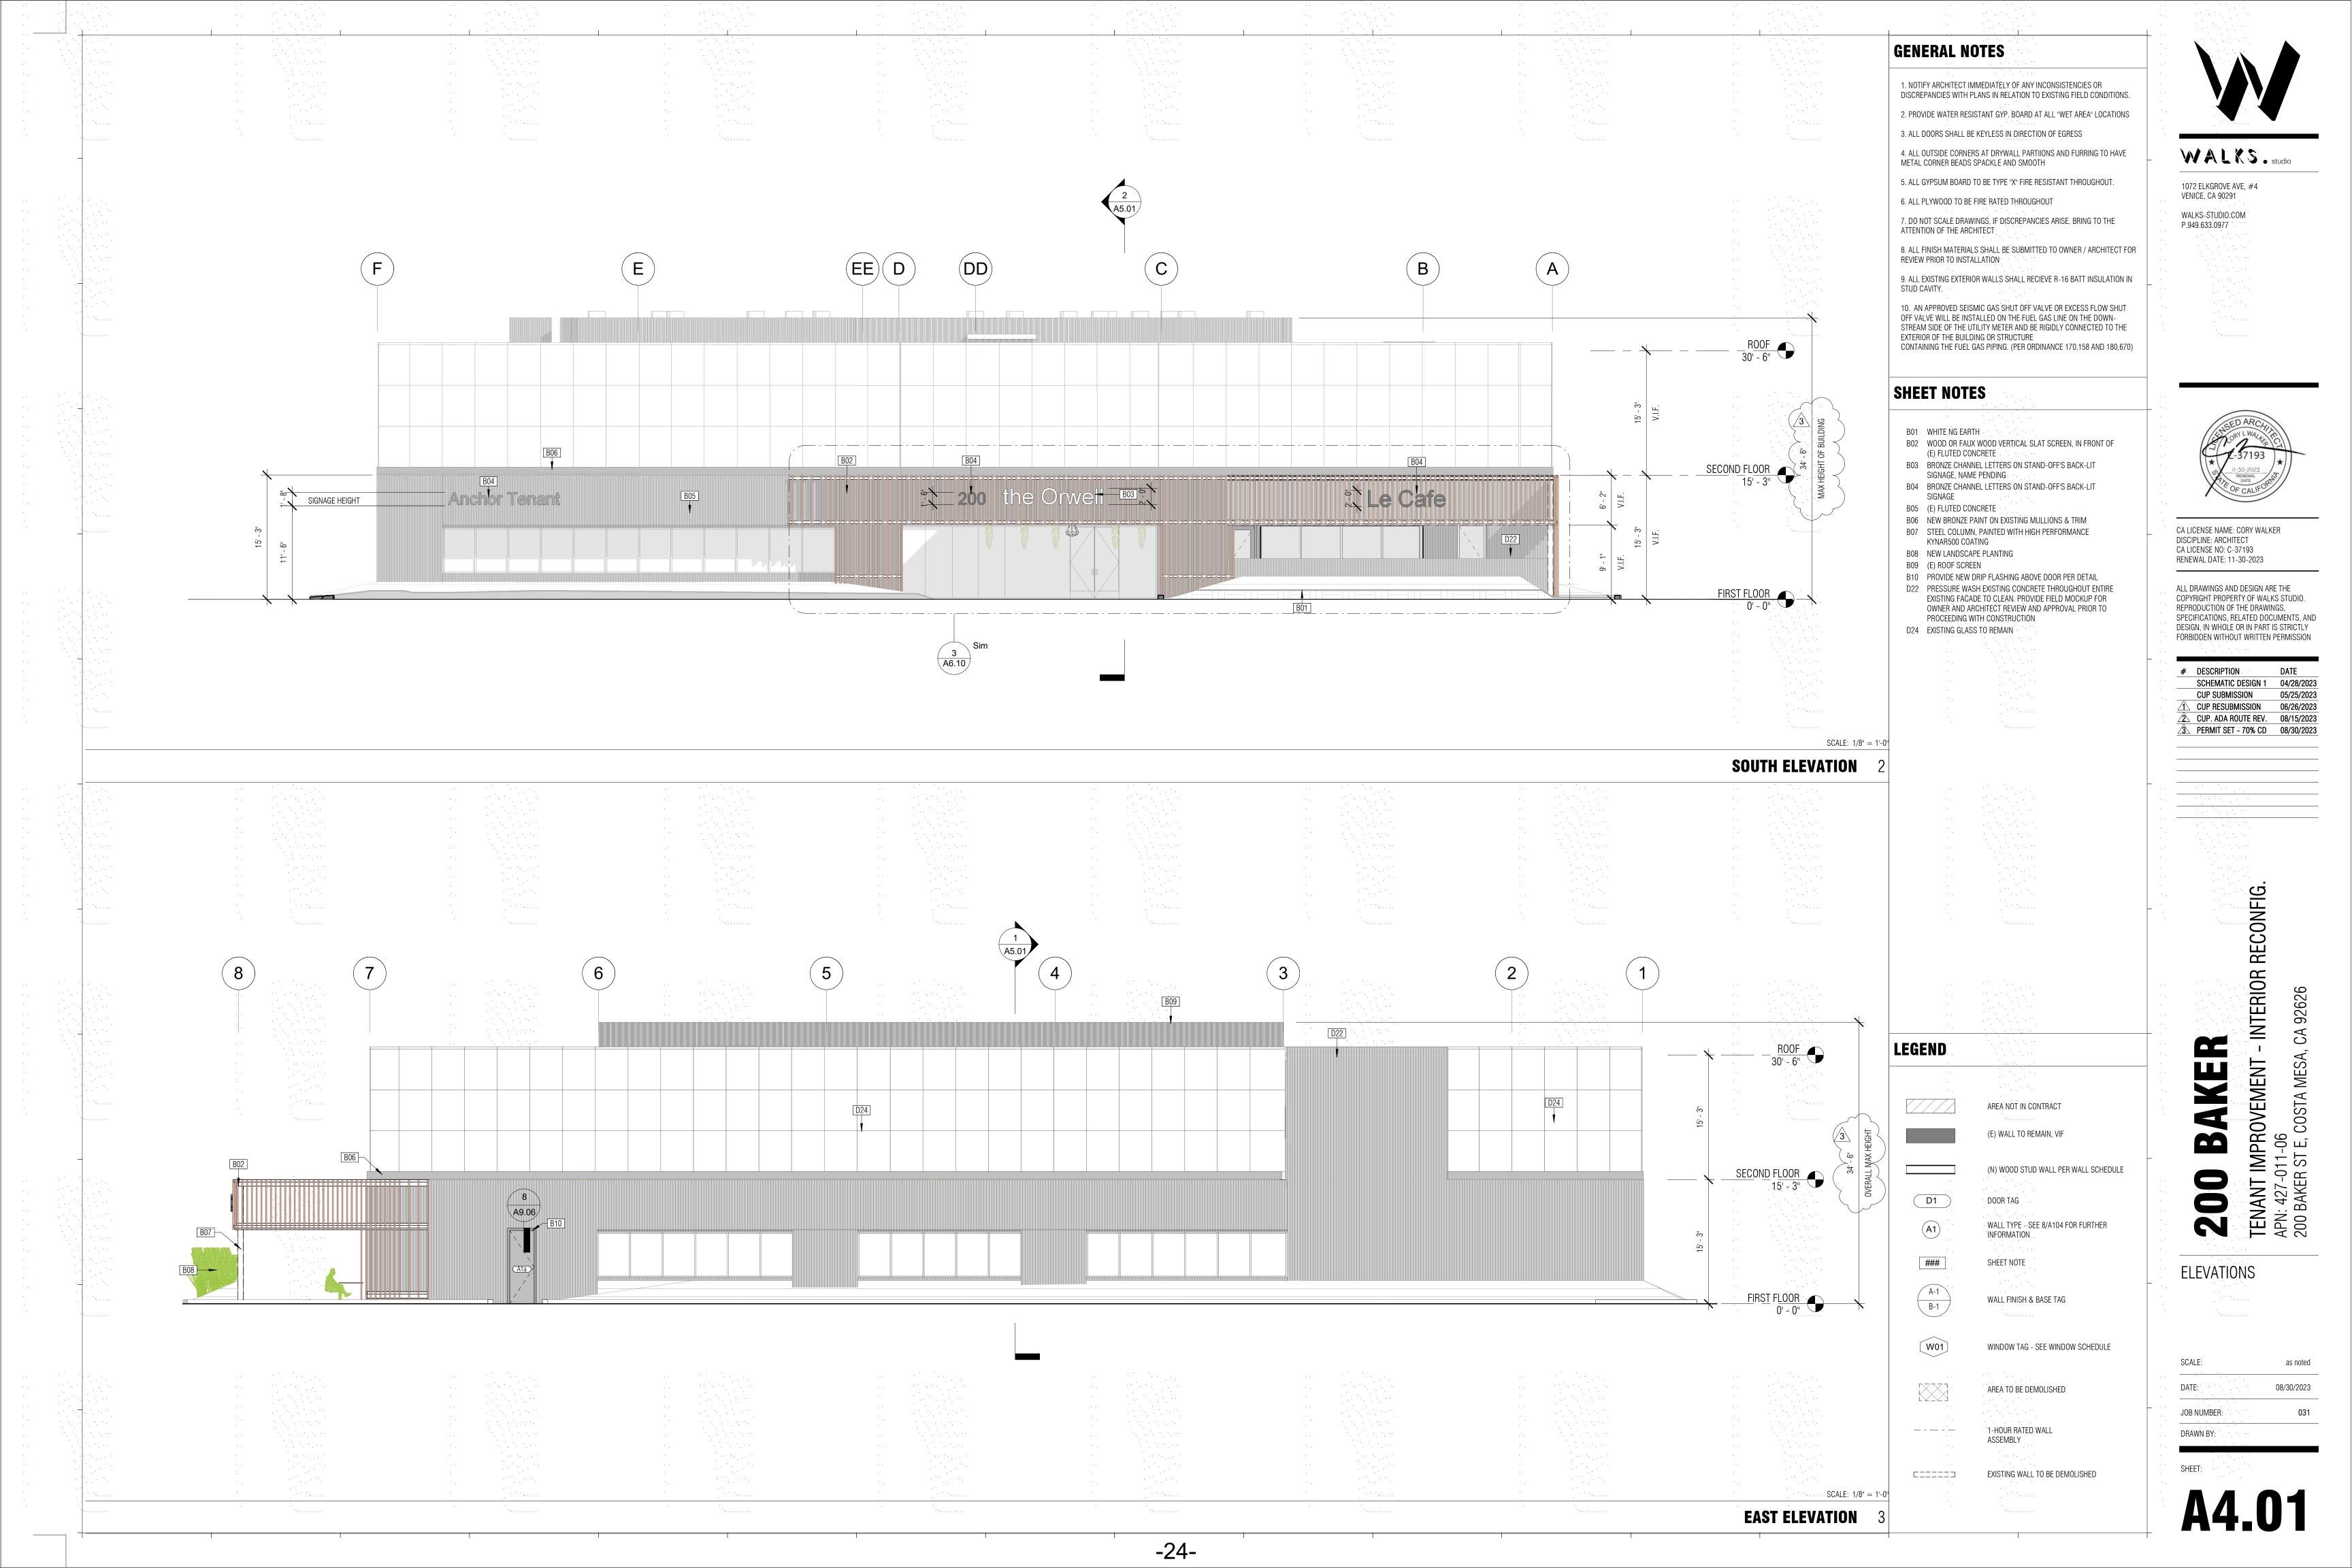

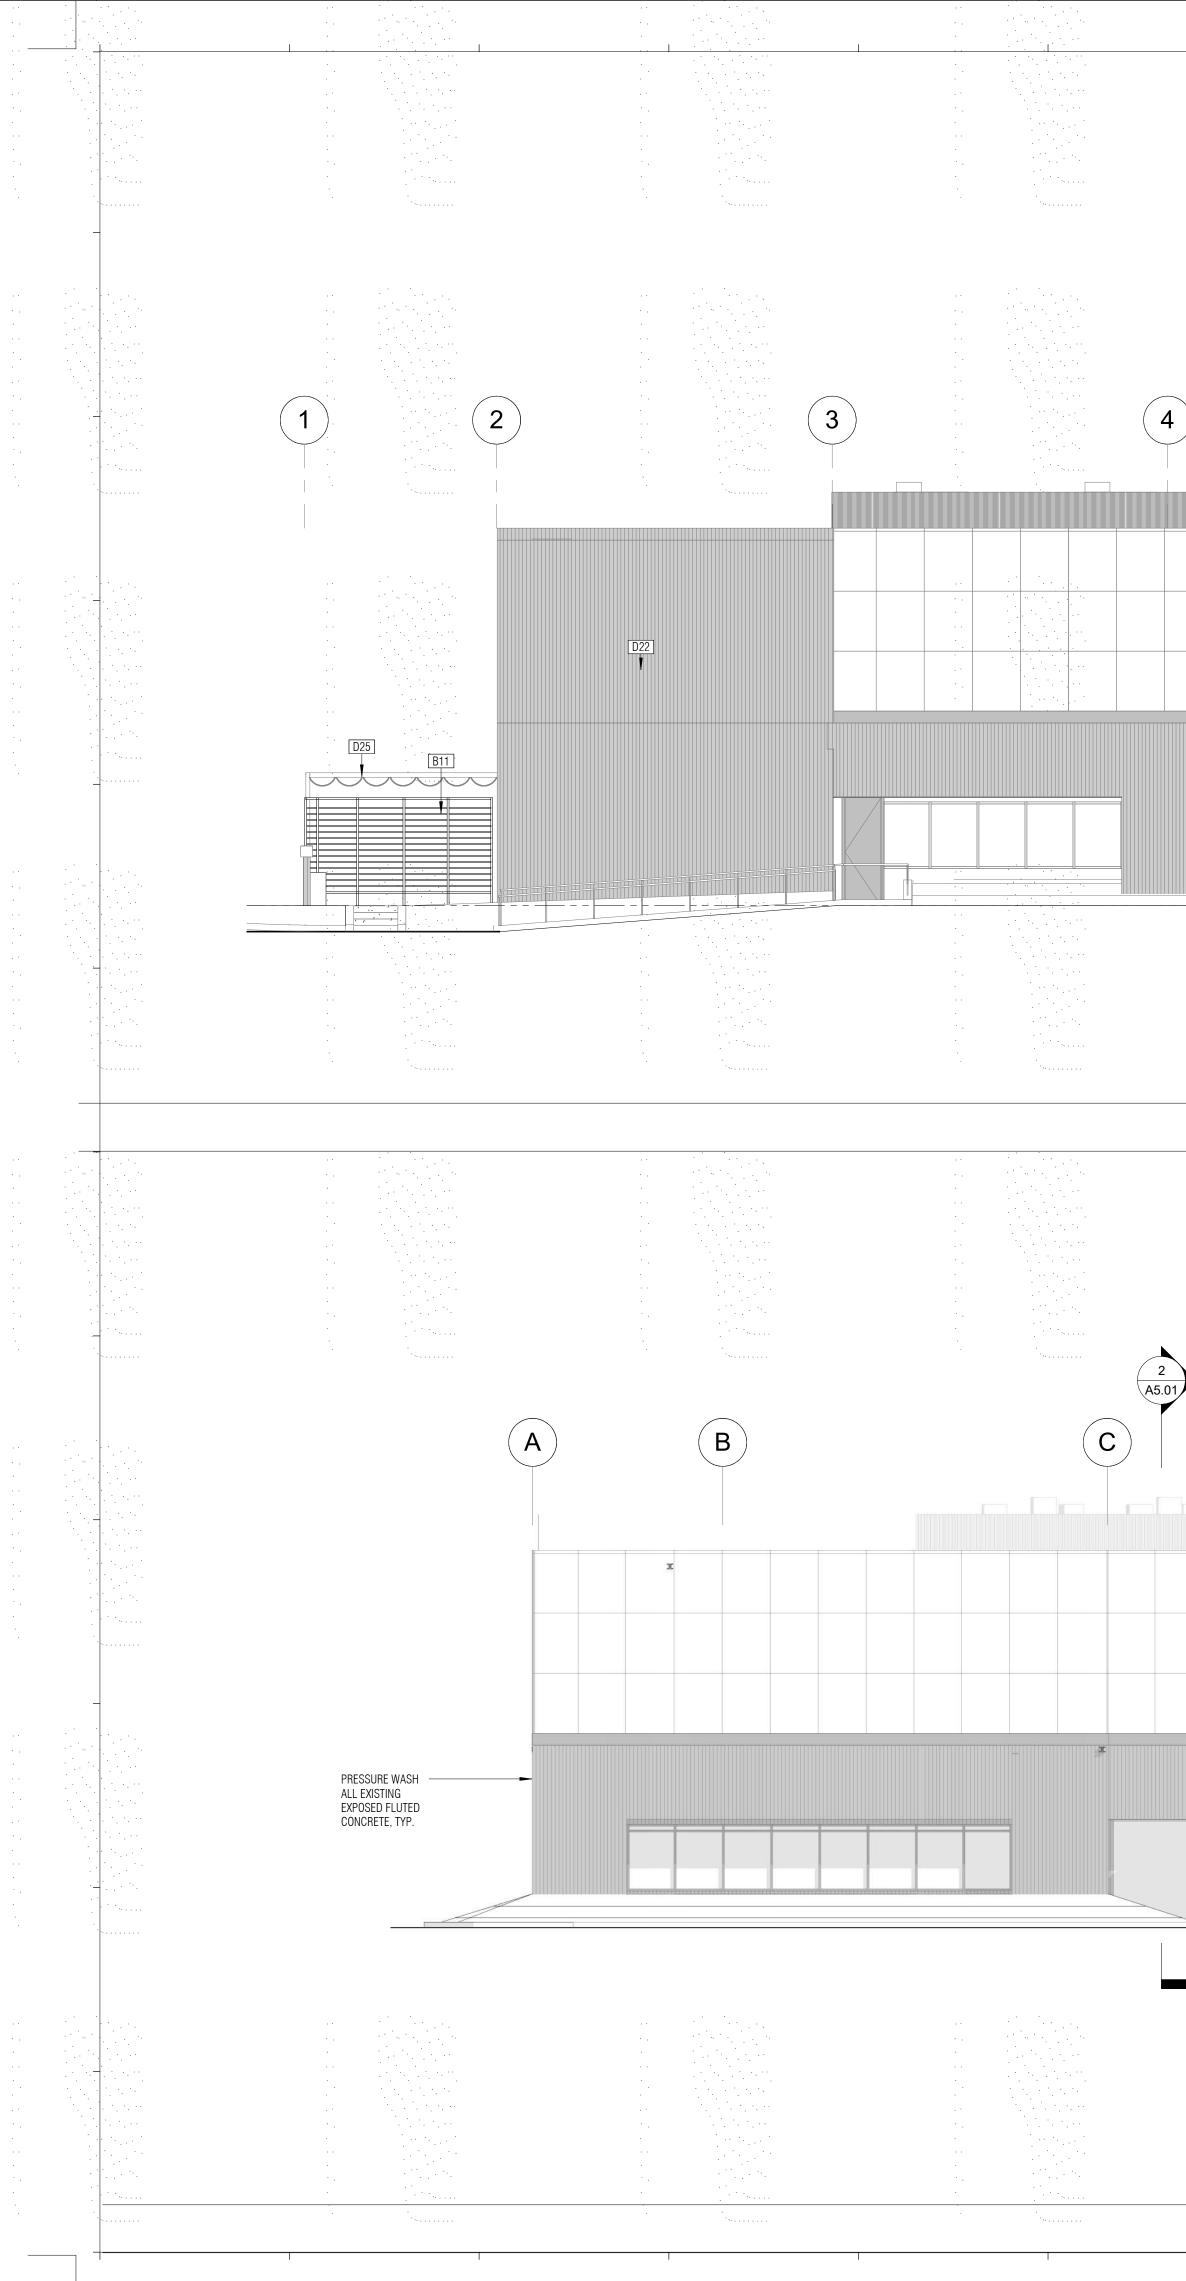


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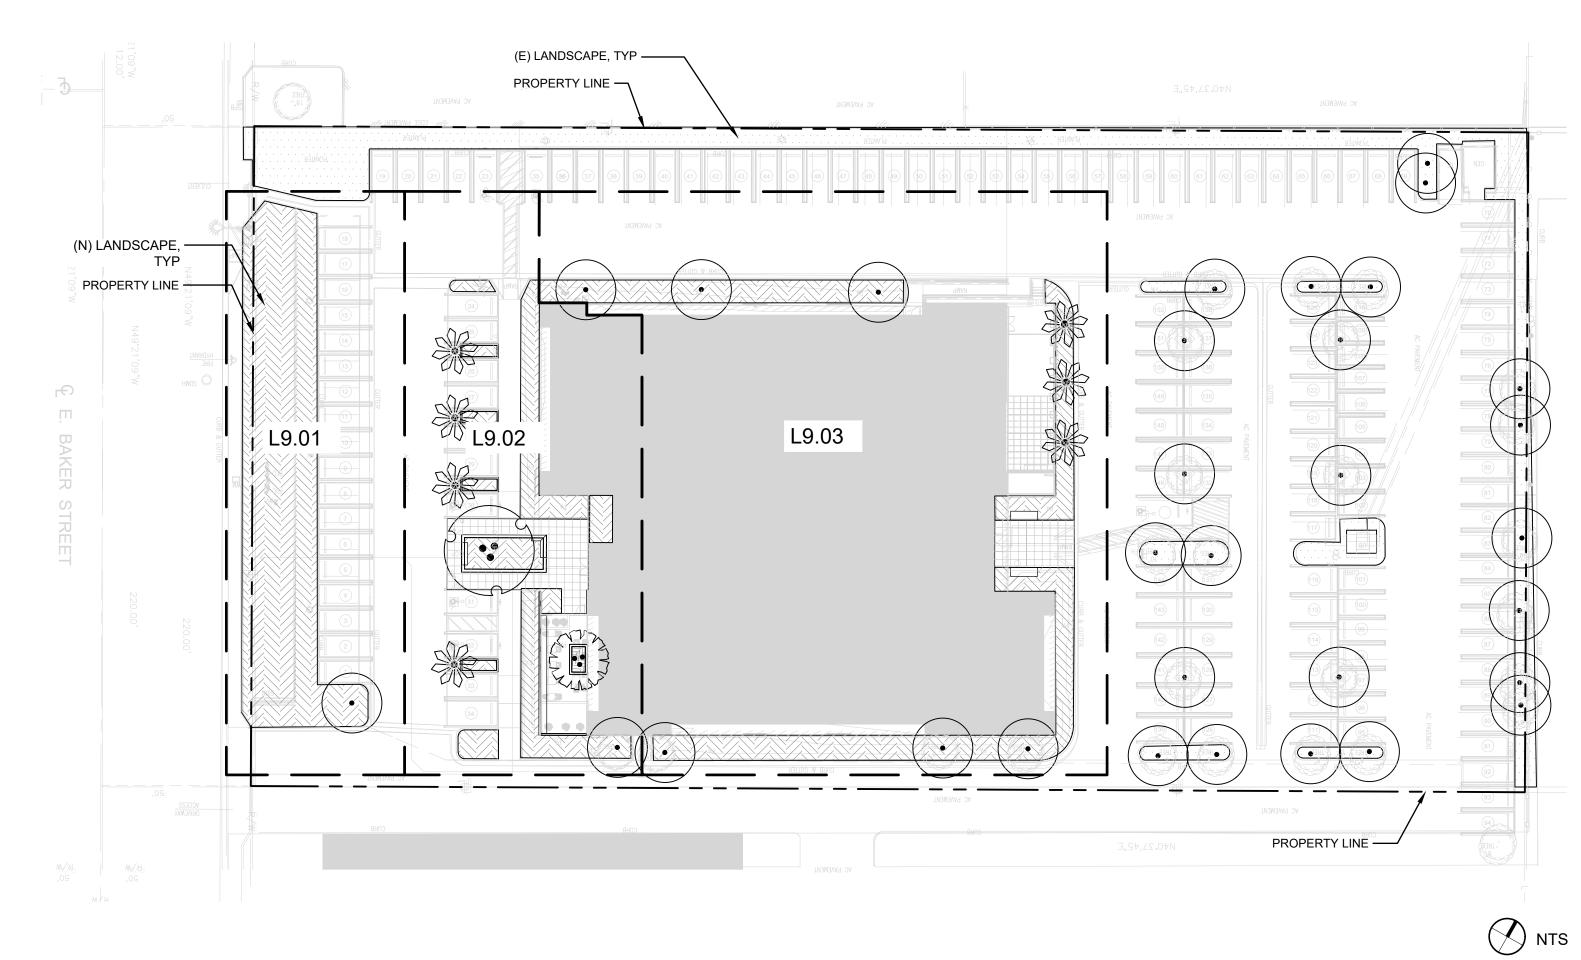


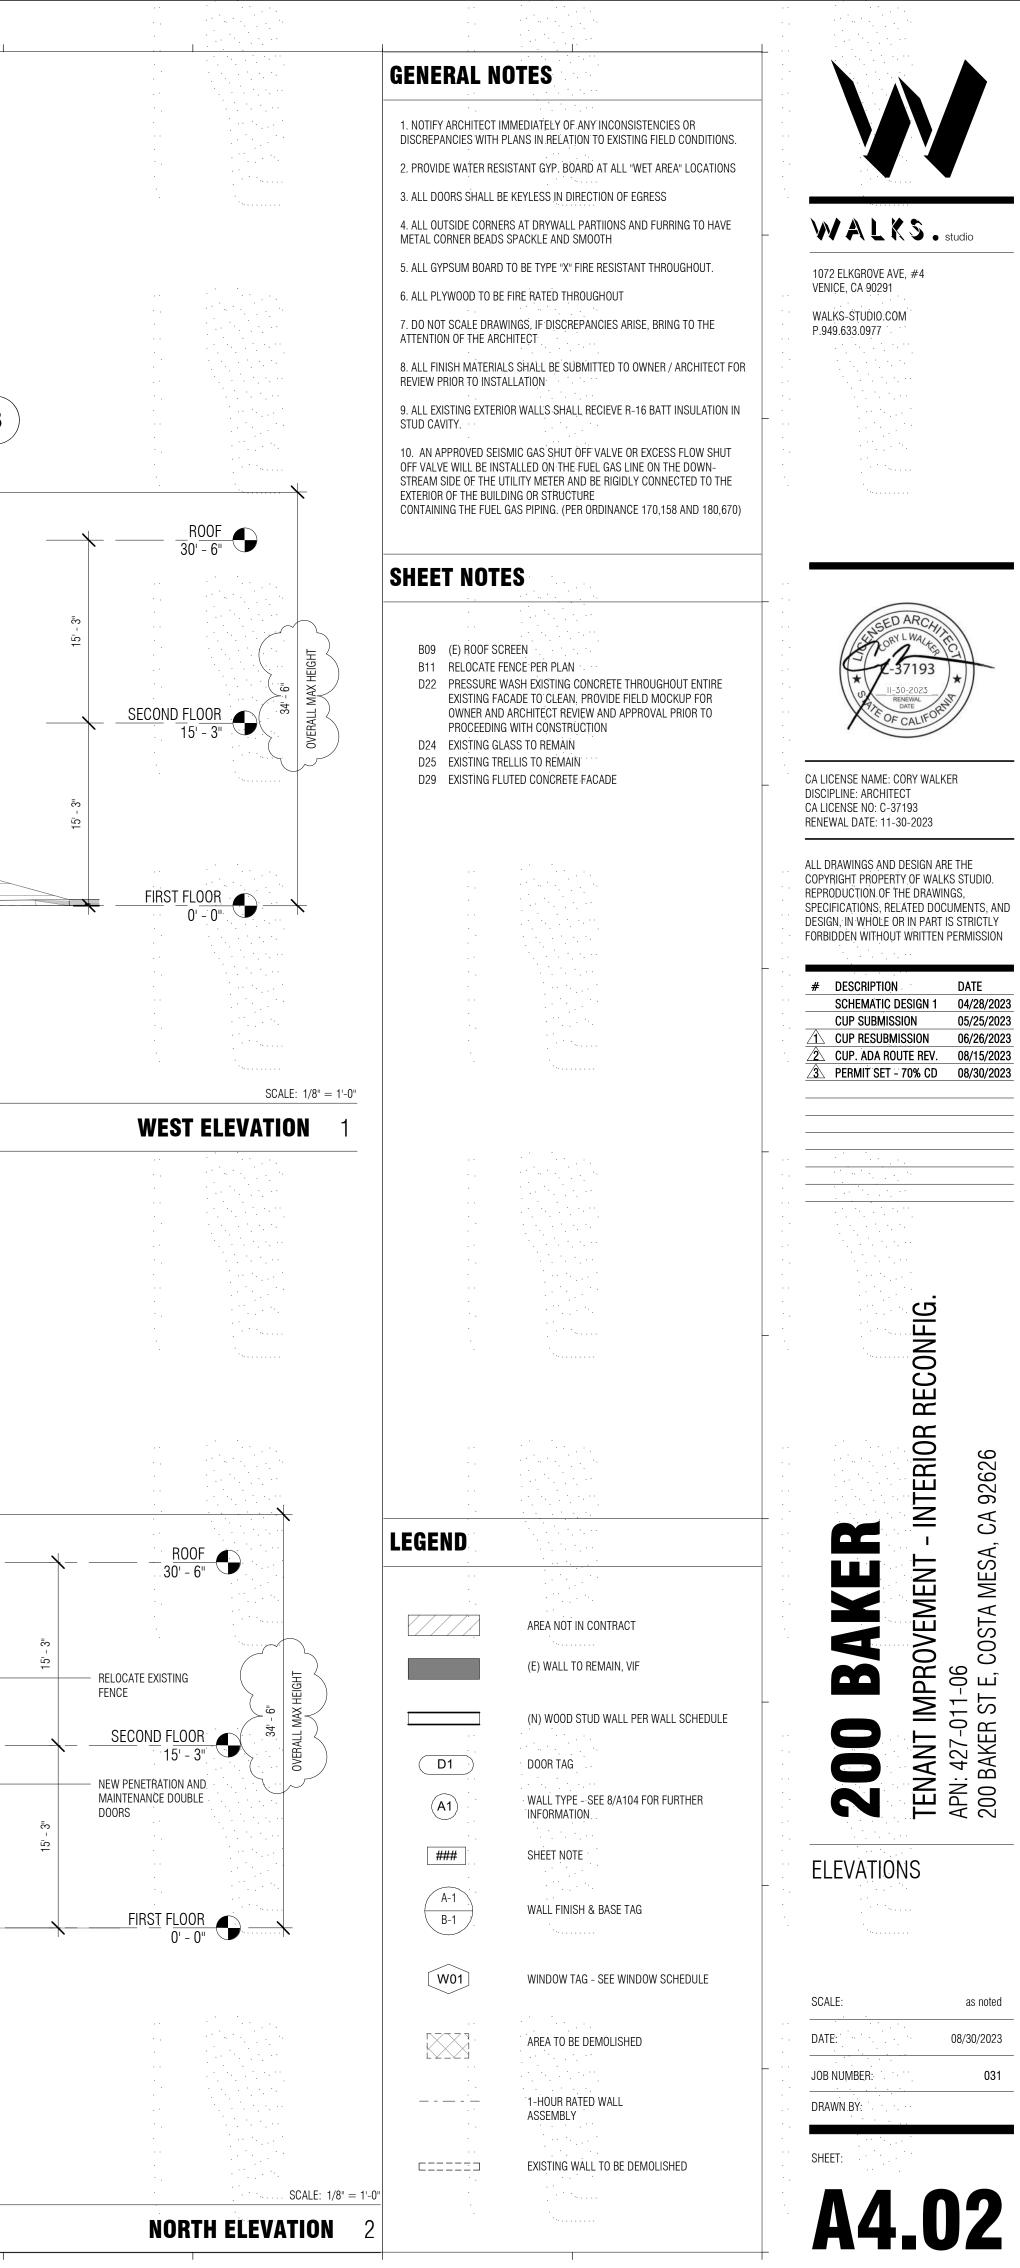
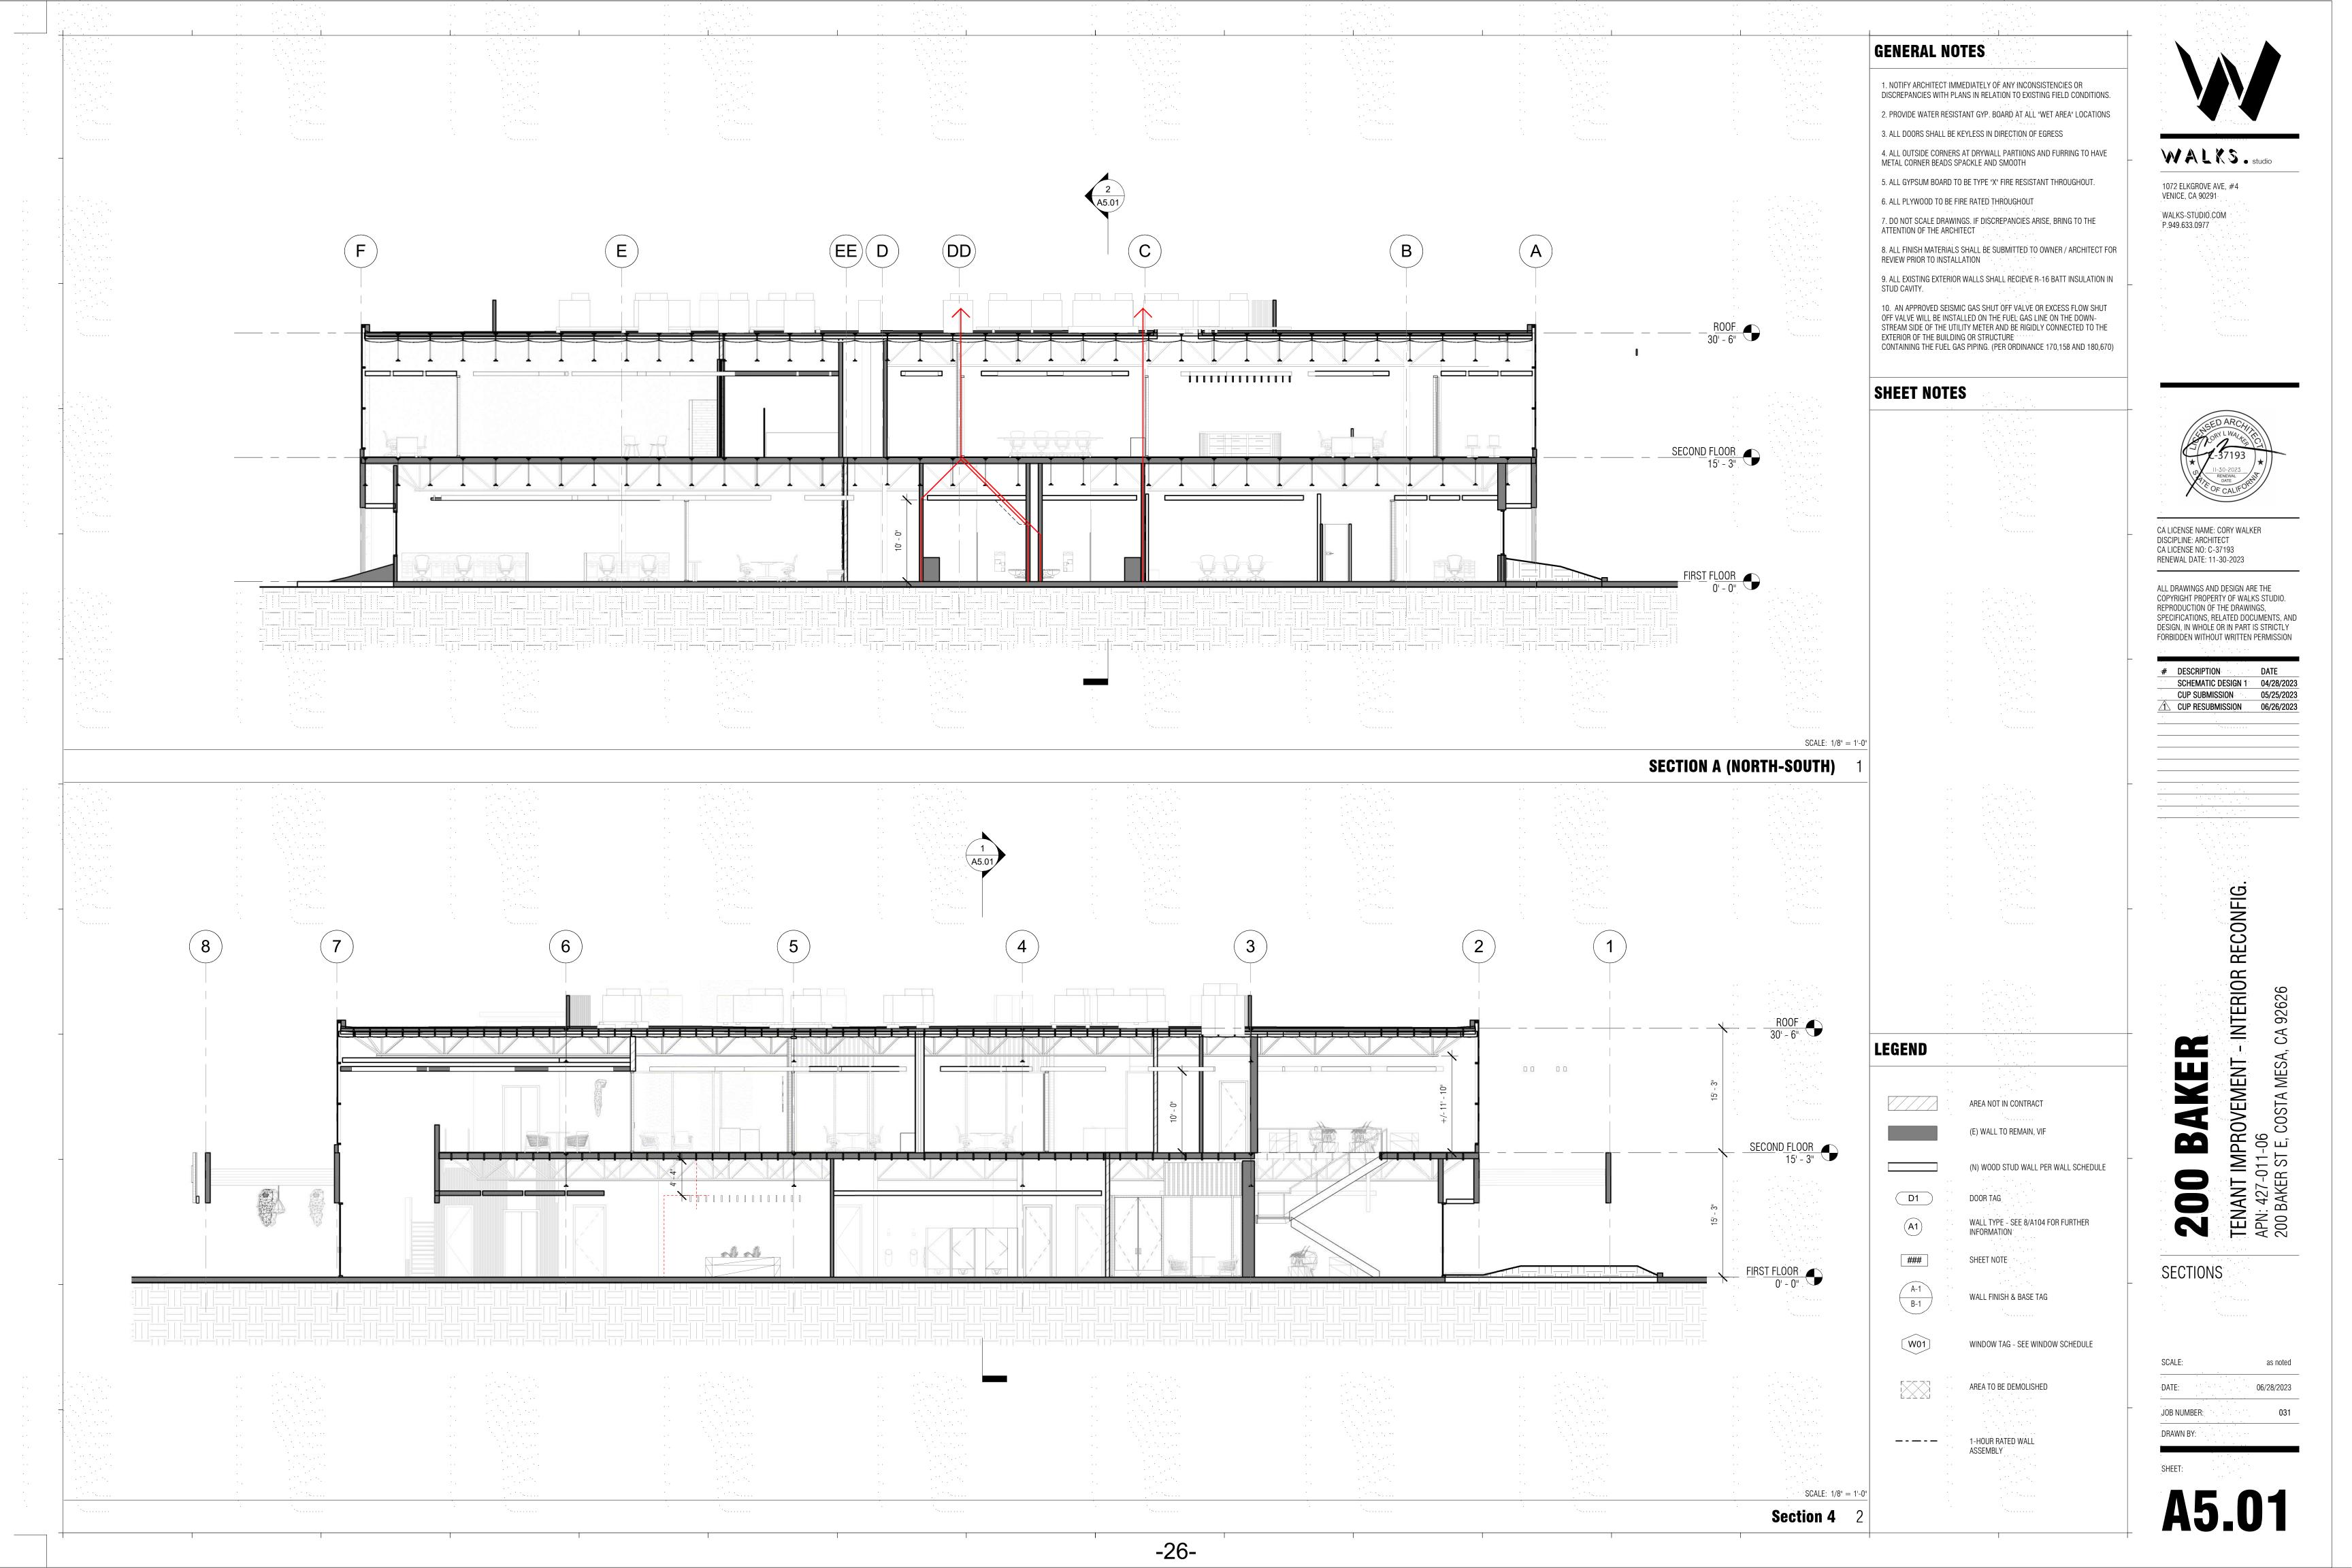
# VICINITY MAP



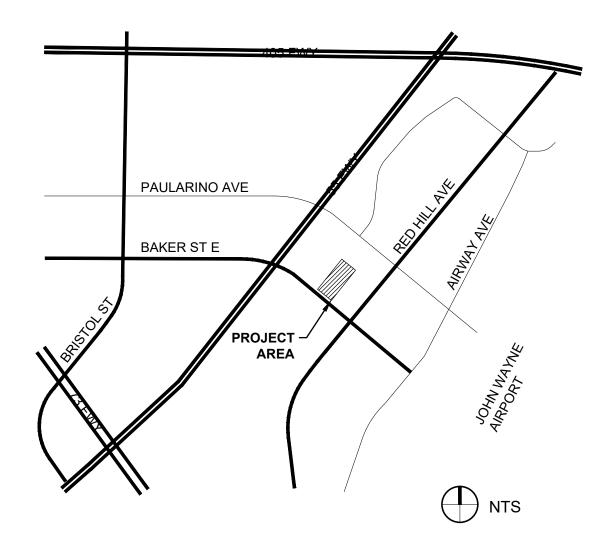





ELEVATION SECTION ENLARGEMENT PLAN DETAIL 

 $f_{\rm F1}$ 

SITE FURNISHINGS

ENLARGEMENT PLAN NUMBER REFERENCE SHEET NUMBER REFERENCE DETAIL NUMBER REFERENCE

SHEET NUMBER REFERENCE

ELEVATION NUMBER REFERENCE

SHEET NUMBER REFERENCE

SECTION NUMBER REFERENCE

SHEET NUMBER REFERENCE

SITE FURNISHING QUANTITY REFERENCE KEY NUMBER

# PROJECT DATA

**PROJECT DESCRIPTION:** PARTIAL RENOVATED LANDSCAPE AT A CREATIVE CAMPUS IN THE CITY OF COSTA MESA IN THE COUNTY OF ORANGE, CALIFORNIA

LEGAL DESCRIPTION: APN: 427-011-06 ZONING: MP - Industrial Park

CLIENT: Hilco Development Services

SITE ADDRESS: 200 BAKER STREET EAST COSTA MESA, CA 92626

SCOPE OF WORK: LANDSCAPE: YES IRRIGATION: YES

# PROJECT DATA CONT.

- CODES AND STANDARDS:
- 2022 CMC
- 2022 CPC
- 2022 CEC
- 2022 CGBSC
- STANDARDS

JURISDICTION: City of Costa Mesa County of Orange

State of California

• 2022 CALIFORNIA BUILDING CODE

• 2022 CA BUILDING ENERGY EFFICIENCY

 AMERICANS WITH DISABILITIES ACT • CITY OF COSTA MESA MUNICIPAL CODES AND SPECIFICATIONS

		LANDSCAPE ARCHITEC AND UNLESS THE REPR ALL DESIGN AND OTHEI THE SPECIFIC PROJECT WRITTEN DIMENSIONS CONTRACTORS SHALL CONDITIONS ON THE L CONDITIONS ON THE EXISTING CONDITIONS. INDEPENDENTLY. IT SH. BEGINNING WORK TO D EXISTING UTILITIES. TH	WINSTRUMENT OF SERVICE, IS THE PROPERTY OF THE CT AND MAY NOT BE REPRODUCED WITHOUT PERMISSION PRODUCTION CARRIES THE LANDSCAPE ARCHITECT'S NAME. ER INFORMATION SHOWN ON THE DRAWING ARE FOR USE ON CT ONLY AND SHALL NOT BE USED OTHERWISE WITHOUT THE IFROM THE LANDSCAPE ARCHITECT. S SHALL HAVE PRECEDENCE OVER SCALED DIMENSIONS. L. VERIFY AND BE RESPONSIBLE FOR ALL DIMENSIONS AND NOB AND THE LANDSCAPE ARCHITECT IS INFORMED OF ANY E DIMENSIONS AND CONDITIONS SHOWN ON THE DRAWING. S AND LOCATIONS OF UTILITIES HAVE NOT BEEN VERIFIED HALL BE THE RESPONSIBILITY OF THE CONTRACTOR BEFORE DETERMINE THE EXACT LOCATION OF ALL EASEMENTS AND HE CONTRACTOR SHALL BE RESPONSIBLE FOR SECURING ALL
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			D BAKER CUP RESUMUSION CUP RESUMUSION L IMPROVEMENT - INTERIOR RECONFIG.
DRAWING INDEX 2023-01-11 9:57 SHEET DESCRIPTION L0.00 COVER SHEET L8.00 PLANTING SCHEDULE L9.01 PLANTING PLAN L9.02 PLANTING PLAN L9.03 PLANTING PLAN	Image: Arrow of the contract of	<b>JRE</b> 91103	COVER SHEET SCALE: DATE: 06 JOB NUMBER: DRAWN BY: SHEET: LOLOLO



Chilopsis linearis 'Hope'



Achillea millefolium 'Terra cotta'



Eriogonum giganteum



Quercus agrifolia



Arctostaphylos x 'Sunset'



Eriogonum parvifolium



Baccharis pilularis 'Pigeon Point'



Lepechinia fragrans



Salvia mellifera 'Terra Seca'



Woodwardia fimbriata



Heuchera maxima




Carex tumilcola



Penstemon 'Margarita BOP'



Sporobolus airoides

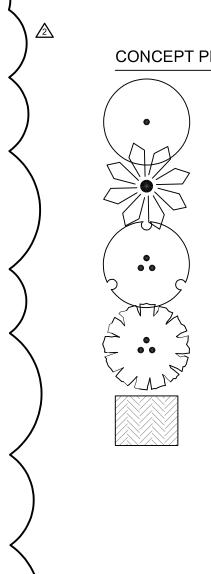

CONCEPT PLANT SCHEDULE SITE PLAN

EXISTING TREES TO REMAIN

EXISTING PALMS

(N) QUERCUS AGRIFOLIA 96" BOX

(N) CHILOPSIS LINEARIS 36" BOX

(N) SAGE SCRUB UNDERSTORY Example Species: Ceanothus griseus horizontalis 'Yankee Point' Eriogonum fasciculatum 'Theodore Payne' Muhlenbergia rigens Muhlenbergia dubia Salvia apiana Salvia 'Bee's Bliss'

(E) SHRUB AND GROUDCOVER



 PLANT COUNT

 for 9,767 sf of New Landscape

 Category
 Existing Amount to Remain

 Trees
 33
 31

391

min. 70%

Ceanothus 'Yankee Point'

Salvia clevelandii 'Allen Chickering'

Elymus condensatus 'Canyon Prince'



Calystegia macrostegia 'Anacapa Pink'



Shrubs

Groundcover

Muhlenbergia dubia




Approx 60


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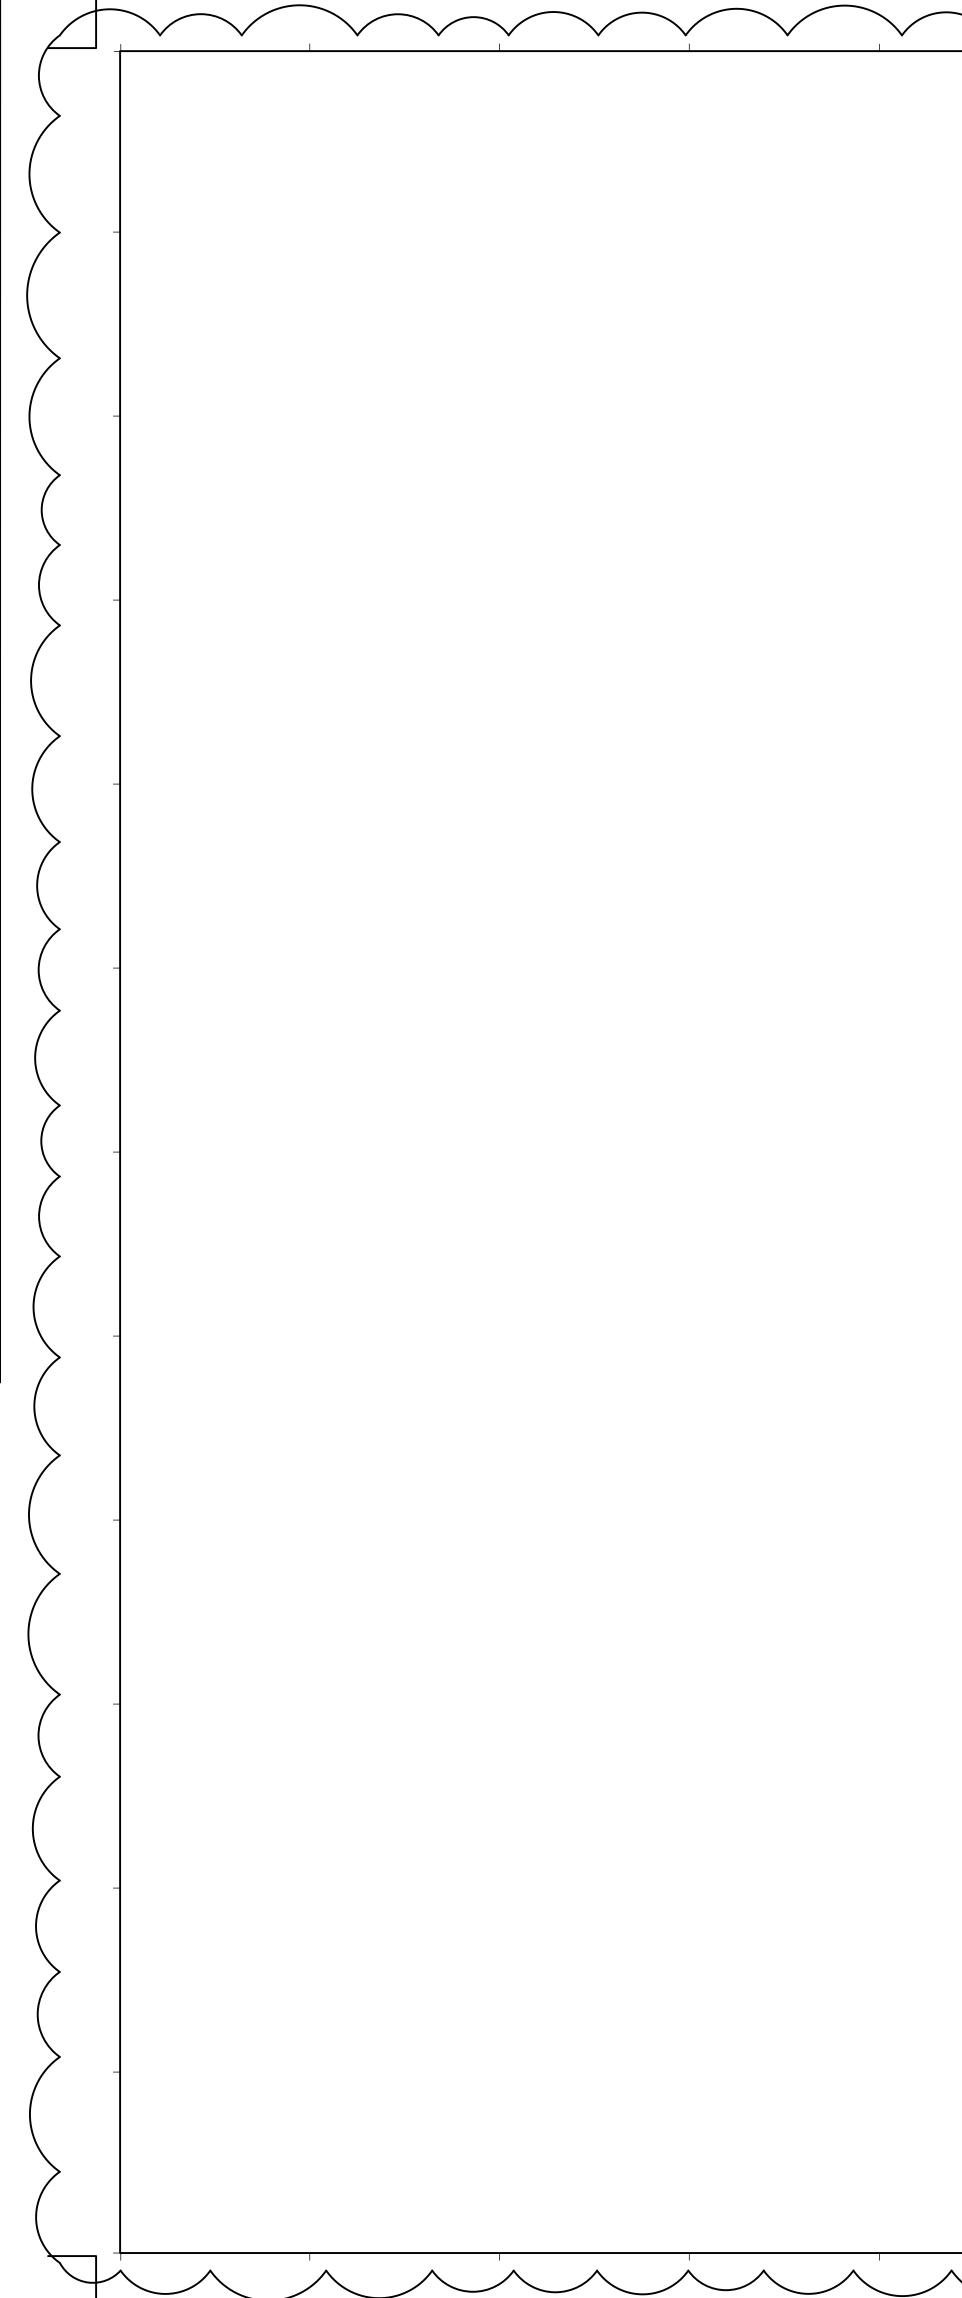
Muhlenbergia rigens




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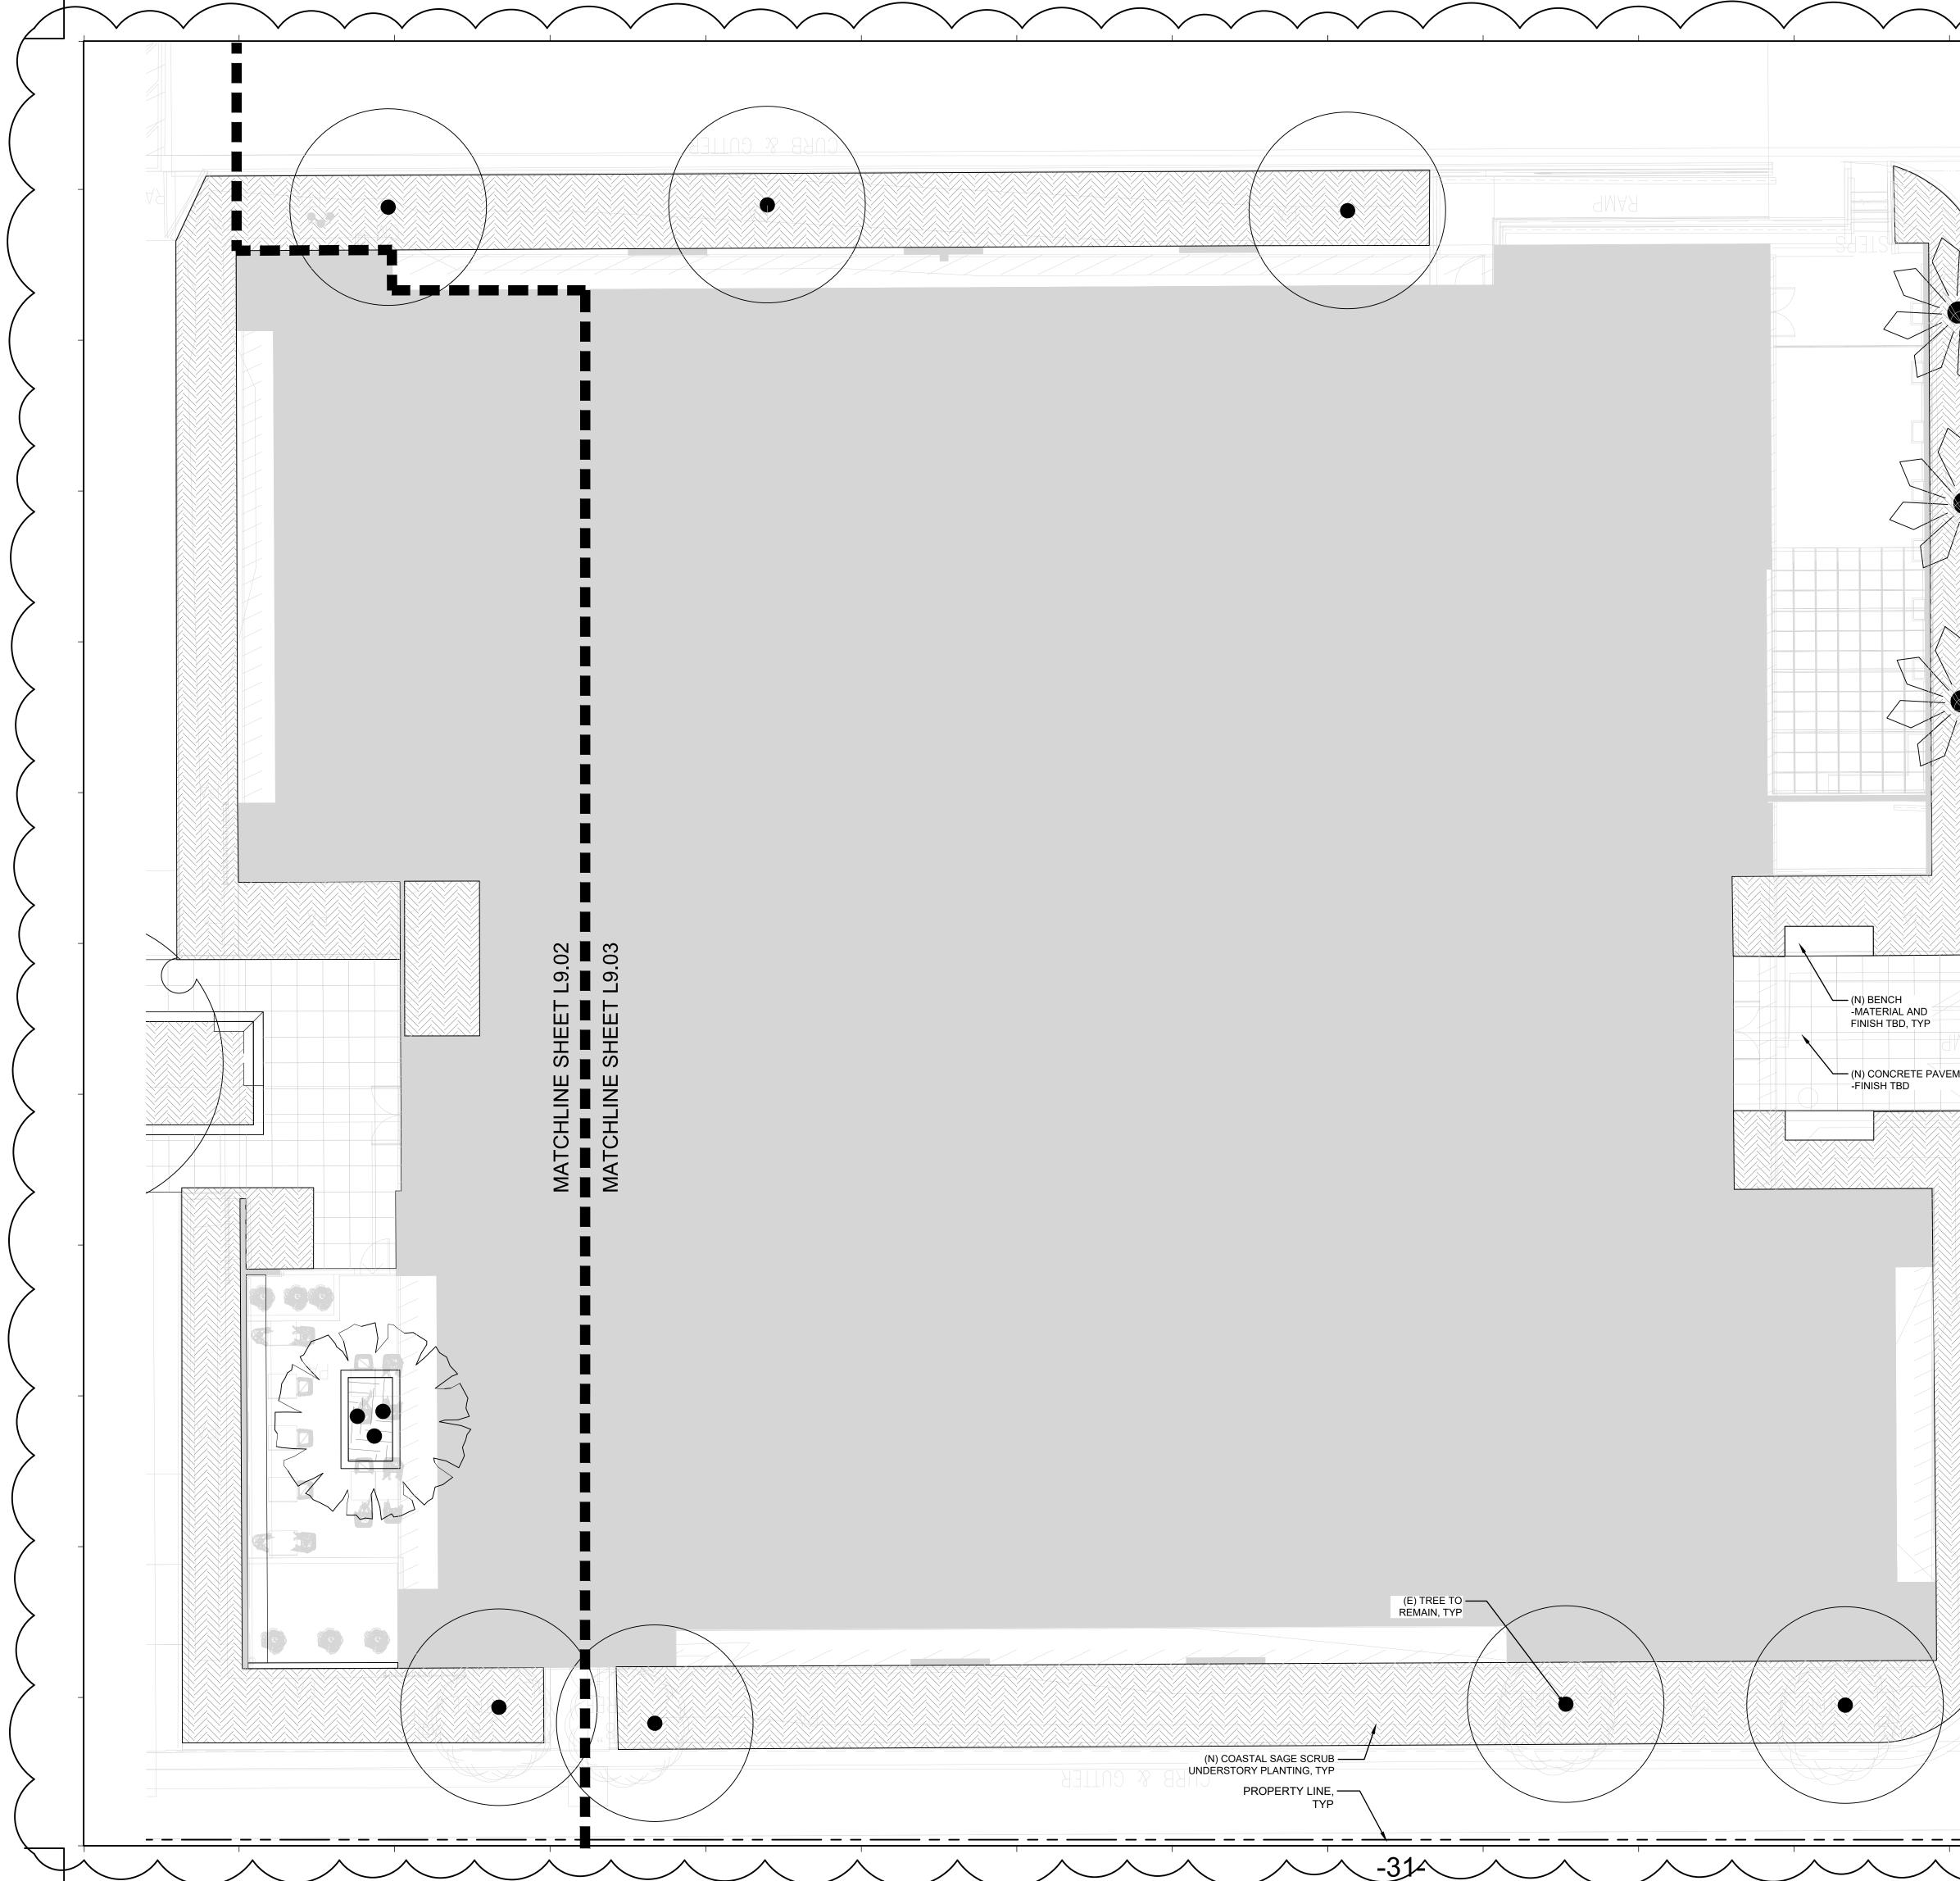




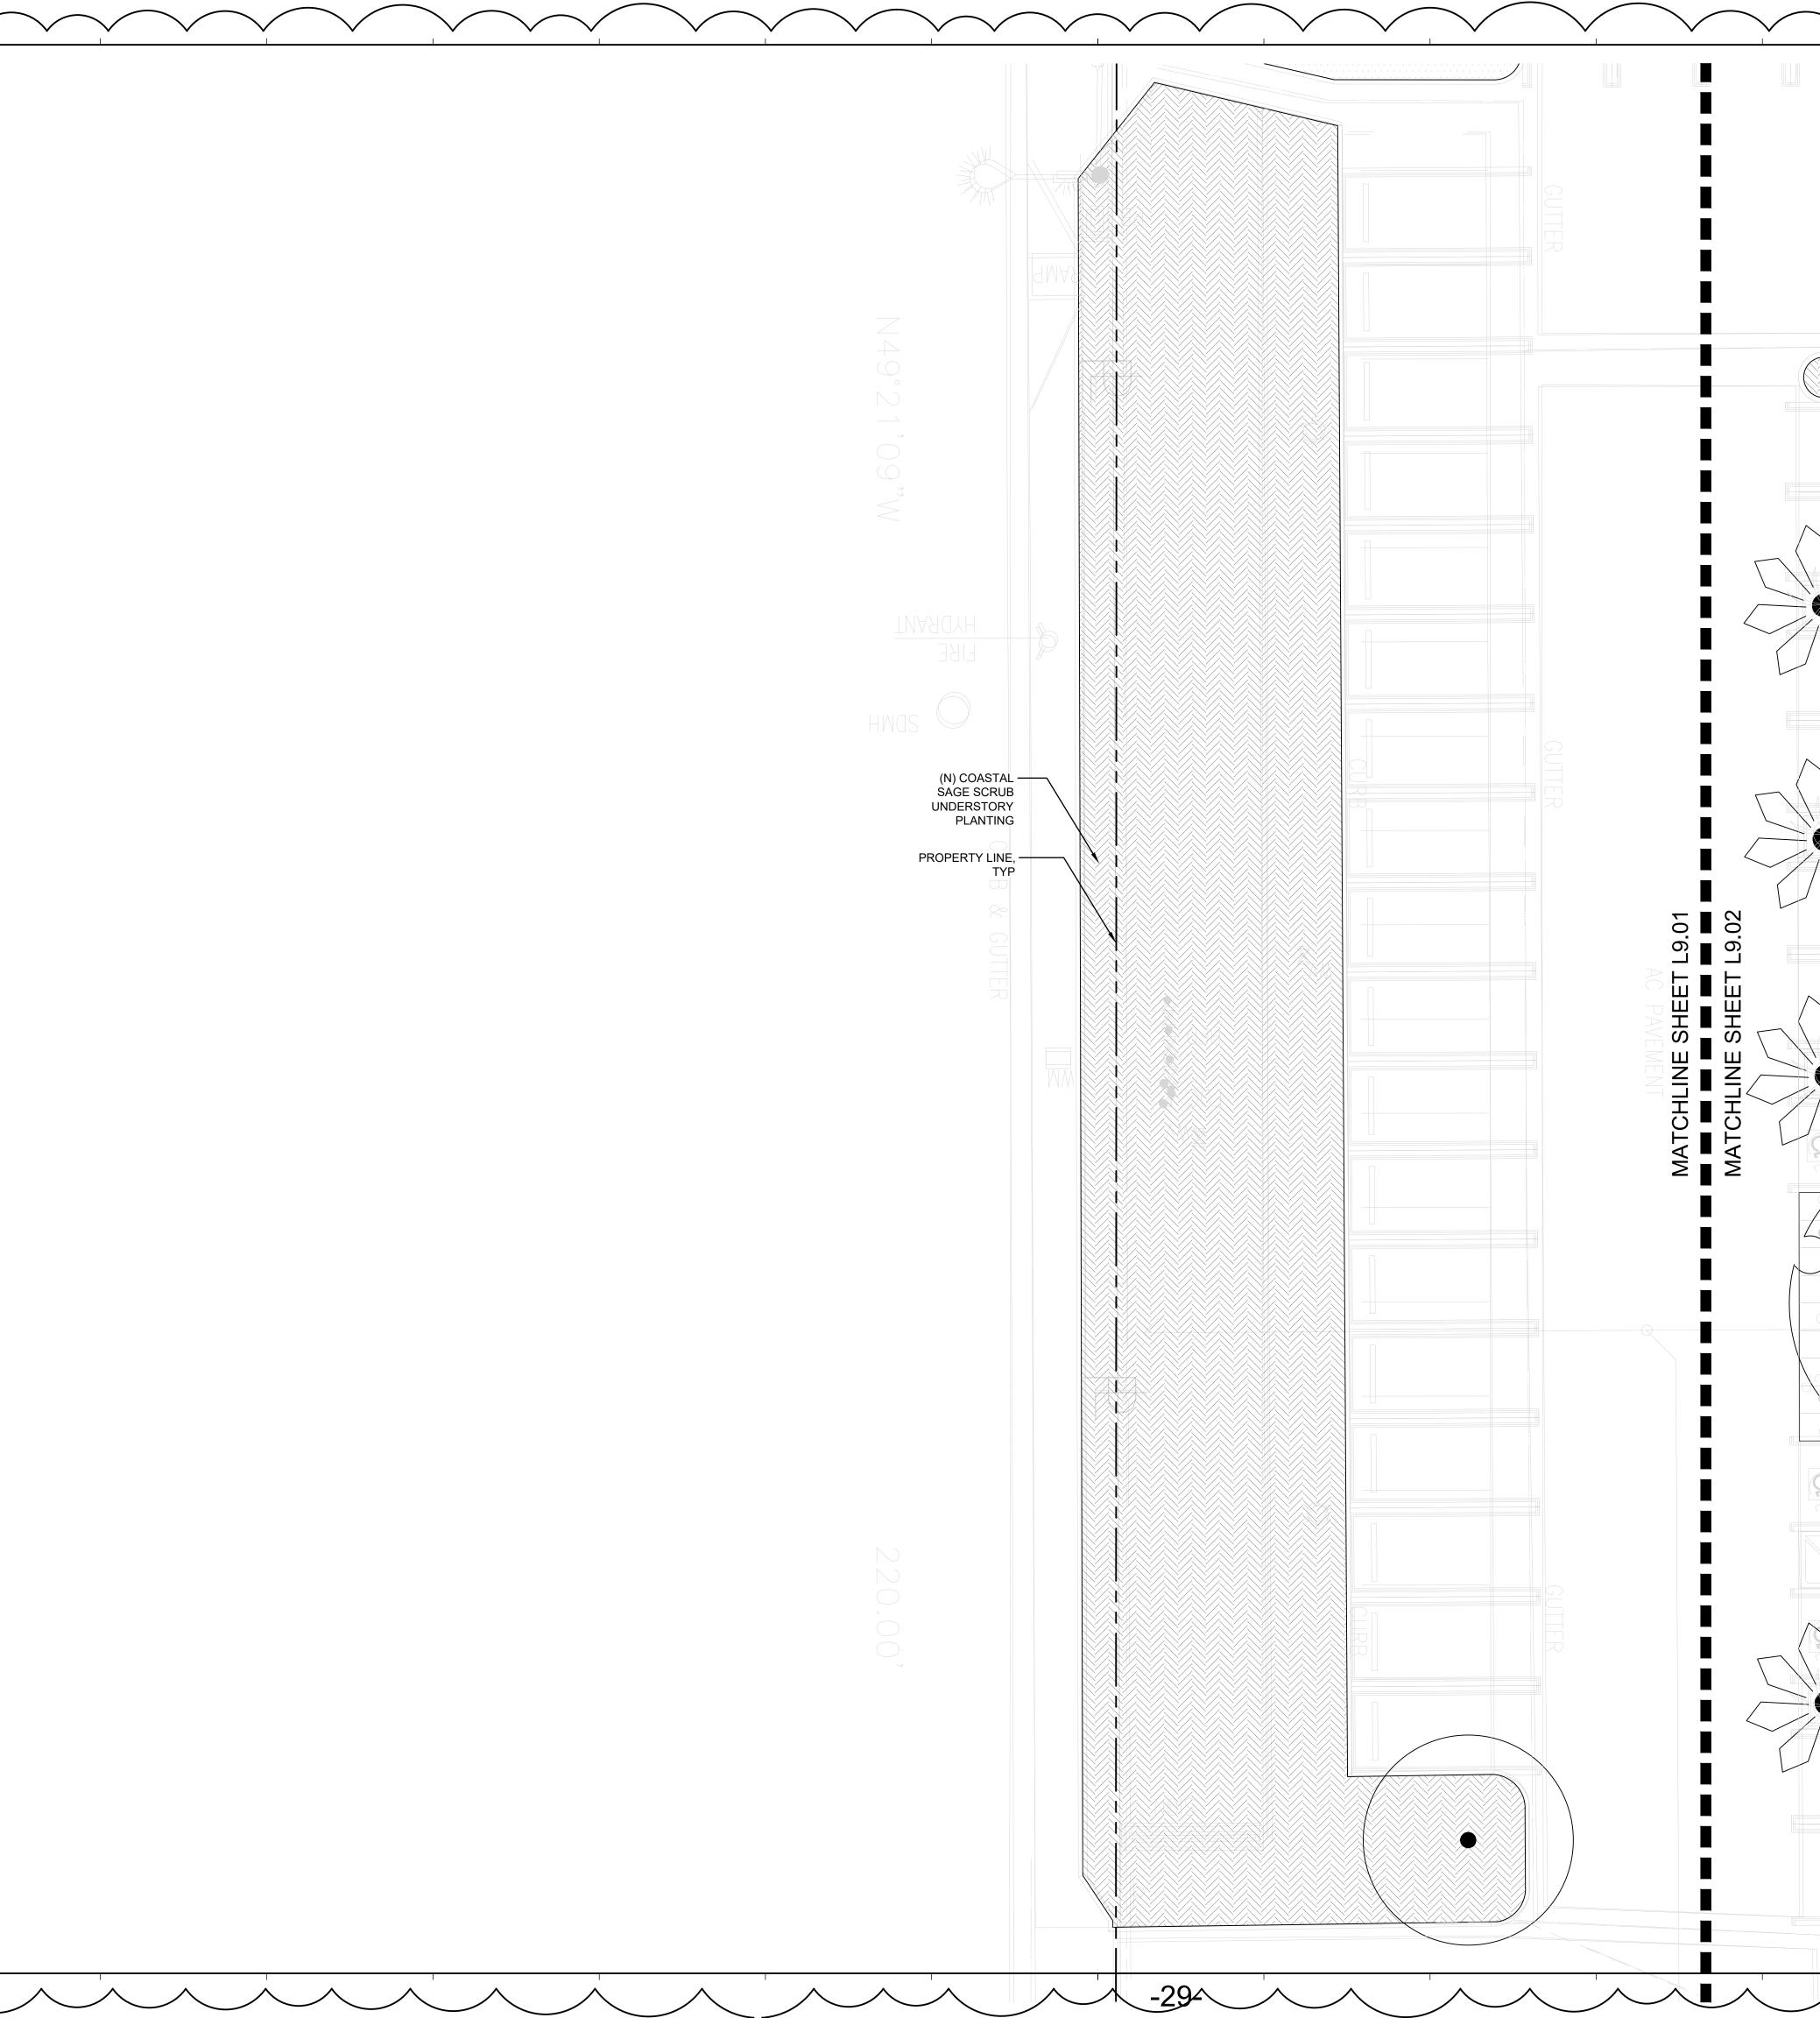

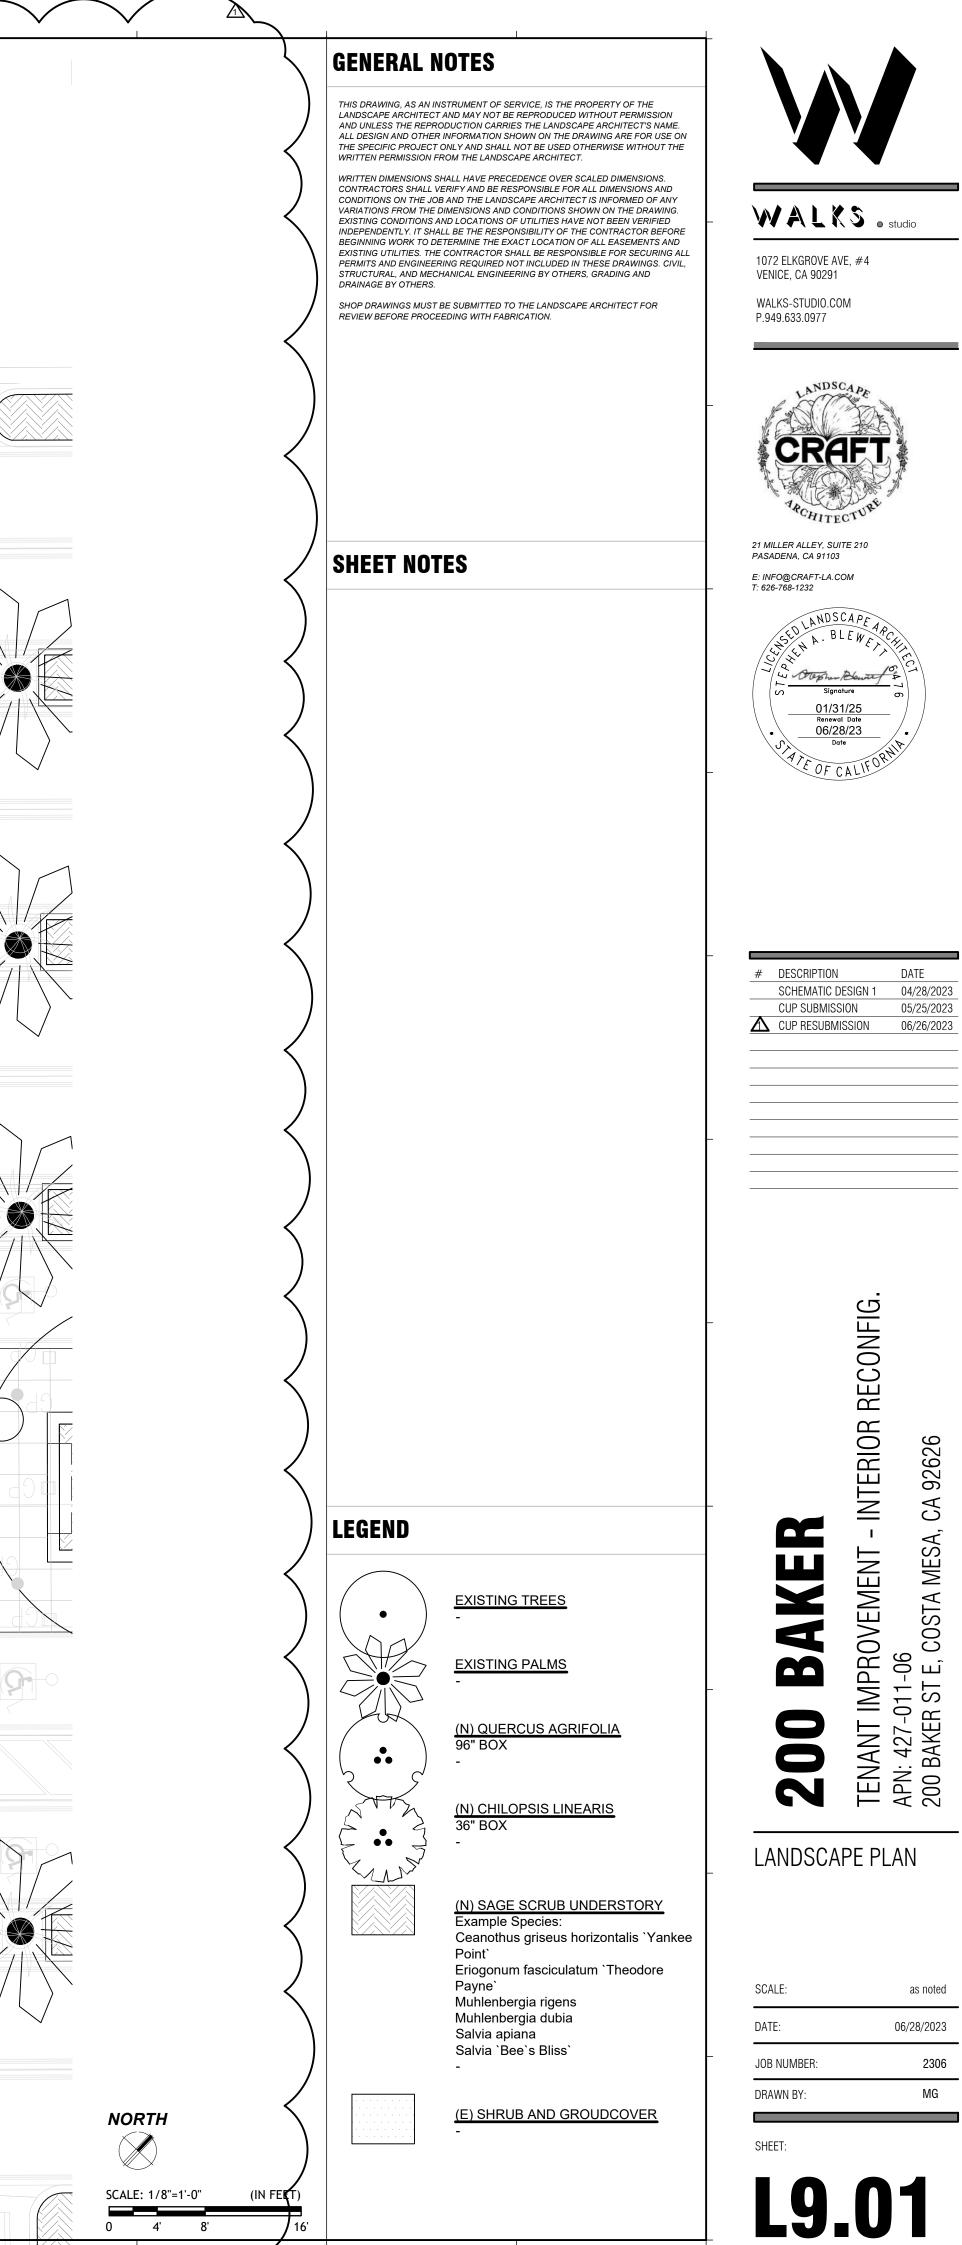
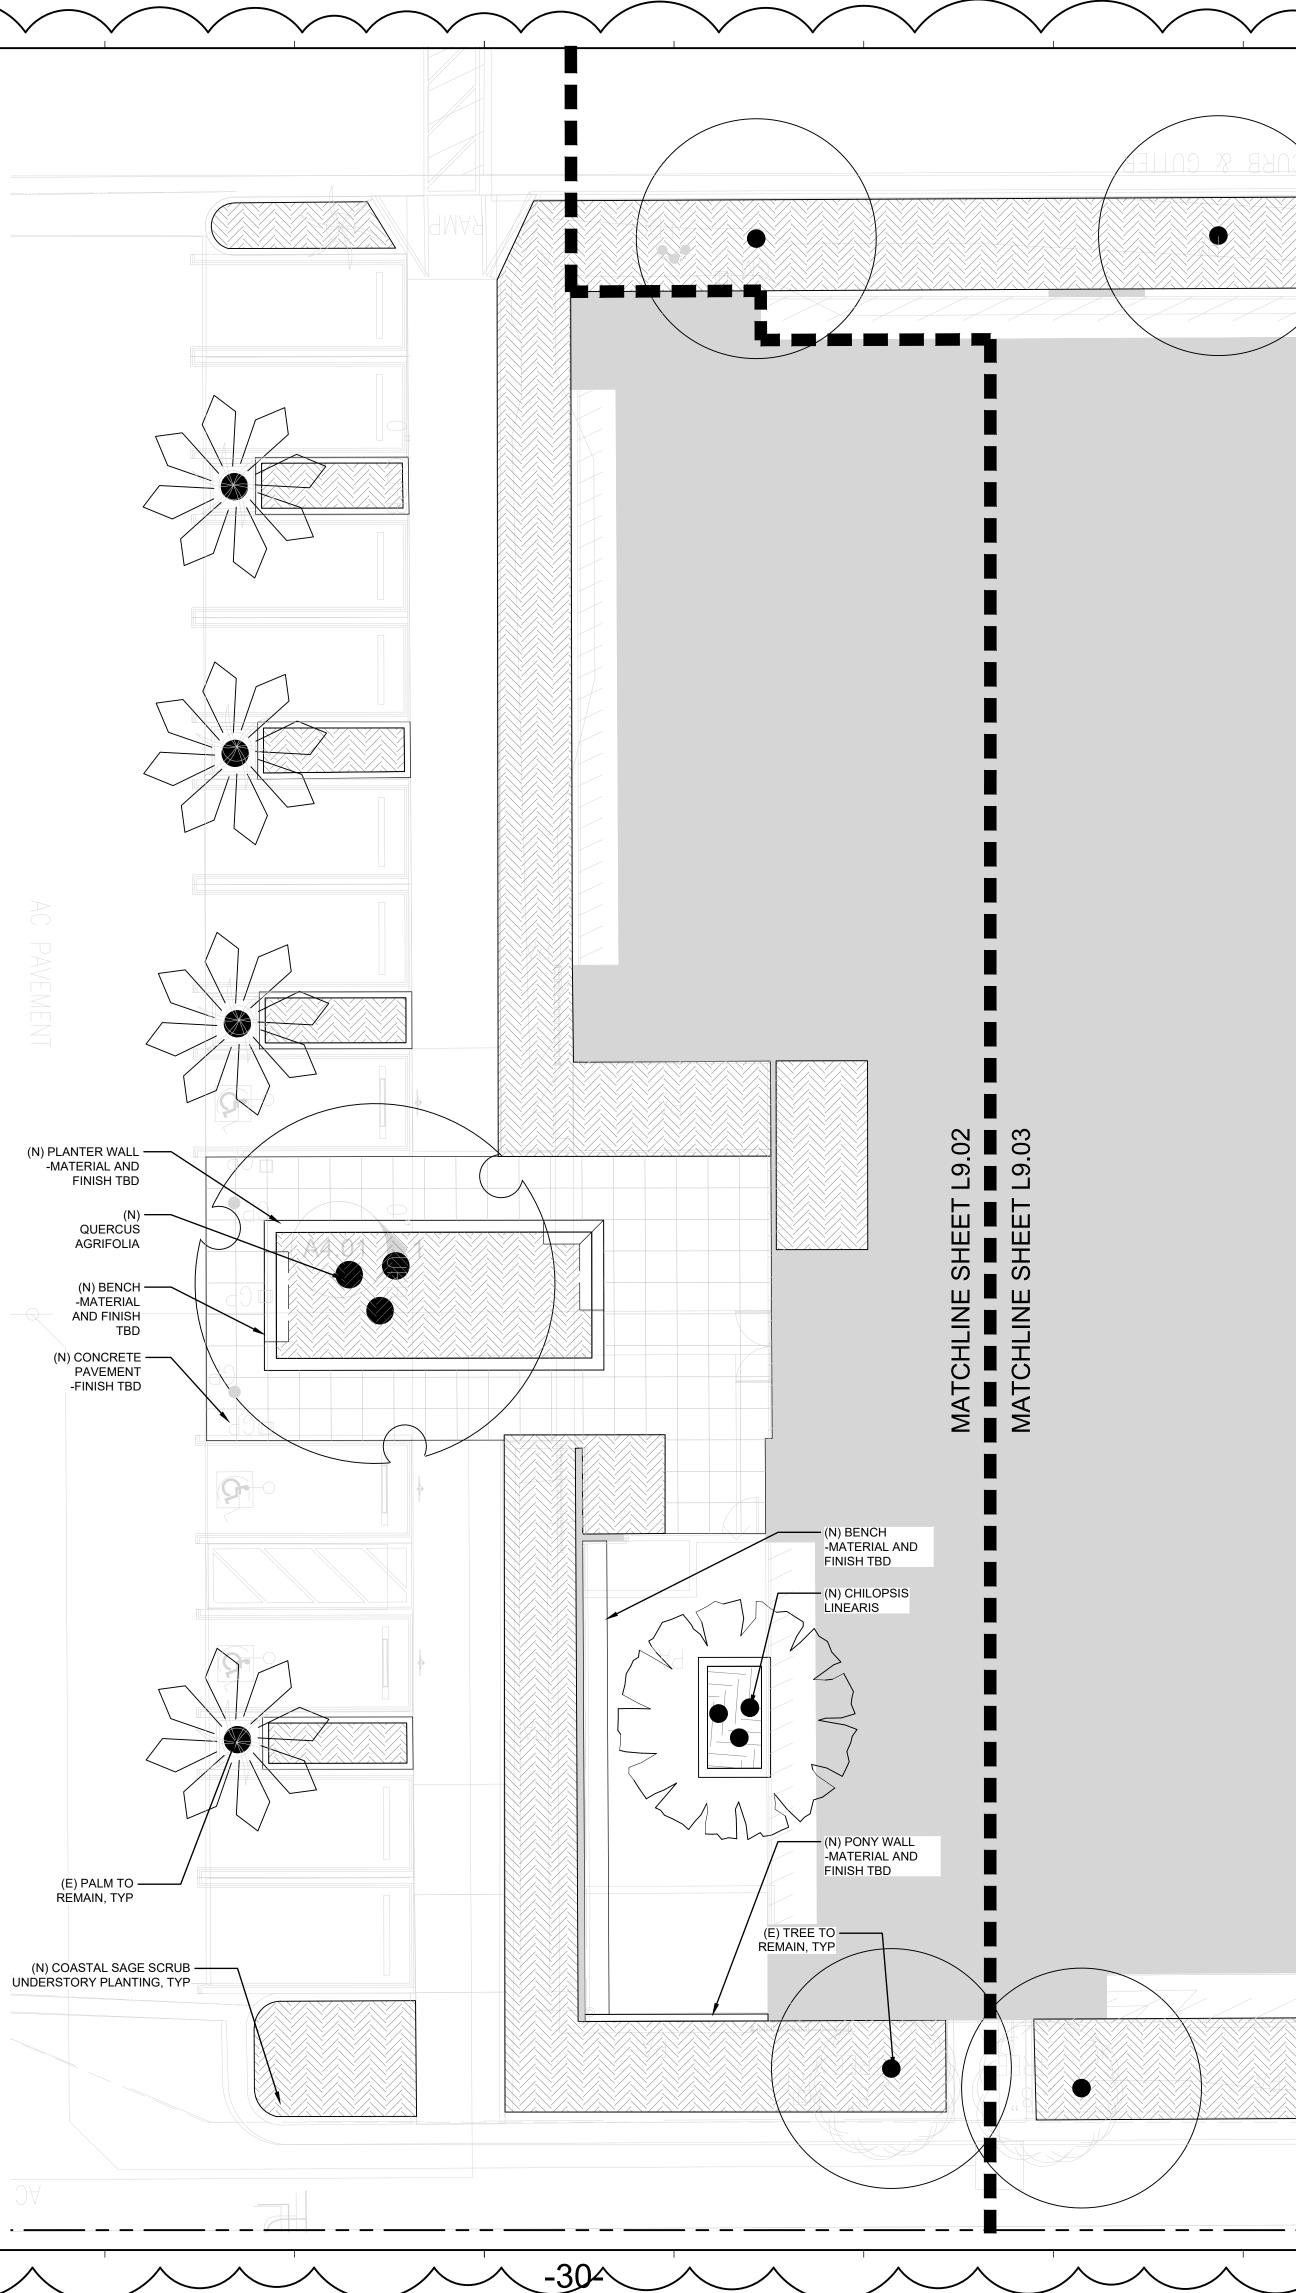
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			BEGINNING WORK TO DE EXISTING UTILITIES. THE	LL BE THE RESPONSIBILITY OF THE CONTRACTOR BEFORE TERMINE THE EXACT LOCATION OF ALL EASEMENTS AND CONTRACTOR SHALL BE RESPONSIBLE FOR SECURING ALL ING REQUIRED NOT INCLUDED IN THESE DRAWINGS. CIVIL,	1072 ELKGROVE	
		)	DRAINAGE BY OTHERS.	IANICAL ENGINEERING BY OTHERS, GRADING AND	VENICE, CA 9029 WALKS-STUDIO.(	
				EDING WITH FABRICATION.	P.949.633.0977	
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			SHEET NOT	ES	PASADENA, CA 9110 E: INFO@CRAFT-LA T: 626-768-1232	
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			SAR.	(N) CHILOPSIS LINEARIS	Ň	TEN APN 200
				36" BOX -		
					LANDSC/	APE PLAN
		2		(N) SAGE SCRUB UNDERSTORY Example Species:		
		)		Ceanothus griseus horizontalis `Yankee Point` Eriogonum fasciculatum `Theodore	5	
		$\langle$		Payne` Muhlenbergia rigens	SCALE:	as noted
				Muhlenbergia dubia Salvia apiana Salvia `Bee`s Bliss`		06/28/2023
				-	JOB NUMBER:	2306  MG
	NORTH	$\leq$		(E) SHRUB AND GROUDCOVER -		
		)			SHEET:	
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	GENERAL NOTES	
	THIS DRAWING, AS AN INSTRUMENT OF SERVICE, IS THE PROPERTY OF THE LANDSCAPE ARCHITECT AND MAY NOT BE REPRODUCED WITHOUT PERMISSION AND UNLESS THE REPRODUCTION CARRIES THE LANDSCAPE ARCHITECT'S NAME. ALL DESIGN AND OTHER INFORMATION SHOWN ON THE DRAWING ARE FOR USE ON THE SPECIFIC PROJECT ONLY AND SHALL NOT BE USED OTHERWISE WITHOUT THE	
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	VARIATIONS FROM THE DIMENSIONS AND CONDITIONS SHOWN ON THE DRAWING. EXISTING CONDITIONS AND LOCATIONS OF UTILITIES HAVE NOT BEEN VERIFIED INDEPENDENTLY. IT SHALL BE THE RESPONSIBILITY OF THE CONTRACTOR BEFORE BEGINNING WORK TO DETERMINE THE EXACT LOCATION OF ALL EASEMENTS AND EXISTING UTILITIES. THE CONTRACTOR SHALL BE RESPONSIBLE FOR SECURING ALL	WALKS • studio
	PERMITS AND ENGINEERING REQUIRED NOT INCLUDED IN THESE DRAWINGS. CIVIL, STRUCTURAL, AND MECHANICAL ENGINEERING BY OTHERS, GRADING AND DRAINAGE BY OTHERS. SHOP DRAWINGS MUST BE SUBMITTED TO THE LANDSCAPE ARCHITECT FOR	1072 ELKGROVE AVE, #4 VENICE, CA 90291 WALKS-STUDIO.COM
	REVIEW BEFORE PROCEEDING WITH FABRICATION.	P.949.633.0977
	-	LANDSCAPE
		CRAFT
		ARCHITECTURE
	SHEET NOTES	21 MILLER ALLEY, SUITE 210 PASADENA, CA 91103 E: INFO@CRAFT-LA.COM
		T: 626-768-1232
		Ster A. BLEWENCH
		<ul> <li>✓ Signature σ</li> <li><u>01/31/25</u></li> <li>Renewal Date</li> <li><u>06/28/23</u></li> </ul>
	-	Date Date DF CALIFORNIA
(E) PALM TO REMAIN, TYP		
		#DESCRIPTIONDATESCHEMATIC DESIGN 104/28/2023CUP SUBMISSION05/25/2023
		CUP RESUBMISSION 06/26/2023
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		A 9262
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	EXISTING TREES	
	EXISTING PALMS	ROVI 6 6 COS
	(N) QUERCUS AGRIFOLIA	<b>200 BAKER</b> TENANT IMPROVEMENT - INTERIOR RECONFIG. APN: 427-011-06 200 BAKER ST E, COSTA MESA, CA 92626
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	(N) CHILOPSIS LINEARIS 36" BOX	SPE L
		LANDSCAPE PLAN
	(N) SAGE SCRUB UNDERSTORY Example Species: Ceanothus griseus horizontalis `Yankee Point`	
	Point Eriogonum fasciculatum `Theodore Payne` Muhlenbergia rigens	SCALE: as noted
	Muhlenbergia dubia Salvia apiana Salvia `Bee`s Bliss`	DATE: 06/28/2023
	- (E) SHRUB AND GROUDCOVER	JOB NUMBER: 2306 DRAWN BY: MG
NORTH		SHEET:
SCALE: 1/8"=1'-0" (IN FEET)		L9.03