# ATTACHMENT 6


16,344.75 SF .375 SF ACRES

.20 .445

0 %

7,227 SF

12 STALLS 11 STALLS

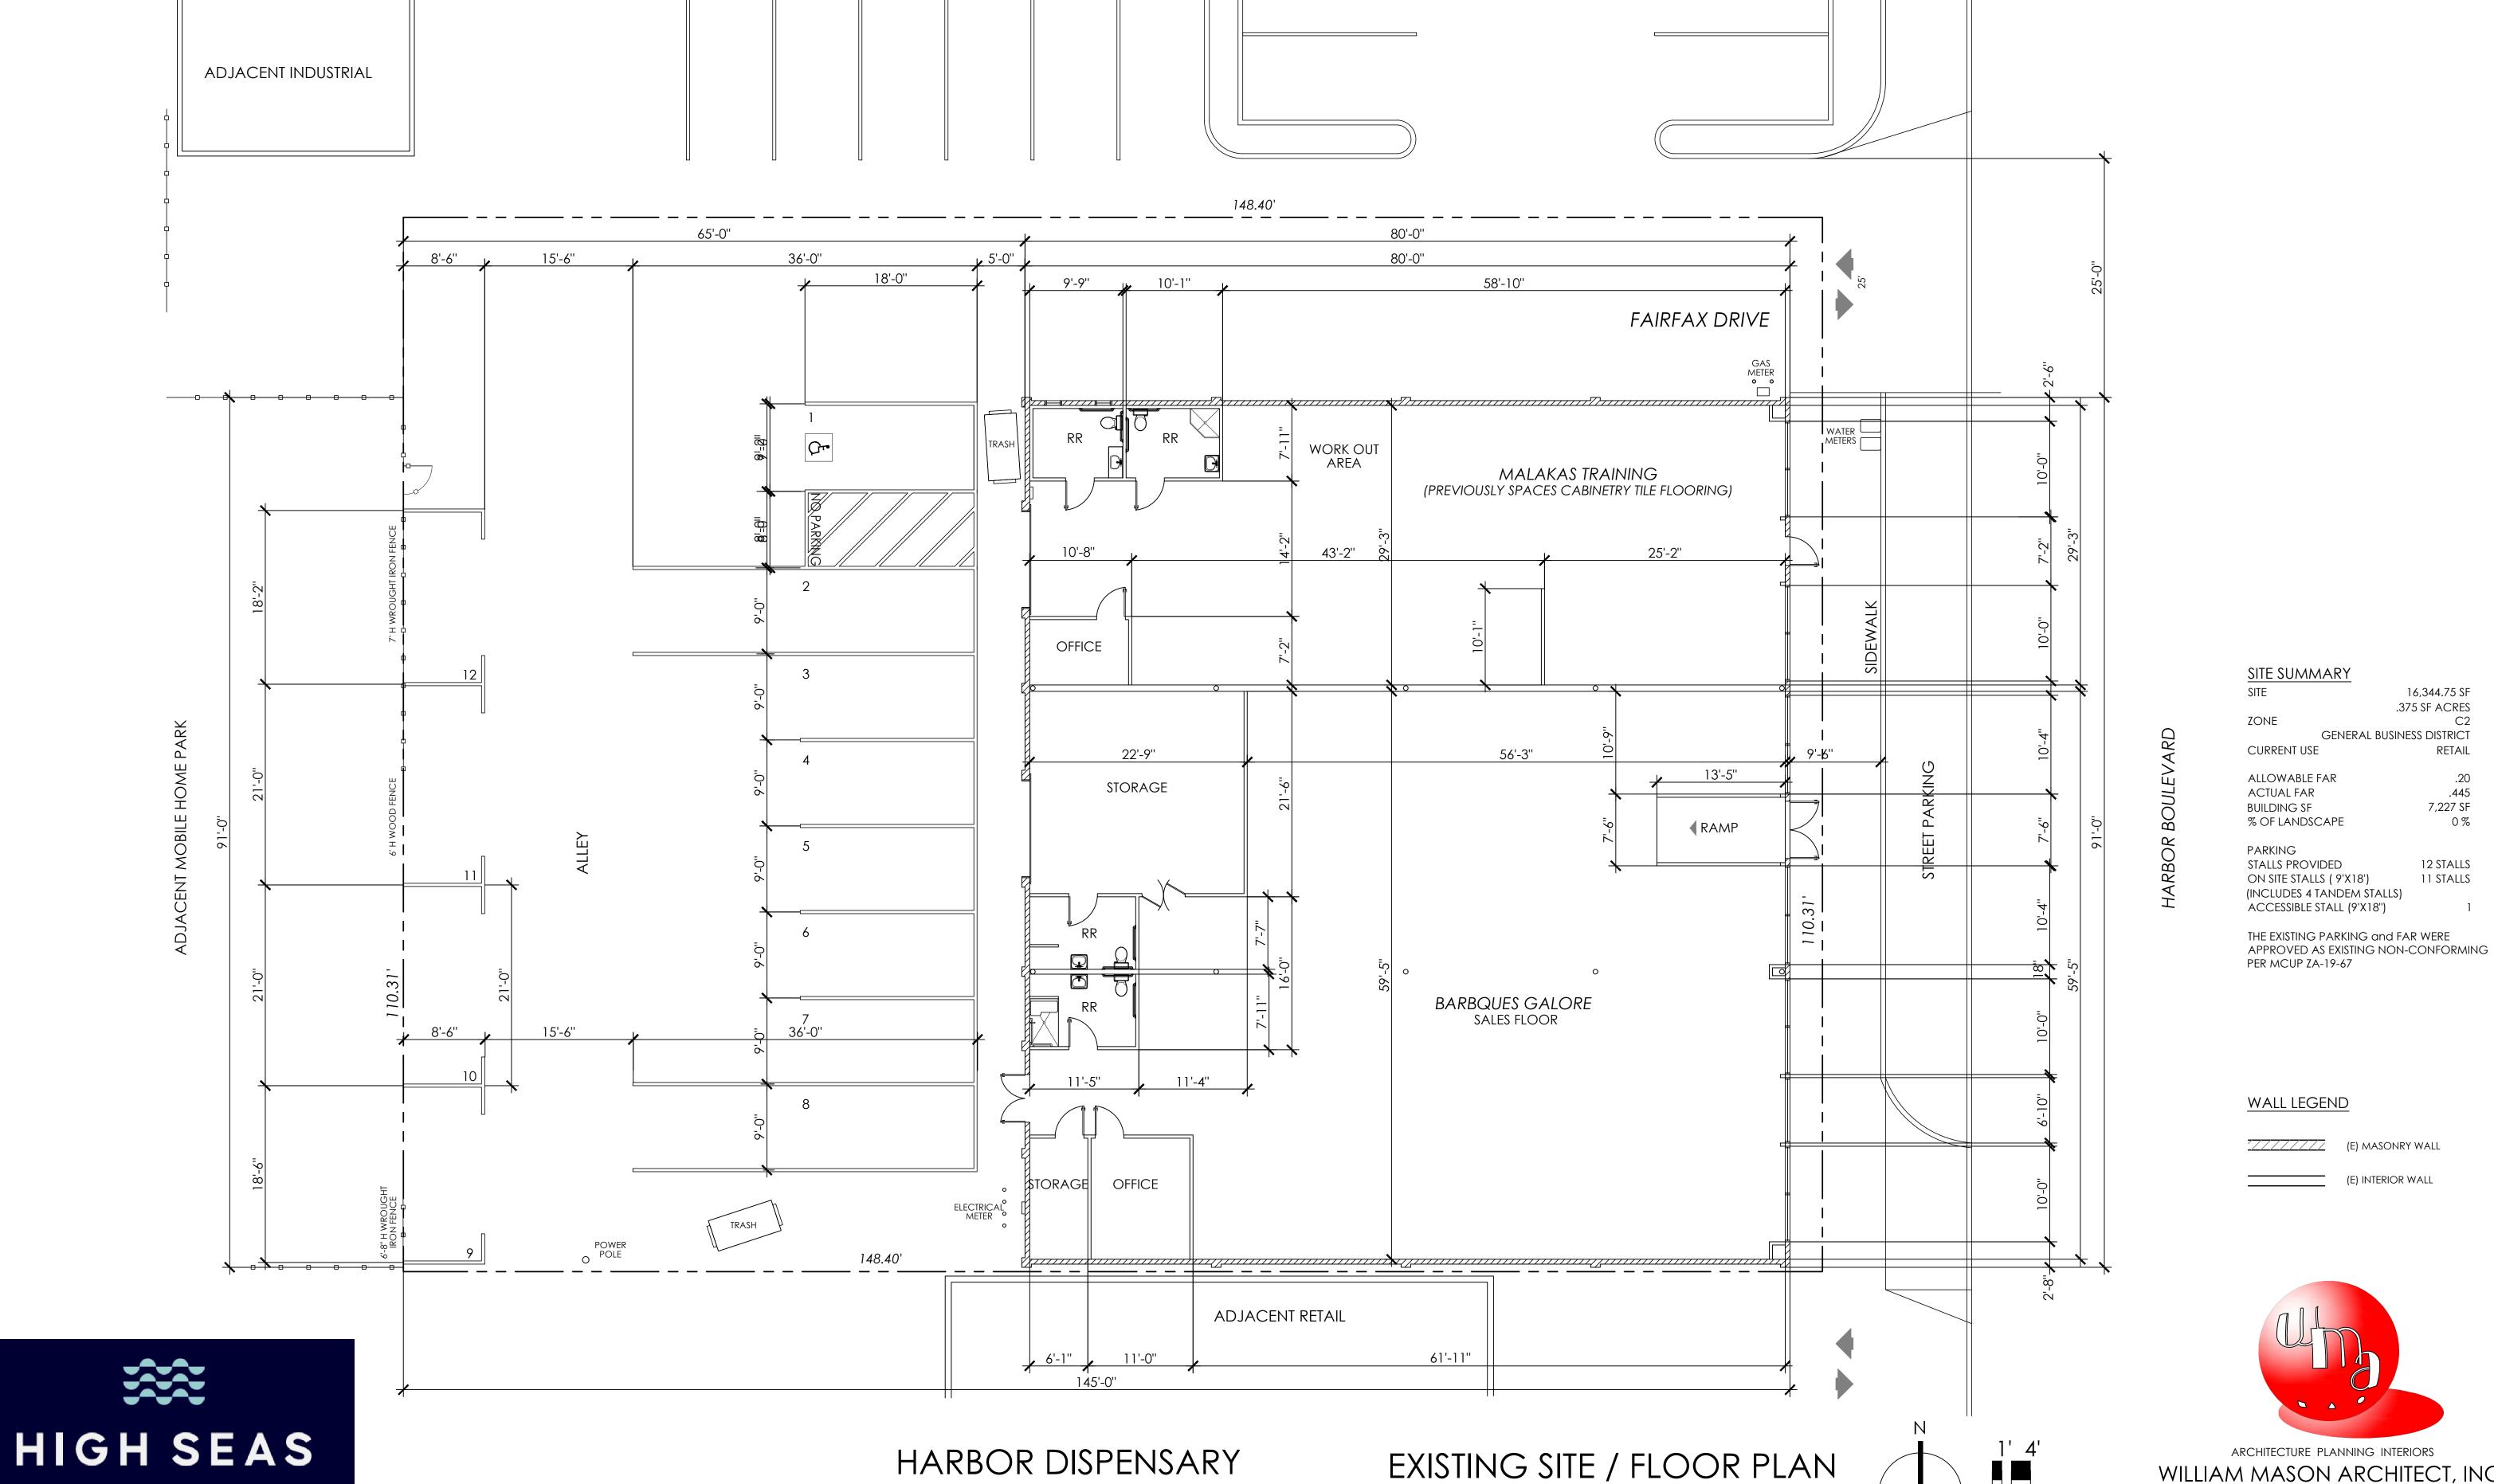

2961 W. MACARTHUR BLDV. STE 209 SANTA ANA, CA. 92704 (949) 400-4110


1921 HARBOR BLVD. COSTA MESA, CA 92627 APN: 422-103-10

ADJACENT RETAIL

SCALE: 1/8"=1'-0"

ARCHITECTURE PLANNING INTERIORS WILLIAM MASON ARCHITECT, INC.


> 824 VIA ALHAMBRA, UNIT D LAGUNA WOODS, CALIFORNIA 92637 C: 714.427.0688 M:714.724.3990
> EMAIL: Bill@WilliamMasonArchitect.com
> 21.041.00 12.14.21
> 12.16.21
> 3.17.22
> 6.20.22

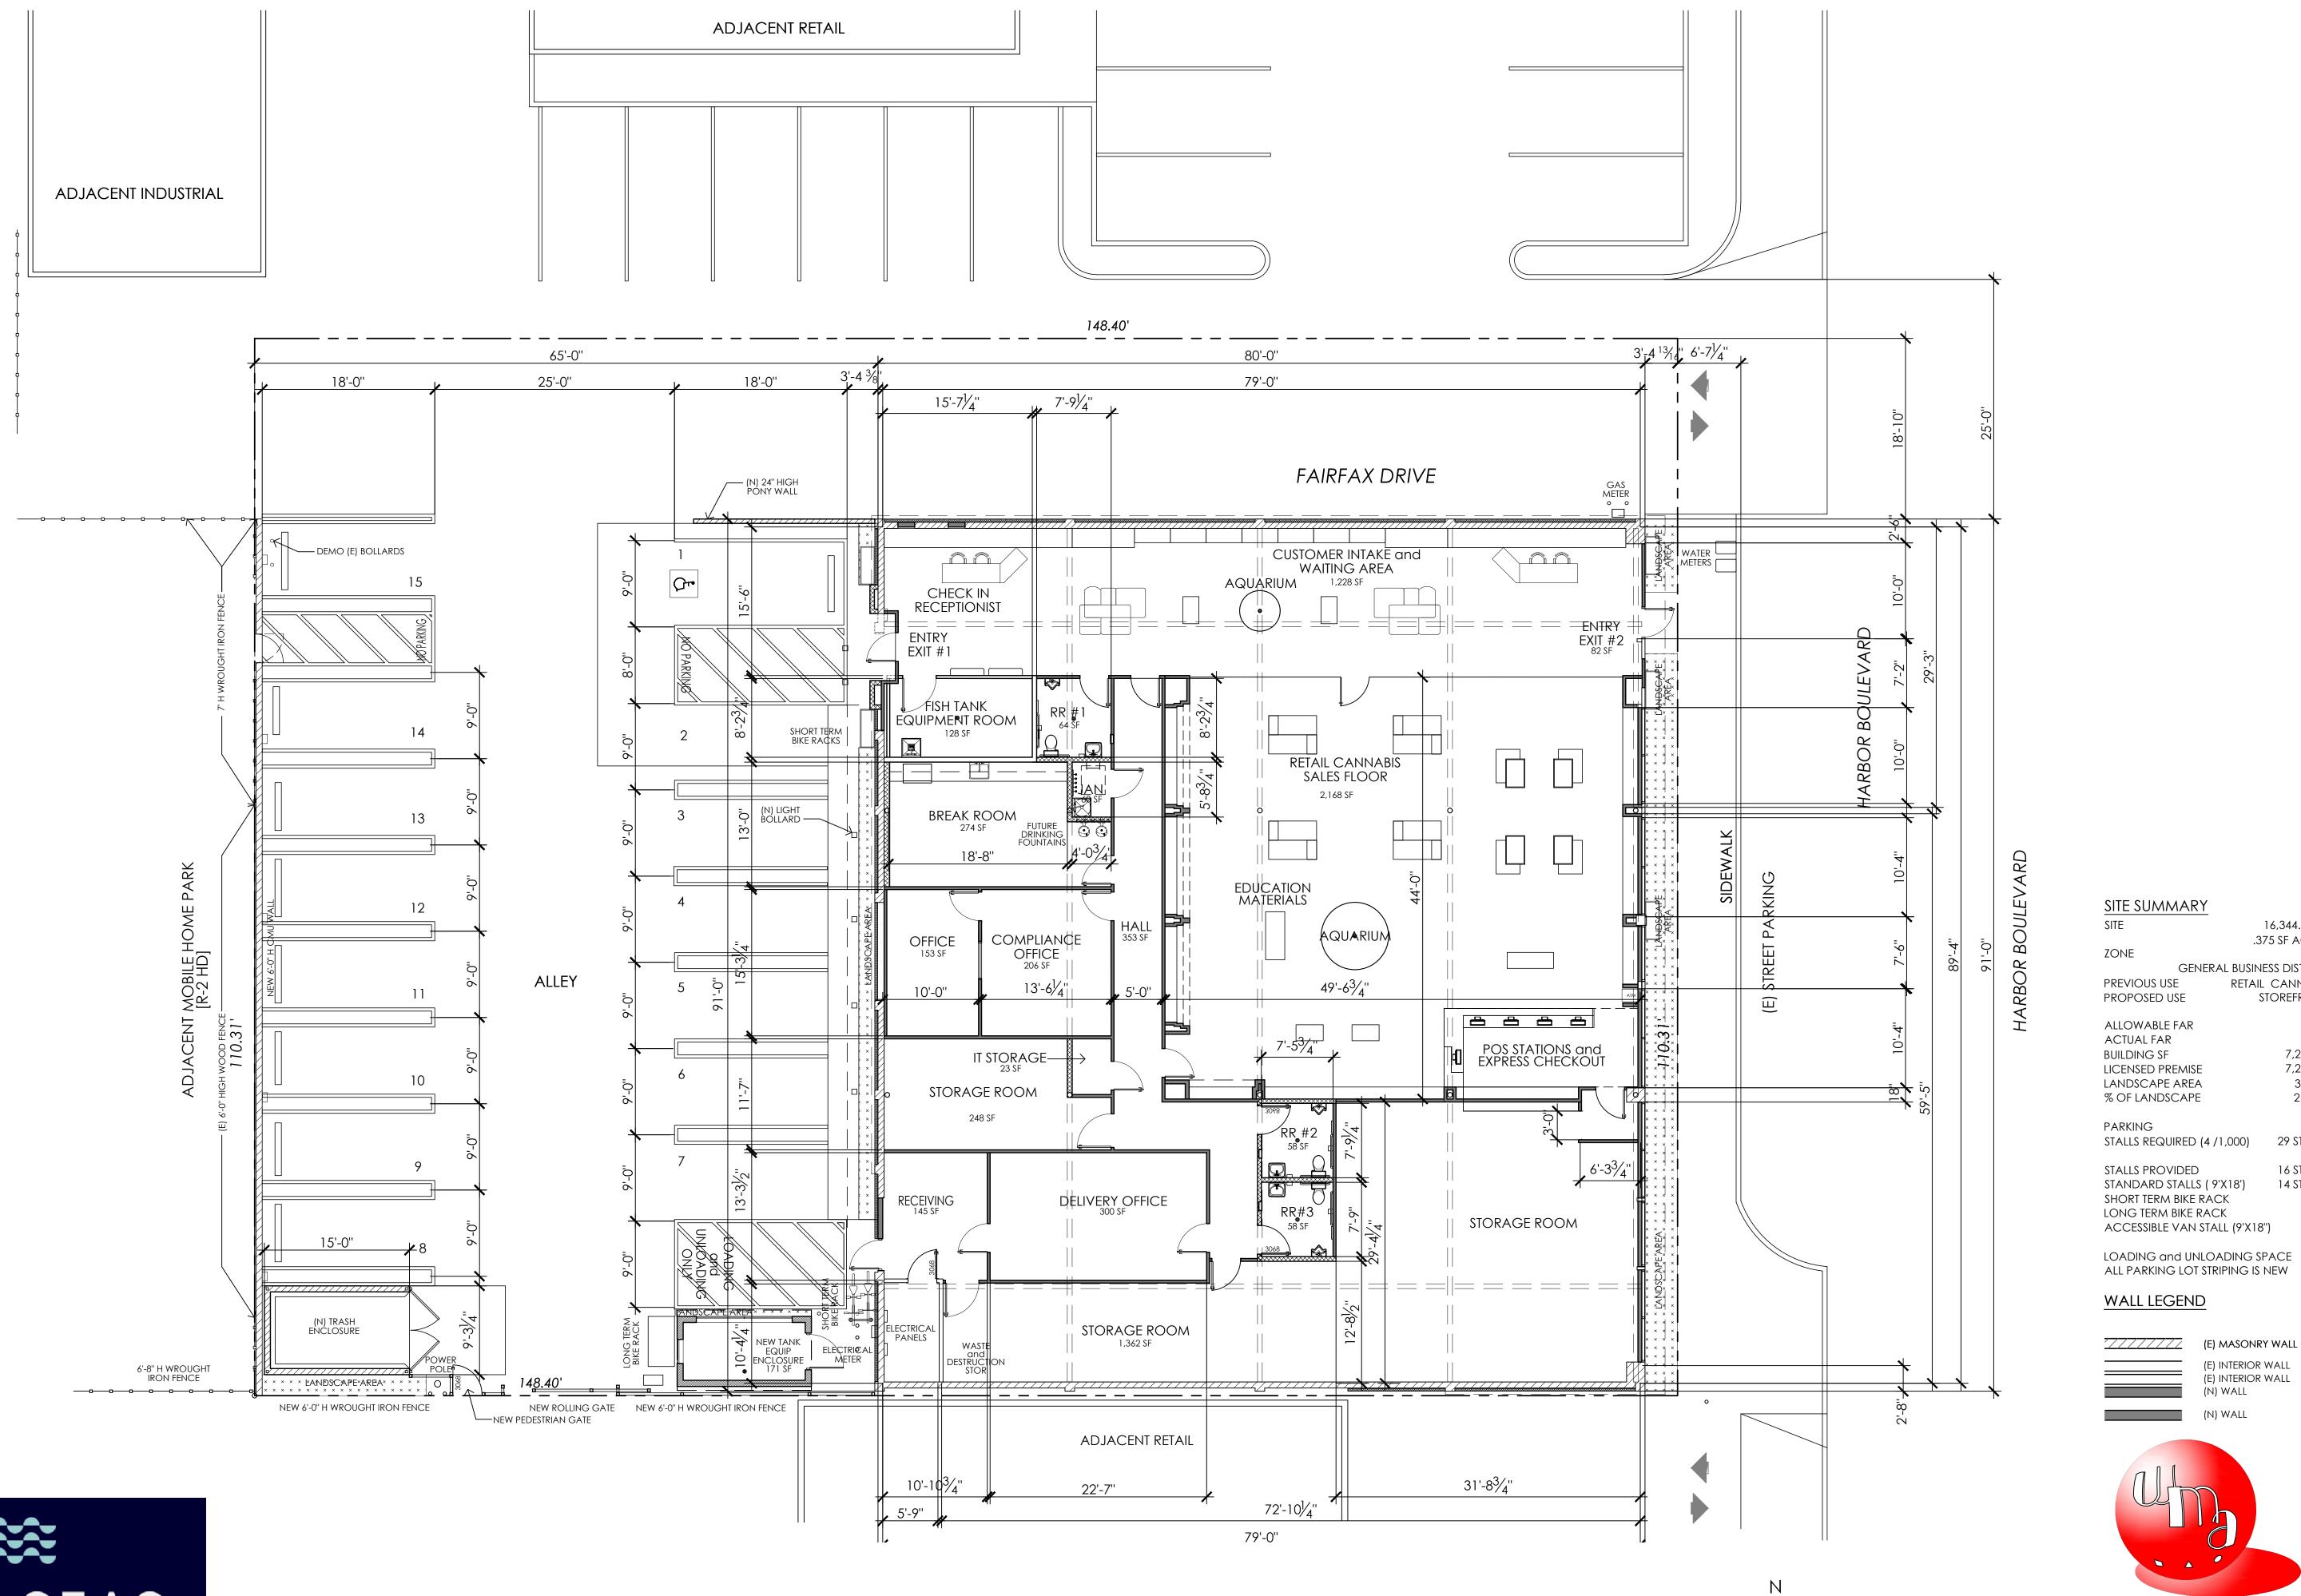



HIGH SEAS DISPENSARY

PROPOSED SITE / FLOOR PLAN

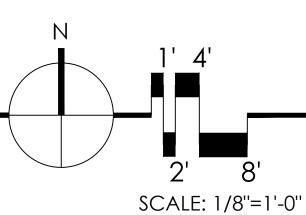

ARCHITECTURE PLANNING INTERIORS WILLIAM MASON ARCHITECT, INC.

.375 SF ACRES

STOREFRONT

.432

7,215 SF

7,215 SF

332 SF

2.03 %

29 STALLS

16 STALLS

14 STALLS

RETAIL CANNABIS

GENERAL BUSINESS DISTRICT

(E) MASONRY WALL


(E) INTERIOR WALL


(N) WALL

(N) WALL

824 VIA ALHAMBRA, UNIT D LAGUNA WOODS, CALIFORNIA 92637 C: 714.427.0688 M:714.724.3990


EMAIL: Bill@WilliamMasonArchitect.com
21.041.00 12.14.21
12.16.21
3.17.22

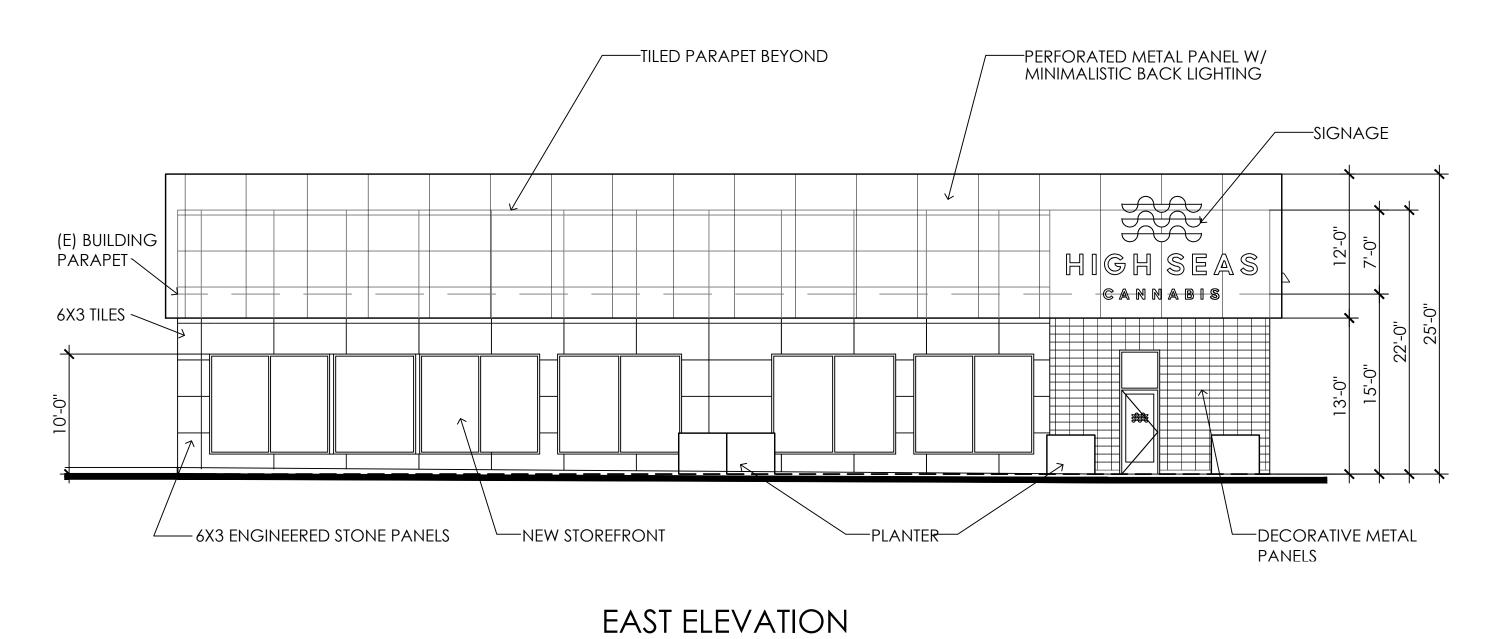


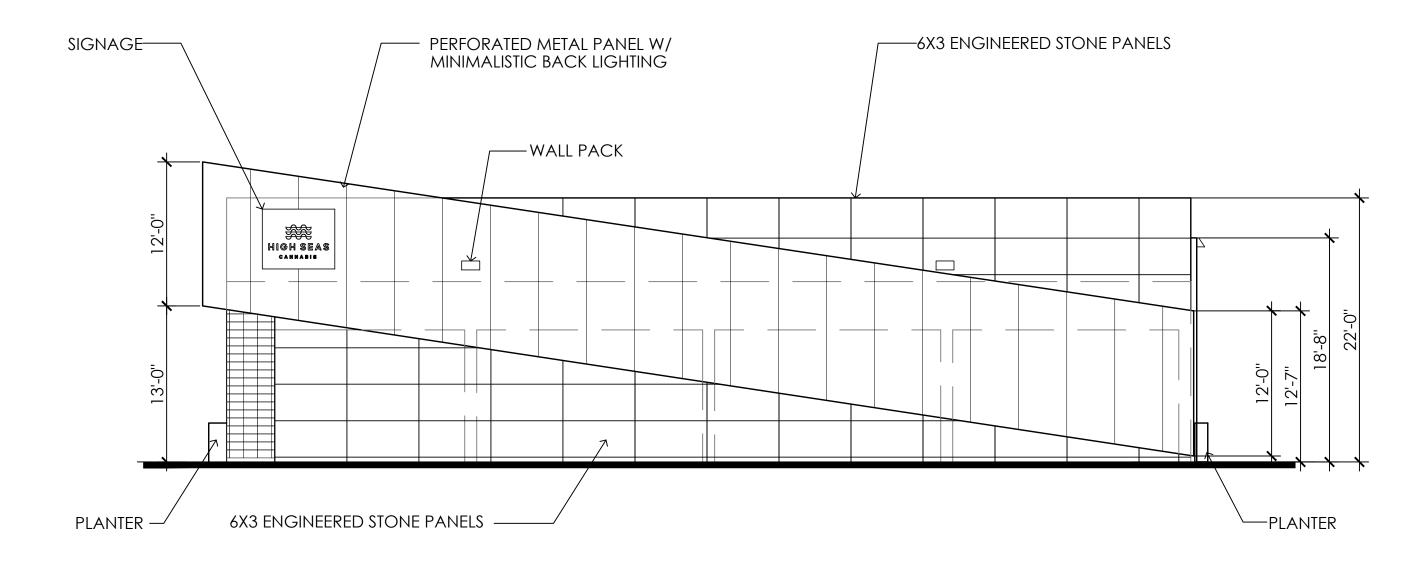

NORTH ELEVATION

NOTE: SIGNS ARE UNDER A SEPARATE PERMIT

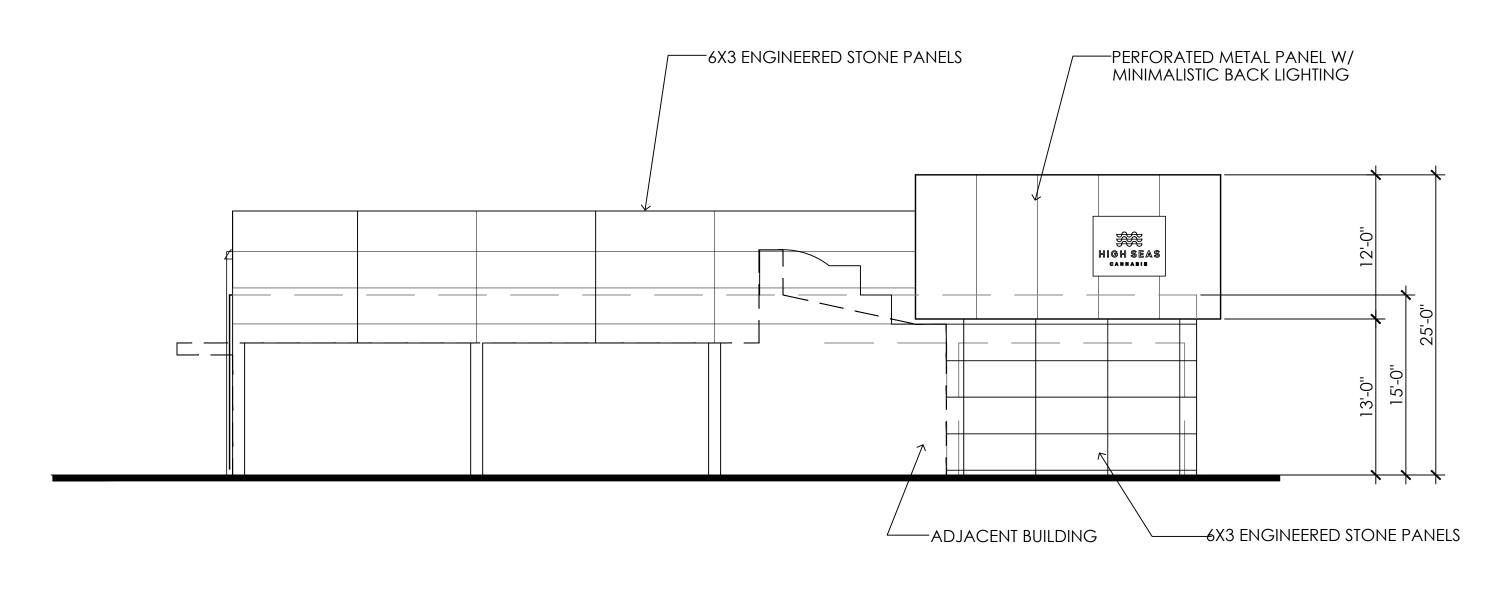


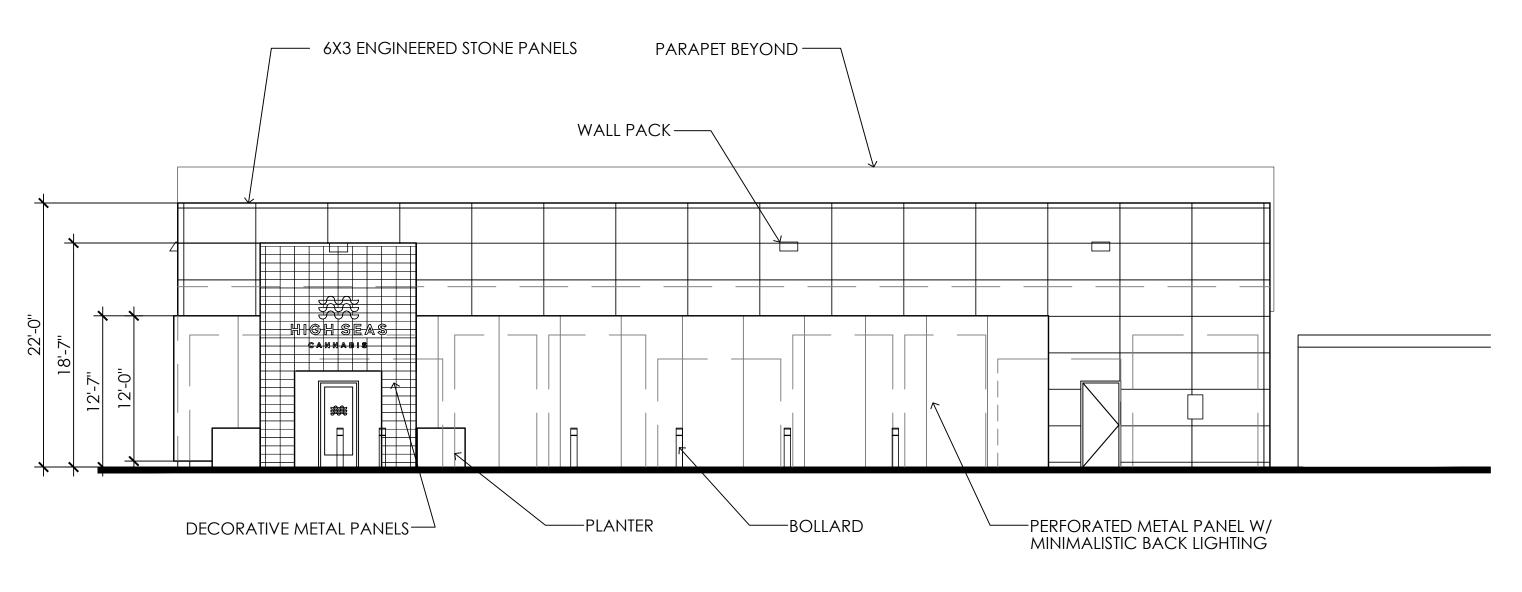


SOUTH ELEVATION WEST ELEVATION



HIGH SEAS DISPENSARY ELEVATIONS

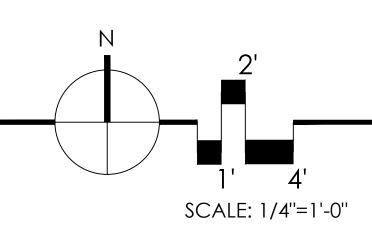



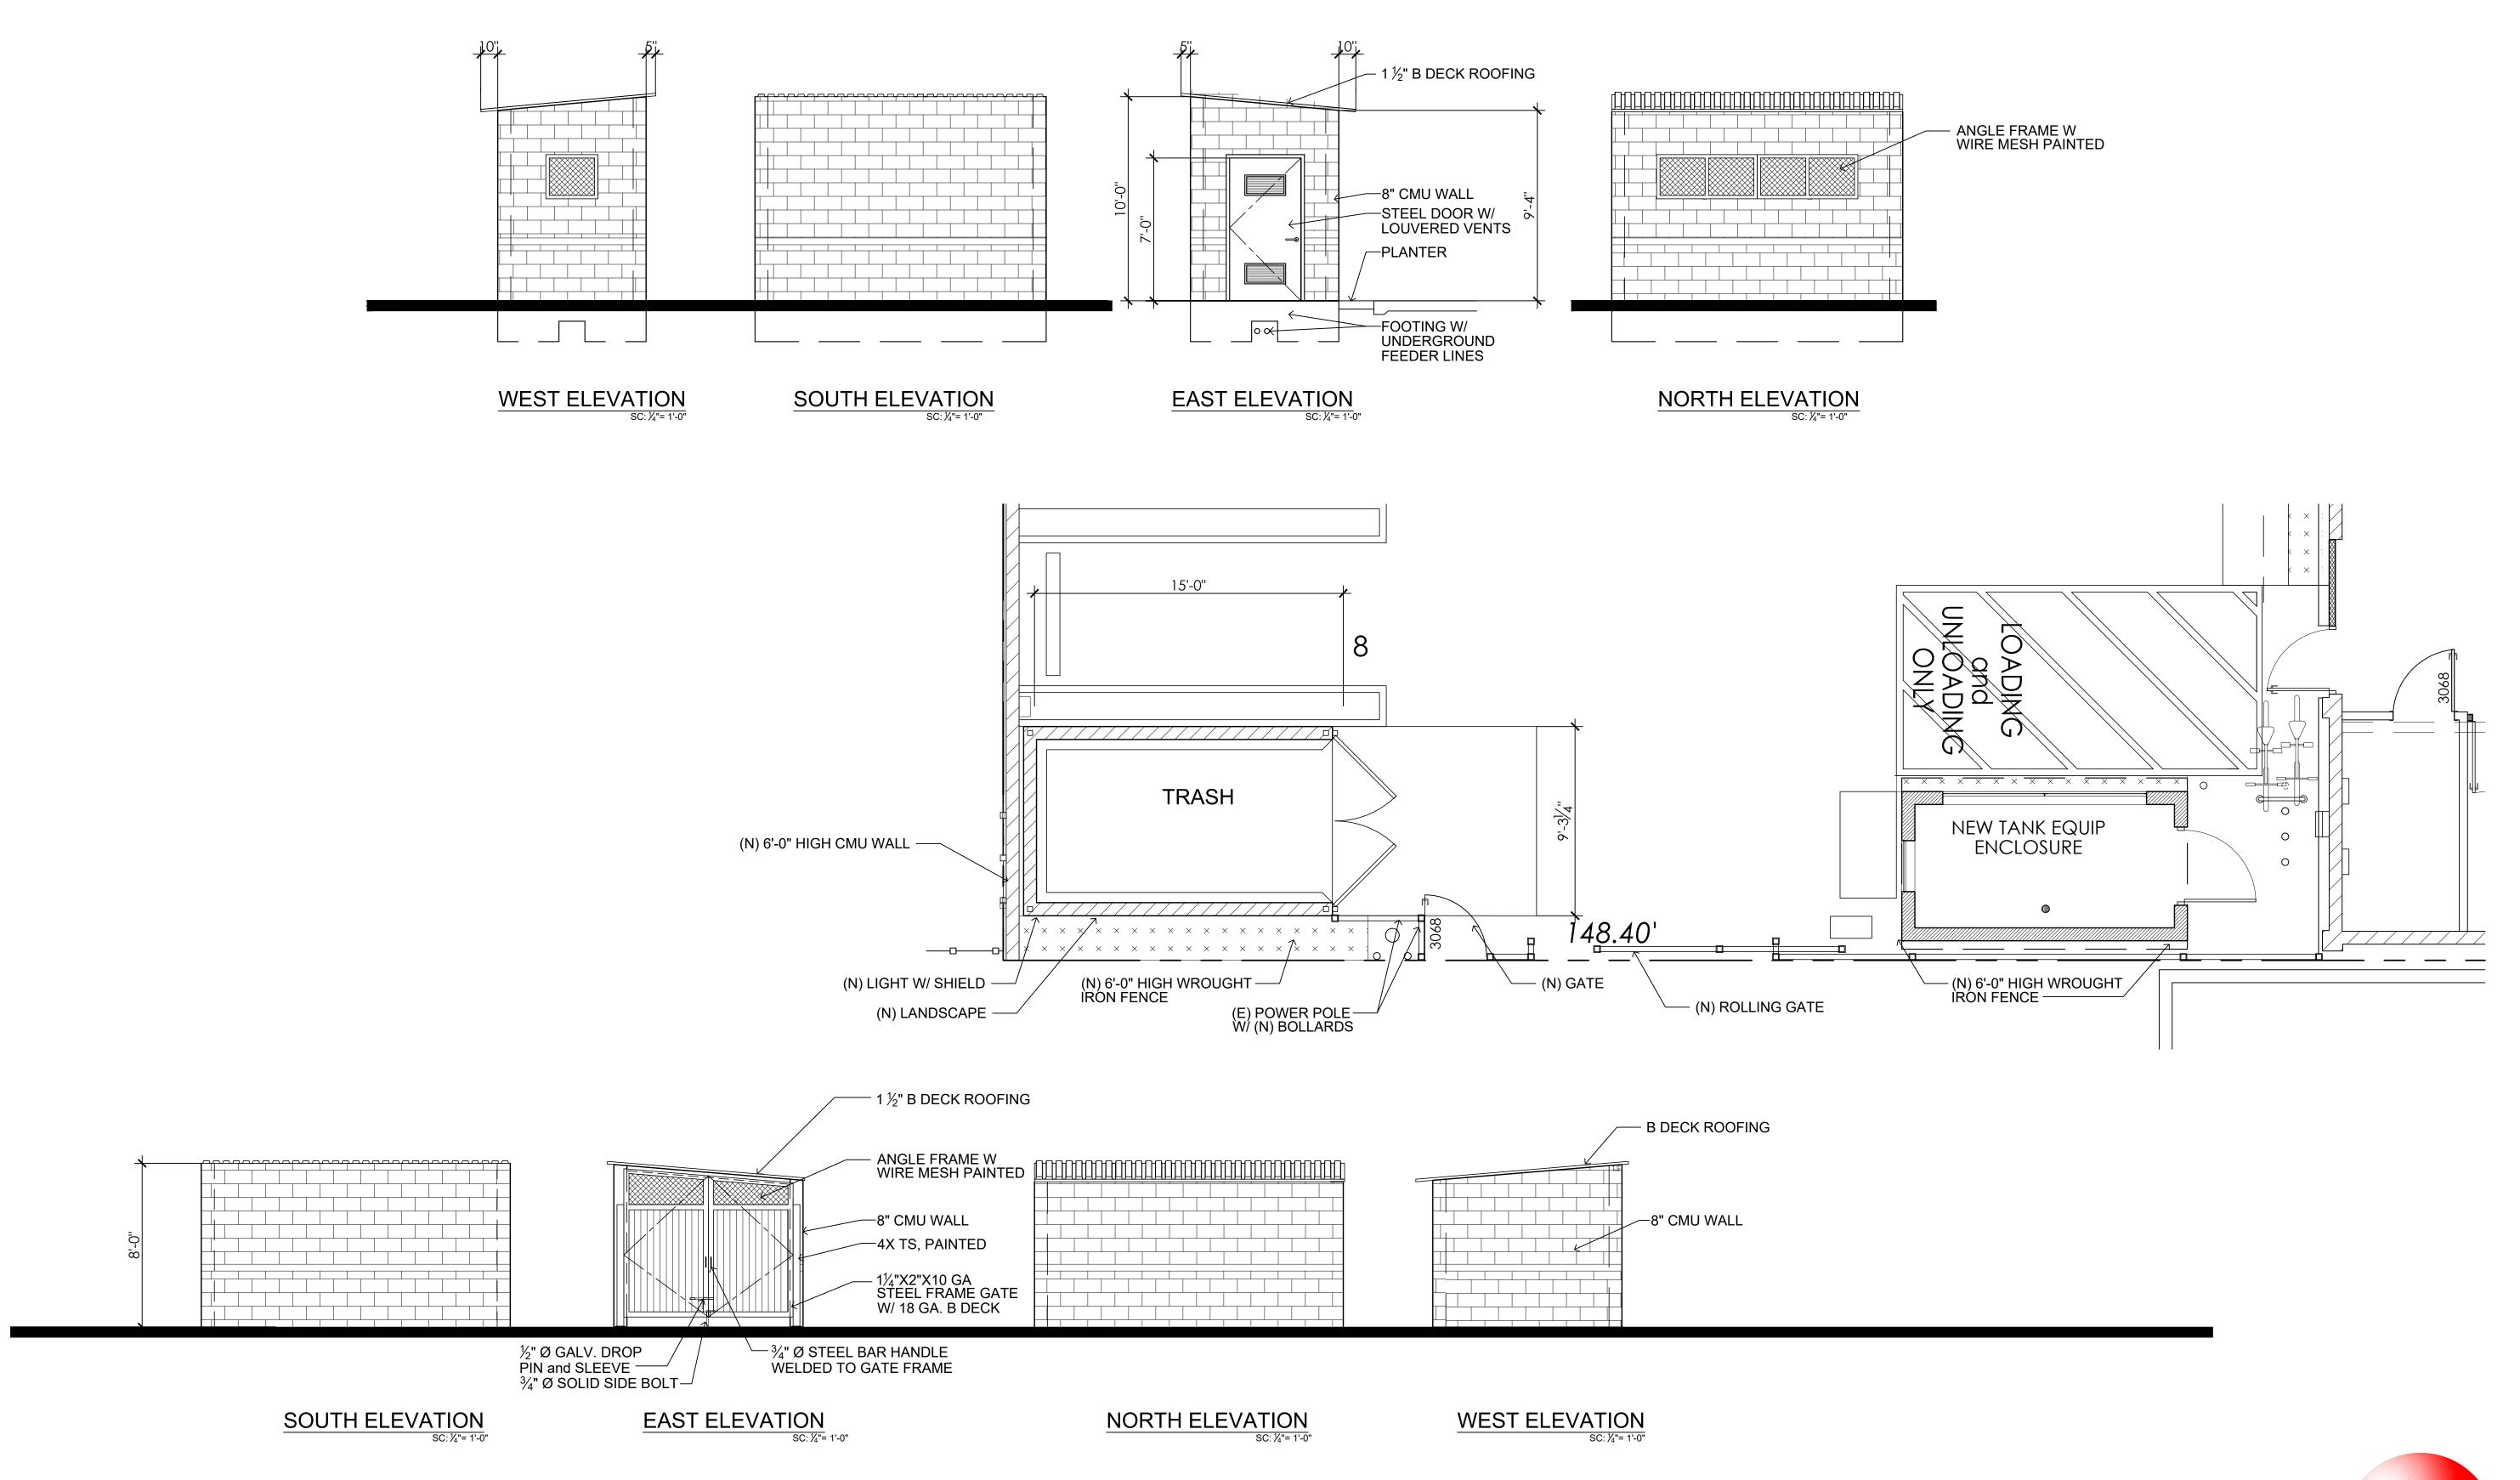





HIGH SEAS DISPENSARY

1921 HARBOR BLVD. COSTA MESA, CA 92627 APN: 422-103-10 AQUARIUM EQUIPMENT ROOM

NEW TRASH ENCLOSURE

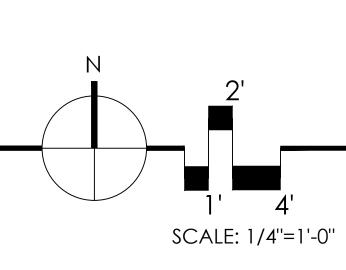



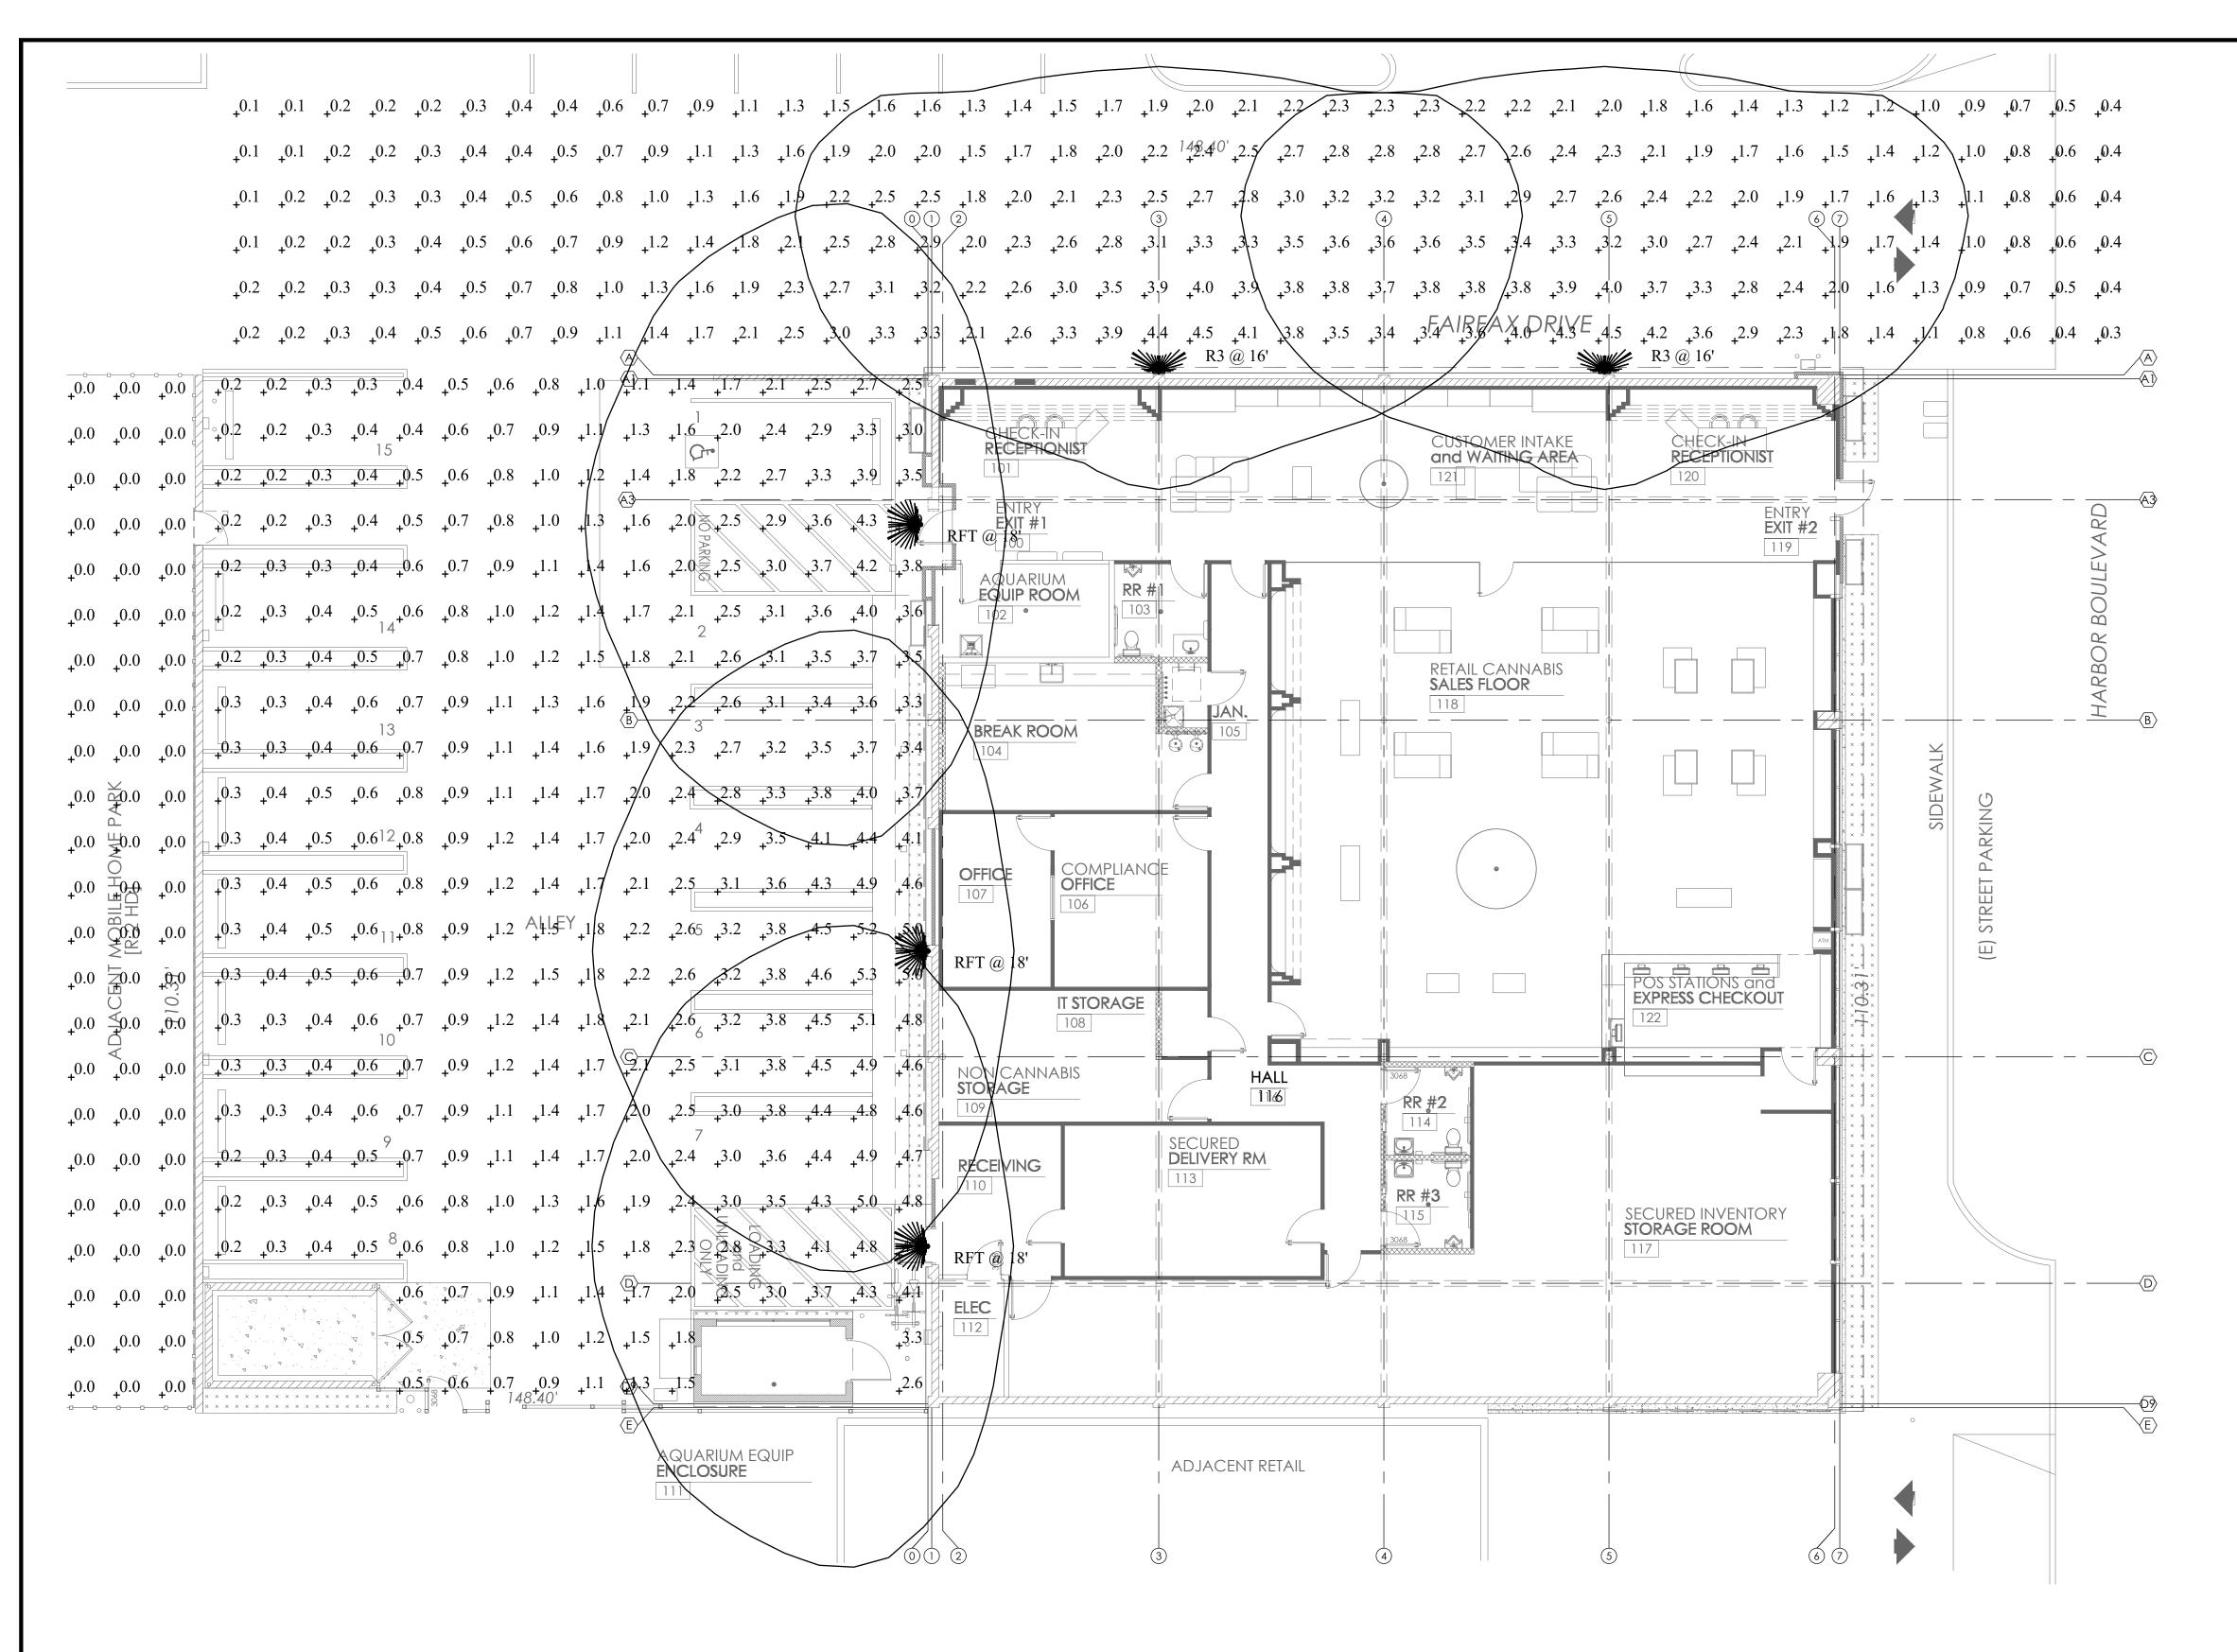

## ELECTRICAL SITE LIGHTING PHOTOMETRIC PLAN

1/8"=1'-0"

Statistics						
Description	Symbol	Avg	Max	Min	Max/Min	Avg/Min
Parking Area	+	1.8 fc	5.3 fc	0.2 fc	26.5:1	9.0:1
SIDE COMMON DRIVEWAY	+	1.8 fc	4.5 fc	0.1 fc	45.0:1	18.0:1

Symbol	Label	Quantity	Manufacturer	Catalog Number	Lumens Per Lamp	Light Loss Factor	Wattage
	R3	2	Lithonia Lighting	WDGE3 LED P1 70CRI R3 30K	6933	0.8	51.1717
	RFT	3	Lithonia Lighting	WDGE3 LED P1 70CRI RFT 30K	6996	0.8	51.1717



Energy Solutions Group, Inc.

Mechanical © Electrical

Plumbing © Energy Design &

Engineering Services

(714) 975-3501 | Rgalaz@mepesg.com P.O. BOX 6390 La Quinta, CA 92248 Website | www.mepesg.com

ARCHITECT'S STAMP



$\triangle$	DATE	REVISION

OWNER:



PROJECT:

TRACT / LOT

## HIGH SEAS MARIJUANA DISPENSARY

1921HARBOR BLVD, COSTA MESA, CA. 92627

PROJECT NO.	21.041.10
SCALE:	AS NOTED
DATE:	2/X/22
DRAWN BY:	
REVIEWED BY:	

ISSUED TO BID:

CHECKED BY:

ISSUED FOR CONSTR:

SHEET TITLE:

# ELECTRICAL SITE LIGHTING PHOTOMETRIC PLAN

SHEET NO.



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Catalog Number	
Notes	
Type  Hit the Tab key or mayor over the page to see all interactive elements.	

lit the Tab key or mouse over the page to see all interactive elements

#### Introduction

The WDGE LED family is designed to meet specifier's every wall-mounted lighting need in a widely accepted shape that blends with any architecture. The clean rectilinear design comes in four sizes with lumen packages ranging from 1,200 to 25,000 lumens, providing a true site-wide solution. Embedded with nLight® AIR wireless controls, the WDGE family provides additional energy savings and code compliance.

WDGE3 has been designed to deliver up to 12,000 lumens through a precision refractive lens with wide distribution, perfect for augmenting the lighting from pole mounted luminaires.

#### **Specifications**

 Depth (D1):
 8"

 Depth (D2):
 1.5"


 Height:
 9"

 Width:
 18"

 Weight:
 19.5 lbs

 (without options)
 19.5 lbs



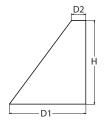

#### **WDGE LED Family Overview**

Luminaire	Standard EM, 0°C	C-14EM 200C	Sensor	Lumens (4000K)									
Luminaire		Cold EM, -20°C		P1	P2	Р3	P4	P5	P6				
WDGE1 LED	4W			1,200	2,000								
WDGE2 LED	10W	18W	Standalone / nLight	1,200	2,000	3,000	4,500	6,000					
WDGE3 LED	WDGE3 LED 15W 18W Standalone / nLight		7,500	8,500	10,000	12,000	-						
WDGE4 LED			Standalone / nLight	12,000	16,000	18,000	20,000	22,000	25,000				

#### **Ordering Information**

#### **EXAMPLE: WDGE3 LED P3 40K 70CRI R3 MVOLT SRM DDBXD**

Series	Package	Color Temperature	CRI	Distribution	Voltage	Mounting				
WDGE3 LED	P1 P2 P3 P4	30K 3000K 40K 4000K 50K 5000K	70CRI 80CRI	R2 Type 2 R3 Type 3 R4 Type 4 RFT Forward Throw	MVOLT 347 <sup>1</sup> 480 <sup>1</sup>	Shipped included  SRM Surface mounting bracket  ICW Indirect Canopy/Ceiling Washer bracket (dry/damp locations only) <sup>4</sup>	AWS 3/8inch Architectural wall spacer  PBBW Surface-mounted back box (top, left, right conduit entry). Use when there is no junction box available.			

Options		,		Finish	
E20WC PE <sup>2</sup> DMG <sup>3</sup> BCE SPD10KV	Emergency battery backup, Certified in CA Title 20 MAEDBS (15W, 5°C min)  Emergency battery backup, Certified in CA Title 20 MAEDBS (18W, -20°C min)  Photocell, Button Type 0-10V dimming wires pulled outside fixture (for use with an external control, ordered separately)  Bottom conduit entry for back box (PBBW). Total of 4 entry points.  10kV Surge pack  Buy America(n) Act Compliant	PIR PIRH PIR1FC3V PIRH1FC3V  Networked So NLTAIR2 PIR NLTAIR2 PIRH	Bi-level (100/35%) motion sensor for 8-15′ mounting heights. Intended for use on switched circuits with external dusk to dawn switching.  Bi-level (100/35%) motion sensor for 15-30′ mounting heights. Intended for use on switched circuits with external dusk to dawn switching  Bi-level (100/35%) motion sensor for 8-15′ mounting heights with photocell pre-programmed for dusk to dawn operation.  Bi-level (100/35%) motion sensor for 15-30′ mounting heights with photocell pre-programmed for dusk to dawn operation.  Pensors/Controls  nLightAIR Wireless enabled bi-level motion/ambient sensor for 8-15′ mounting heights.  nLightAIR Wireless enabled bi-level motion/ambient sensor for 15-30′ mounting heights.	DDBXD DBLXD DNAXD DWHXD DSSXD DDBTXD DBLBXD DNATXD DWHGXD DSSTXD	Dark bronze Black Natural aluminum White Sandstone Textured dark bronze Textured black Textured natural aluminum Textured white Textured sandstone

#### **Accessories**

Ordered and shipped separatel

COMMERCIAL OUTDOOR

WDGEAWS DDBXD WDGE 3/8inch Architectural Wall Spacer (specify finish)
WDGE3/BBW DDBXD U WDGE3 surface-mounted back box (specify finish)

#### NOTES

- 1 347V and 480V not available with E15WH and E20WC.
- 2 PE not available in 480V and with sensors/controls.
- 3 DMG option not available with sensors/controls.
- 4 Not qualified for DLC. Not available with emergency battery backup or sensors/controls



#### **Lumen Output**

Lumen values are from photometric tests performed in accordance with IESNA LM-79-08. Data is considered to be representative of the configurations shown, within the tolerances allowed by Lighting Facts. Contact factory for performance data on any configurations not shown here.

Performance	Custom Watte	Diet Type	30K (3000K, 70 CRI) 40K (4000K, 70 CRI)							50K (5000K, 70 CRI)							
Package	System Watts	Dist. Type	Lumens	LPW	В	U	G	Lumens	LPW	В	U	G	Lumens	LPW	В	U	G
		R2	7,037	136	1	0	1	7,649	148	2	0	1	7,649	148	2	0	1
P1	52W	R3	6,922	134	1	0	2	7,524	145	1	0	2	7,524	145	1	0	2
rı	3200	R4	7,133	138	1	0	2	7,753	150	1	0	2	7,753	150	1	0	2
		RFT	6,985	135	1	0	2	7,592	147	1	0	2	7,592	147	1	0	2
		R2	7,968	135	2	0	1	8,661	147	2	0	1	8,661	147	2	0	1
P2	59W	R3	7,838	133	1	0	2	8,519	144	1	0	2	8,519	144	1	0	2
FZ		R4	8,077	137	1	0	2	8,779	149	1	0	2	8,779	149	1	0	2
		RFT	7,909	134	1	0	2	8,597	146	2	0	2	8,597	146	2	0	2
		R2	9,404	132	2	0	1	10,221	143	2	0	1	10,221	143	2	0	1
P3	71W	R3	9,250	130	2	0	2	10,054	141	2	0	2	10,054	141	2	0	2
13	7100	R4	9,532	134	2	0	2	10,361	145	2	0	2	10,361	145	2	0	2
		RFT	9,334	131	2	0	2	10,146	142	2	0	2	10,146	142	2	0	2
		R2	11,380	129	2	0	1	12,369	140	2	0	1	12,369	140	2	0	1
P4	88W	R3	11,194	127	2	0	2	12,167	138	2	0	2	12,167	138	2	0	2
r <sup>4</sup>		R4	11,535	131	2	0	2	12,538	142	2	0	2	12,538	142	2	0	2
		RFT	11,295	128	2	0	2	12,277	139	2	0	2	12,277	139	2	0	2

#### **Electrical Load**

Performance	Custom Watte	Current (A)									
Package	System Watts	120V	208V	240V	277V	347V	480V				
P1	52W	0.437	0.246	0.213	0.186	0.150	0.110				
P2	59W	0.498	0.287	0.251	0.220	0.175	0.126				
P3	71W	0.598	0.344	0.300	0.262	0.210	0.152				
P4	88W	0.727	0.424	0.373	0.333	0.260	0.190				

#### Lumen Output in Emergency Mode (4000K, 70 CRI)

Option	Dist. Type	Lumens			
	R2	3,185			
E15WH	R3	3,133			
ЕІЭМП	R4	3,229			
	RFT	3,162			
	R2	3,669			
E20WC	R3	3,609			
EZUWC	R4	3,719			
	RFT	3,642			

#### **Lumen Multiplier for 80CRI**

ССТ	Multiplier
30K	0.891
40K	0.906
50K	0.906

#### **Lumen Ambient Temperature (LAT) Multipliers**

Use these factors to determine relative lumen output for average ambient temperatures from 0-40°C (32-104°F).

Ambient		Lumen Multiplier
0°C	32°F	1.05
10°C	50°F	1.03
20°C	68°F	1.01
25°C	77°F	1.00
30°C	86°F	0.99
40°C	104°F	0.97

COMMERCIAL OUTDOOR

#### **Projected LED Lumen Maintenance**

Data references the extrapolated performance projections for the platforms noted in a  $25^{\circ}\text{C}$  ambient, based on 10,000 hours of LED testing (tested per IESNA LM-80-08 and projected per IESNA TM-21-11).


To calculate LLF, use the lumen maintenance factor that corresponds to the desired number of operating hours below. For other lumen maintenance values, contact factory.

Operating Hours	0	25,000	50,000	100,000
Lumen Maintenance Factor	1.0	>0.98	>0.97	>0.92



#### **Photometric Diagrams**

To see complete photometric reports or download .ies files for this product, visit the Lithonia Lighting WDGE LED homepage. Tested in accordance with IESNA LM-79 and LM-80 standards.

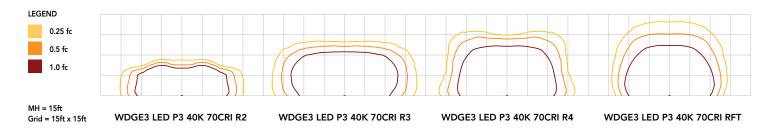

#### **Emergency Egress Options**


#### **Emergency Battery Backup**


The emergency battery backup is integral to the luminaire — no external housing required! This design provides reliable emergency operation while maintaining the aesthetics of the product. All emergency battery backup configurations include an independent secondary driver with an integral relay to immediately detect loss of normal power and automatically energize the luminaire. The emergency battery will power the luminaire for a minimum duration of 90 minutes (maximum duration of three hours) from the time normal power is lost and maintain, minimum of 60% of the light output at the end of 90minutes.


Applicable codes: NFPA 70/NEC - section 700.16, NFPA 101 Life Safety Code Section 7.9


The examples below show illuminance of 1 fc average and 0.1 fc minimum in emergency mode with E15WH or E20WC and R4 distribution.

Grid = 10ft x 10ft

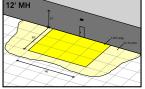

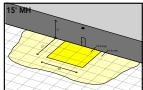

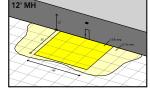

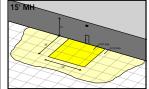

WDGE3 LED xx 40K 70CRI R4 MVOLT E15WH

WDGE3 LED xx 40K 70CRI R4 MVOLT E20WC




#### **Control / Sensor Options**


#### Motion/Ambient Sensor (PIR\_, PIRH\_)

Motion/Ambeint sensor (Sensor Switch MSOD) is integrated into the the luminaire. The sensor provides both Motion and Daylight based dimming of the luminaire. For motion detection, the sensor utilizes 100% Digital Passive Infrared (PIR) technology that is tuned for walking size motion while preventing false tripping from the environment. The integrated photocell enables additional energy savings during daytime periods when there is sufficient daylight. Optimize sensor coverage by either selecting PIR or PIRH option. PIR option comes with a sensor lens that is optimized to provide maximum coverage for mounting heights between 8-15ft, while PIRH is optimized for 15-40ft mounting height.


#### **Networked Control (NLTAIR2)**


nLight® AIR is a wireless lighting controls platform that allows for seamless integration of both indoor and outdoor luminaires. Five-tier security architecture, 900 MHz wireless communication and app (CLAIRITY<sup>TM</sup> Pro) based configurability combined together make nLight® AIR a secure, reliable and easy to use platform.

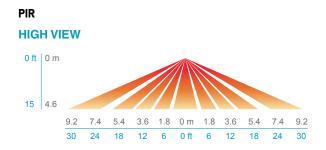

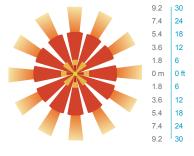

#### **PIRH**

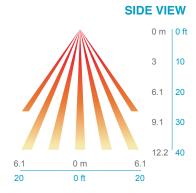

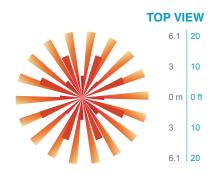

#### **Motion/Ambient Sensor Default Settings**

Option	Dim Level	High Level (when triggered	Photocell Operation	Motion Time Delay	Ramp-down Time	Ramp-up Time
PIR or PIRH	Motion - 3V (37% of full output) Photocell - 0V (turned off)	10V (100% output)	Enabled @ 5fc	5 min	5 min	Motion - 3 sec Photocell - 45 sec
PIR1FC3V, PIRH1FC3V	Motion - 3V (37% of full output) Photocell - 0V (turned off)	10V (100% output)	Enabled @ 1fc	5 min	5 min	Motion - 3 sec Photocell - 45 sec
NLTAIR2 PIR, NLTAIR2 PIRH (out of box)	Motion - 3V (37% of full output) Photocell - 0V (turned off)	10V (100% output)	Enabled @ 5fc	7.5 min	5 min	Motion - 3 sec Photocell - 45 sec



COMMERCIAL OUTDOOR

#### **Mounting, Options & Accessories**



NLTAIR2 PIR - nLight AIR Motion/Ambient Sensor

D = 8"

H = 11"

W = 18"



AWS - 3/8inch Architectural Wall Spacer

D = 0.38"

H = 4.4"

W = 7.5"



PBBW – Surface-Mounted Back Box Use when there is no junction box available.

D = 1.75"

H = 9"

W = 18"

#### **FEATURES & SPECIFICATIONS**

#### INTENDED USE

Common architectural look, with clean rectilinear shape, of the WDGE LED was designed to blend with any type of construction, whether it be tilt-up, frame or brick. Applications include commercial offices, warehouses, hospitals, schools, malls, restaurants, and other commercial buildings.

#### CONSTRUCTION

The single-piece die-cast aluminum housing to optimize thermal transfer from the light engine and promote long life. The driver is mounted in direct contact with the casting for a low operating temperature and long life. The die-cast door frame is fully gasketed with a one-piece solid silicone gasket to keep out moisture and dust, providing an IP65 rating for the luminaire.

#### FINISH

Exterior painted parts are protected by a zinc-infused Super Durable TGIC thermoset powder coat finish that provides superior resistance to corrosion and weathering. A tightly controlled multi-stage process ensures a 3 mils thickness for a finish that can withstand extreme climate changes without cracking or peeling. Standard Super Durable colors include dark bronze, black, natural aluminum, sandstone and white. Available in textured and non-textured finishes.

#### OPTICS

Individually formed acrylic lenses are engineered for superior application efficiency which maximizes the light in the areas where it is most needed. Light engines are available in 3000 K, 4000 K or 5000 K configurations. The WDGE LED has zero uplight and qualifies as a Nighttime Friendly™ product, meaning it is consistent with the LEED® and Green Globes™ criteria for eliminating wasteful uplight.

#### ELECTRICAL

Light engine consists of high-efficacy LEDs mounted to metal-core circuit boards to maximize heat dissipation and promote long life (up to L92/100,000 hours at 25°C). The electronic driver has a power factor of >90%, THD <20%. Luminaire comes with built in 6kV surge protection, which meets a minimum Category C low exposure (per ANSI/IEEE C62.41.2). Fixture ships standard with 0-10v dimmable driver.

#### INSTALLATION

A universal mounting plate with integral mounting support arms allows the fixture to hinge down for easy access while making wiring connections. The 3/8" Architectural Wall Spacer (AWS) can be used to create a floating appearance or to accommodate small imperfections in the wall surface. The ICW option can be used to mount the luminaire inverted for indirect lighting in dry and damp locations. Design can withstand up to a 1.5 G vibration load rating per ANSI C136.31.

#### LISTINGS

CSA certified to U.S. and Canadian standards. Light engines are IP66 rated; luminaire is IP65 rated. PIR options are rated for wet location. Rated for -40°C minimum ambient. DesignLights Consortium® (DLC) Premium qualified product and DLC qualified product. Not all versions of this product may be DLC Premium qualified or DLC qualified. Please check the DLC Qualified Products List at www.designlights.org/QPL to confirm which versions are qualified. International Dark-Sky Association (IDA) Fixture Seal of Approval (FSA) is available for all products on this page utilizing 3000K color temperature and SRM mounting only.

#### **BUY AMERICAN**

Product with the BAA option is assembled in the USA and meets the Buy America(n) government procurement requirements under FAR, DFARS and DOT. Please refer to <a href="https://www.acuitybrands.com/buy-american">www.acuitybrands.com/buy-american</a> for additional information.


#### WARRANTY

5-year limited warranty. This is the only warranty provided and no other statements in this specification sheet create any warranty of any kind. All other express and implied warranties are disclaimed. Complete warranty terms located at:

**Note:** Actual performance may differ as a result of end-user environment and application. All values are design or typical values, measured under laboratory conditions at 25 °C. Specifications subject to change without notice.



## REFERENCE IMAGERY - PLANT MATERIAL (IN-GROUND)

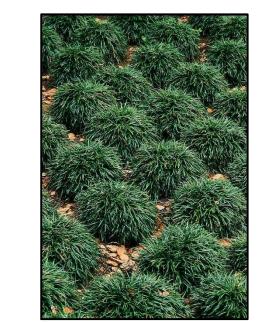

Ophiopogon japonicum -Mondo Grass



Dianella 'Little Rev' -Dwarf Flax Lily



Ficus repens -Creeping Fig

## REFERENCE IMAGERY - PLANT MATERIAL (IN POTS)




Pedilanthus macrocarpus -Lady's Slipper



Sansevieria trifasciata -**Snake Plant** 



Sedum Nussbaumerianum -Sedum

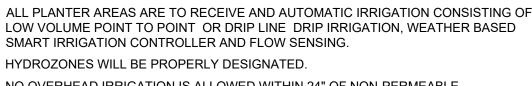

NO OVERHEAD IRRIGATION IS ALLOWED WITHIN 24" OF NON-PERMEABLE SURFACES. SUBSURFACE OR LOW-VOLUME IRRIGATION MUST BE USED FOR IRREGULARLY

SHAPED AREAS, OR AREAS LESS THAN 10 FEET IN WIDTH. ALL POTS TO RECEIVE PERMANENT IRRIGATION TIED TO THE NEW IRRIGATION



**REFERENCE IMAGERY - DECORATIVE POTS** (CARDIFF RECTANGULAR FIBERGLASS POT FROM OLD TOWN FIBERGLASS - MODEL CF481824 - (48" LONG X 18" WIDE X 24" HIGH) COLOR TO BE SELECTED BY ARCHITECT AND OWNER



## PLANT SCHEDULE

<u>SHRUBS</u>	BOTANICAL / COMMON NAME	CONT	<u>PF</u>	<u>QTY</u>	<u>REMARKS</u>
	Dianella revoluta 'DR5000' TM / Little Rev Flax Lily	5 Gal.		32	
	Ophiopogon japonicus / Mondo Grass	1 Gal.	M	96	
<u>VINE</u>	BOTANICAL / COMMON NAME	CONT	<u>PF</u>	QTY	<u>REMARKS</u>
	Ficus repens / Creeping Fig	5 Gal.	М	4	

SYMBOL	DESCRIPTION
S-101	POT A - (3) 5 GALLON SANSEVIERIA TRIFASCIATA WITH AN UNDERSTORY OF 1 GALLOM SEDUM NUSSBAUMERIANUM TO FILL POT
<b>∞</b> <u>S−102</u>	POT B - (3) 5 GALLON SANSEVIERIA TRIFASCIATA WITH AN UNDERSTORY OF 1 GALLOM SEDUM NUSSBAUMERIANUM TO FILL POT
<b>◯</b> S−103	POT C - (3) 5 GALLON PEDILANTHUS MACROCARPUS
<b>◯</b> <u>S−104</u>	POT D - (3) 5 GALLON PEDILANTHUS MACROCARPUS
<b>S</b> -105	POT E - (3) 5 GALLON PEDILANTHUS MACROCARPUS

## **PLANTING NOTES:**

AFTER SOIL HAS BEEN SET IN PLACE & PRIOR TO ANY SOIL PREPARATION, THE CONTRACTOR SHALL FURNISH SOIL TESTS OF THE SITE FOR AGRICULTURAL FERTILITY AND TO DETERMINE PROPER SOIL AMENDMENTS. TEST ARE TO BE PERFORMED BY A MEMBER OF THE CALIFORNIA ASSOCIATION OF AGRICULTURAL LABORATORIES USING ORGANIC FERTILIZER AND SOIL CONDITIONERS DERIVED FROM COMPOSTED HIGHER PLANT FORMS WITH COPIES SENT TO THE OWNER, CITY OF LANDSCAPE ARCHITECT & LANDSCAPE ARCHITECT, PRIOR TO INSTALLATION.

## SOIL PREPARATION

THE FOLLOWING IS PROVIDED FOR BID PURPOSES ONLY AND SHALL BE MODIFIED AS NECESSARY GIVEN THE RESULTS OF THE SOILS TEST. THE CONTRACTOR SHALL BE PREPARED TO PROVIDE DELIVERY SLIPS AND EMPTY FERTILIZER BAGS ON SITE FOR VERIFICATION OF MATERIAL

FOR TURF AND GROUNDCOVER AREAS THE FOLLOWING SHALL BE UNIFORMLY AND THOROUGHLY ROTOTILLED INTO THE SOIL TO A MIN. DEPTH OF 6 INCHES FOR EVERY 1000 SQ. FEET OF AREA. TRI-C ENDO 120

60 LBS/ACRE TRI-C 6-2-4 W / 5% S: 60-70 LBS/1000 SQ.FT SHAVINGS/COMPOST 2-3 CUBIC YARDS/1000 SQ.FT

NOTE: SOIL TESTS SHOULD BE TAKEN FOR MORE SPECIFIC RECOMMENDATIONS AND TO DETERMINE IF ADDITIONAL CORRECTIVE AMENDMENTS ARE NECESSARY.

2. BACKFILL MIX FOR USE OF PLANTING ALL TREES, SHRUBS & VINES

INCORPORATE TRI-C HUMATE @ 5-6 LBS/CU.YD OF BACKFILL MIX

3. PLANT TABLET FOR ALL TREES, SHRUBS, VINES AND GROUNDCOVERS: (22-48) TRI-C MYCO TABS FOR ALL BOX SIZED TREES 24" BOX OR LARGER

(2) TRI-C MYCO TABS PER 1 GALLON STOCK (8) TRI-C MYCO TABS TABLETS PER 5 GALLON STOCK

(16) TRI-C MYCO TABS PER 15 GALLON STOCK

(1) TRI-C MYCO TABS FOR EACH GROUNDCOVER HOLE


INSTALL TRI-C MYCO TABLETS PER MFG. RECOMMENDATIONS **AVAILABLE THROUGH:** 

TRI-C ORGANICS 1-800-927-3311

4. ALL PALM TREES TO BE PLANTED WITH 100% CLEAN PLASTER SAND. REFER TO PALM TREE PLANTING NOTES AND DETAIL FOR FURTHER SPECIFICATIONS.


## TOP DRESSING

ALL SHRUBS AND GROUNDCOVER AREAS ARE TO BE TOP DRESSED WITH 3" THICK LAYER OF LOCALLY COMPOSTED 2" MINUS SHREDDED TREE BARK MULCH OR APPROVED EQUIVALENT. INSTALL MULCH PRIOR TO GROUND COVER PLANTING, INSTALL MULCH 4" DEEP ON SLOPES AND IN PERMANENT PLANT BASINS ON SLOPES.

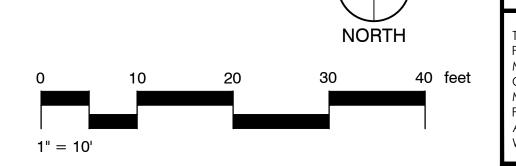



ARCHITECTURE PLANNING INTERIORS WILLIAM MASON, ARCHITECT INC. 824 VIA ALHAMBRA, UNIT D LAGUNA WOODS, CALIFORNIA 92637 M:714.427.0688 O:714.724.3990 EMAIL:Bill@WilliamMasonArchitect.com

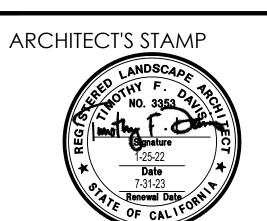

$\triangle$	DATE	REVISION

OWNER:

PROJECT:



1921HARBOR BLVD, COSTA MESA, CA. 92627 TRACT / LOT 21.041.10 PROJECT NO. SCALE: AS NOTED DATE: 2/X/22 DRAWN BY: **REVIEWED BY:** CHECKED BY: ISSUED TO BID: ISSUED FOR CONSTR:

> CONCEPTUAL LANDSCAPE PLAN

SHEET NO.

SHEET TITLE:

L1.0

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MARCH 28, 2022



SCHEMATIC DESIGN PACKAGE

**PROJECT: HIGH SEAS** 

PROJECT LOCATION:

1921 Harbor Blvd. Costa Mesa, CA 92627



























